

Tung Chung Cable Car Project

Landscape Plan

(Revision 1)

June 2006

Mott Connell Ltd
40th floor, Hopewell Centre
183 Queen's Road East
Wanchai
Hong Kong

Tel: 852 2828 5757

Fax: 852 2828 1823

Anne.Kerr@mottconnell.com.hk

List of Contents		Page
Chapters		
1	Introduction	1
	1.1 Objectives of the Landscape Plan	1
	1.2 Regulatory Compliance	1
2	Methodology	2
	2.1 Desktop Assessment	2
	2.2 Site Inspection	2
	2.3 Technical Specification for Landscape and Compensatory Planting	2
3	Review of Baseline Information	3
	3.1 Proposed Mitigation Measures	3
	3.2 Mitigation Measures to be Implemented	3
	3.2.1 Tree transplanting	3
	3.2.2 Tree protection	3
	3.2.3 Topsoil conservation	3
	3.2.4 Replanting	3
	3.2.5 Sensitive Design	3
4	Planting considerations	5
	4.1 Site Analysis	5
	4.2 Erosion and Vegetation Type	5
	4.3 Wind Exposure	6
	4.4 Hill Fires	6
	4.5 Flora Species	6
	4.5.1 Selection of Plants	6
	4.5.2 Multiple Value	6
	4.5.3 Understand Natural Succession	6
	4.5.4 Avoidance of Invasive and Exotic Species	7
	4.6 Habitat Fragmentation/ Corridors	7
5	Technical Specification for Landscape and Compensatory Planting	8
	5.1 Planting Locations	8
	5.2 Sources of Plant Materials	8
	5.3 Planting Species	8
	5.3.1 Planting within the Country Park	8
	5.3.2 Planting Techniques	9
	5.4 Implementation and Maintenance	16

1 INTRODUCTION

The purpose of the Landscape Plan is to provide sensitive detailed design of structures within the Country Park; measures to reduce landscape and visual impacts and to mitigate and compensate the impacts on flora and fauna species and habitats due to the Tung Chung Cable Car Project. The Plan establishes the requirements for chromatic treatments; landscaping and compensatory planting to be undertaken for the Project.

1.1 Objectives of the Landscape Plan

The general objective of the Landscape Plan is to mitigate and compensate landscape and visual and ecological impacts resulting from the construction of Nei Lak Shan Angle Station, towers, emergency rescue trail and helicopter touch down points in accordance with the requirements of the Tung Chung Cable Car Project Environmental Permit No. *EP-177/2003*. In particular, the proposal aims to:

- provide vegetation to form an attractive and functional landscape surrounding structures within the Country Park;
- provide information on transplantation of trees identified in the Tree Survey (Mott Connell, 2003) that are suitable for transplantation;
- provide about 2ha of suitable planting within the Lantau North Country Park or the proposed Lantau North (Extension) Country Park; and
- provide compensatory planting to eventually provide equivalent carrying capacity and ecological functions than existing habitats being replaced or disturbed.

1.2 Regulatory Compliance

The Qualified Ecologist shall obtain all approvals required for compensatory planting.

2 METHODOLOGY

2.1 Desktop Assessment

A review of mitigation measures will be included into this Landscape Plan. The documents of particular importance include:

- Environmental Impact Assessment (EIA) report;
- Environmental Monitoring and Audit (EM&A) Manual;
- Master Landscape Plan; and
- Section 16 Application including the Tree Felling Application.

Reference is made to available maps and aerial photographs including habitat maps from the Tung Chung Cable Car EIA (Mott Connell, 2003) and topographical maps. The following features were identified:

- drainage lines (permanent, intermittent and dry valleys);
- potential erosion features such as rills, gullies and bank erosion etc.;
- existing vegetation cover;
- site characteristics (i.e. aspect, slope, erosion potential etc.) and
- soil type and depth.

2.2 Site Inspection

Site inspection was undertaken to verify the features identified in the desktop assessment and to add additional information on vegetation communities present, potential erosion sources, soil types etc. to determine the requirements for compensatory planting sites.

2.3 Technical Specification for Landscape and Compensatory Planting

Specification of compensatory planting from desktop assessment, site inspection and analysis of site conditions will be included to achieve the stated landscape and visual and compensatory planting objectives.

3 REVIEW OF BASELINE INFORMATION

3.1 Proposed Mitigation Measures

The mitigation measures described below incorporate those landscape and visual mitigation measures already identified in the EIA report; EM&A Manual; Master Landscape Plan and Section 16 Application.

3.2 Mitigation Measures to be Implemented

3.2.1 *Tree transplanting*

The detailed tree survey did not identify any trees to be transplanted as part of the construction works within the Country Park.

3.2.2 *Tree protection*

Trees to be retained within or adjacent to works areas will be carefully protected by strong hoarding and if necessary additional protection to individual tree trunks to avoid damage by machinery. The hoarding will also prevent contractors compacting soil around tree roots or dumping materials.

3.2.3 *Topsoil conservation*

The topsoil layer on proposed development sites is a valuable resource. Any excavation must carefully save and store the topsoil to one side of the works area for reuse upon completion.

3.2.4 *Replanting*

The existing species mix colonising the proposed worksites have been recorded and it is proposed that a complementary mix of indigenous species is specified for replanting at similar densities. It is important that the species selected for replanting is hardy and commercially available.

3.2.5 *Sensitive Design*

Sensitive design of the structures within the Country Park is outlined as below. Details may be referred to the corresponding submissions, Supporting Towers Proposal, Nei Lak Shan Angle Station Proposal, Marker Cable System Proposal, Emergency Rescue Trail Proposal and Helicopter Touch Down Points Proposal.

Towers: The steel structure of the towers will have a hot-dipped galvanized coating. Its appearance will be similar to the existing CLP's overhead line towers. Reinstatement of the existing ground profile and vegetation beneath and around the towers is considered to be the best landscape mitigation in minimizing the potential visual impact. The areas around the tower footings will be properly landscaped. Hydroseeding will be carried out and native woodland species mix will be planted for screening the footings.

Nei Lak Shan Angle Station: The most significant surfaces of the angle station will adopt a palette of recessive 'camouflage' colours, which will allow it to better blend with the varying colours of Lantau hills – green in wet season and yellow-brown in dry season, in order to achieve visual integration with the surrounding terrain. The major objective of the landscape strategy is to retain as much of the existing vegetation as possible and reinstating disturbed areas caused by the construction. Replanting of native species will be carried out at the angle station. Climber will be added surrounding the supporting columns to visually soften the vertical concrete base of the structure.

Marker cable anchor structures: To minimize the visual impact, the anchors will be treated with visually recessive colour and all the temporary works areas will be reinstated to the original profile upon completion of the works. Replanting of native species will be carried out at both anchor locations.

Emergency rescue trail: The emergency rescue trail will include newly formed sections which traverse most length of the cableway and an upgraded country park trail between Ngong Ping and Tower 6. Generally speaking, boardwalk will be provided for trail sections with rock ground while stone paving will be applied to those with soil ground. CCA treated timber will be used for the construction of boardwalk. Excavated rocks and soil materials will be reused where possible to construct the stone paved trail to maximise the opportunity for materials reuse and thereby negate the disposal requirements. The planting strategy of the emergency rescue trail is to use native tree and shrub species and plant in irregular fashion along the alignment to help screen any visual impact the works may result.

Helicopter touch down points: The helicopter touch down points are to provide a safe landing surface for emergency rescue. The areas will be retained as grass surface as far as possible.

4 PLANTING CONSIDERATIONS

4.1 Site Analysis

A number of factors were considered for analysis of compensatory planting sites:

- Physiology: The influence of landform on vegetation growth potential. Establishment of plants on steep slopes, spurs or ridges is considered more difficult. Any clearance of vegetation (i.e. grasses) may result in soil erosion.
- Soil Type: The soil type varies in areas of the Country Park:
- Alluvial Soils (medium to high fertility);
 - Granitic Soils (low fertility, normally easily eroded particularly on steep slopes);
 - Volcanic Soils (low fertility with moderate to low erosion potential).
- Slope: Steep slopes are more quickly drained, easily eroded and more difficult to plant.
- Altitude: Sites of higher altitude are generally more exposed and therefore vegetation is more difficult to establish.
- Aspect: In Hong Kong, slopes with a northern aspect normally have a high growth potential than those with a southern aspect.
- Existing Vegetation: Planting should aim to provide suitable vegetation aimed at restoring ecosystem function. Areas which are prone to fire damage should be supplemented with more fire-resistant shrubs and ground cover species.
- Growth Potential: The vegetation growth potential of a site is dictated by a combination of the factors outlined above.

4.2 Erosion and Vegetation Type

The role of vegetation in reducing erosion has been well documented. Vegetation cover helps to break the impact of falling rain drops and hence reduces the erosive force of the raindrops. The roots of trees also play an important role in reducing erosion and site stability by binding soil mantles to sub-soils or substrata thus contributing to the mechanical strength of the soil.

Erosion on slopes takes place when one or more of the following conditions exist:

- the slope length is long;
- the slope is steep,
- the soil is highly erodible; and
- the soil cover (vegetation) has been removed and will take some time to re-establish.

4.3 Wind Exposure

Growth retardation to plants on exposed ridgelines, hilltops and spurs which may lead to soil erosion. Soil erosion at some exposed sites occurs quicker than the plant establishment and it has been observed that only a few species establish with any degree of success.

4.4 Hill Fires

A number of areas within the Lantau North Country Park and the proposed Lantau North (Extension) Country Park show signs of hill fire. Consideration of hill fires is important in planning of locations of compensatory planting and selection of species.

4.5 Flora Species

4.5.1 Selection of Plants

Native trees are important elements of the Hong Kong ecosystem. Compared with exotic species, native trees have significantly higher ecological value in providing food and shelter for local wildlife. The compensation planting will avoid monoculture plantation which may provide ineffective soil and water protection, poor in nutrient recycling and enrichment, low in biodiversity and susceptible to pest attack. Natives species are anticipated to require less care than non-native plants and will be suited to provide appropriate habitat for native wildlife.

A mixture of plants have been selected to provide more diverse habitat and a prolonged and varied leaf fall to meet the energy and pupation needs of aquatic insects. It will also help avoid trouble with pests that attack specific plants. Deciduous plants will be selected as the leaf litter is important for trapping nitrogen.

4.5.2 Multiple Value

Species will be selected for multiple use such as erosion control, attraction of fauna (i.e. nuts, fruit, browse, and nesting) and aesthetics including seasonal foliage color, flowers, fruits, and branching habit. Generally, native perennials provide blooms that attract butterflies while berry-bearing shrubs attract birds.

4.5.3 Understand Natural Succession

Seedling performances are highly variable between species and sites. Hau B., So K., (2002) (Department of Ecology and Biodiversity, The University of Hong Kong, and the Kadoorie Farm and Botanic Garden) found that 'a higher number of the native tree species showing early successional characters performed better on the exposed and eroded hillsides, such as *Schefflera octophylla*, *Mallotus paniculatus*, and *Zanthoxylum avicennae*. While other early successional species performed badly, such as *Sapium discolor*. However, some late successional species also performed very well on the exposed hillsides, e.g. *Cyclobalanopsis neglecta*, *C. edithiae*, and *Syzygium hancei*. Other late successional species performed very badly, such as *Pygeum topengii*.

The preliminary results of planting trials have indicated that native shrubs are able to do very well even in very poor soil and on 55 degree cut slope surfaces. The succession pathway from

shrubland to forest should be given more consideration and the first step of forest restoration projects may start with shrubs, followed by reinforcement with trees at a later stage. Plant communities naturally change over time. Pioneer species adapted to bare soils and lots of light are gradually replaced by longer-lived species that can grow and reproduce under more shaded and protected conditions.

4.5.4 *Avoidance of Invasive and Exotic Species*

Exotic (and some invasive species) are commonly used in tree planting in Hong Kong, including species listed by the Invasive Species Specialist Group (ISSG) of IUCN (i.e. "One Hundred of the World's Worst Invasive Alien Species" identified by ISSG of IUCN (<http://www.issg.org/database/welcome/>)). Potentially invasive species are not recommended.

4.6 *Habitat Fragmentation/ Corridors*

Fragment of habitat generally supports smaller populations of fauna and is a key factor in the loss of biodiversity. A technique to help increase connectivity for fragmented habitat includes creating corridors. A wildlife corridor is a continuous natural protected pathway along which native wildlife species can move in between natural habitat. The scientific literature suggests that corridors:

- recolonize isolated habitat areas;
- link smaller habitat areas to larger functional units that meet habitat needs which are not met by individual patches individually;
- facilitate migratory movement; and
- facilitate gene flow across the landscape.

Where possible compensatory planting will aim to reduce habitat fragmentation and incorporate corridors.

5 TECHNICAL SPECIFICATION FOR LANDSCAPE AND COMPENSATORY PLANTING

5.1 Planting Locations

The location of the 2ha of compensatory planting within Lantau North Country Park is shown in **Figure 5.1**.

Landscape planting at Towers 3 to 7, Nei Lak Shan Angle Station, marker cable anchor structures, emergency rescue trail and helicopter touch down points is shown in **Drawing Nos. LP-T-04, LP-R-01 to 24, LP-R-29 to 30**, and, the plant schedule is listed in **Drawing No. LP-101**. Planting in the Country Park will be entirely native to keep with the local vegetation. The layout of plants will take into account surrounding environment and vegetation.

5.2 Sources of Plant Materials

Plants will be planted from nursery-grown tube stock. Potted seedlings may be available from Kadoorie Farm, AFCD or from various nurseries in Hong Kong. Where possible local nursery grown tube stock should be used to prevent the spread of plant disease.

5.3 Planting Species

The plants selected for compensatory planting listed in **Table 5.1** are based on planting considered outlined in **Section 4** of this report.

5.3.1 Planting within the Country Park

Native tree and shrub species shall be planted on areas shown in **Figure 5.1**. The tree and shrub spacing recommended is approximately 1.5m apart, which will result in a dense buffer at maturity, assuming that all plants survive. The total number of trees required to be planting using this spacing will be approximately 9000 seedlings to be planted within the 2ha area.

Table 5.1: Compensatory Planting Species List (Revised)

Form	Species	Plant Size	Location
Tree	<i>Schefflera heptaphylla</i>	Seedling	Country Park
Tree	<i>Mallotus paniculatus</i>	Seedling	Country Park
Tree	<i>Sapium discolor</i>	Seedling	Country Park
Tree	<i>Sapium sebiferum</i>	Seedling	Country Park
Tree	<i>Castanopsis fissa</i>	Seedling	Country Park
Tree	<i>Liquidambar formosana</i>	Seedling	Country Park
Tree	<i>Machilus chekiangensis</i>	Seedling	Country Park
Tree	<i>Sterculia lanceolata</i>	Seedling	Country Park
Tree	<i>Schima superba</i>	Seedling	Country Park
Shrub or small tree	<i>Gordonia axillaris</i>	Seedling	Country Park

5.3.2 *Planting Techniques*

The techniques for planting and technical specifications are provided in **Table 5.2** which shall apply to compensatory planting within the Lantau North Country Park.

Table 5.1: Specification for Planting

Earthworks and Soiling

Materials

25.01	(d)	Top soil, the fertile layer immediately below undisturbed vegetation, to be free draining material of a sandy loam character free from grass or weed growth of any kind, other foreign material or stoned exceeding 50mm diameter.	Top soil
25.01	(e)	Soil-mix shall consist of friable, completely decomposed granite and soil conditioner in the proportions 3:1 by volume. Soil-mix shall be free from grass or weed growth, sticky clays, slat, stones exceeding 50mm diameter ad other deleterious material.	Soil Mix
25.01	(g)	Soil conditioner to be properly composted organic material free from impurities and containing no substance harmful to plants and to be of a fine freely flowing consistency. pH factor to be 6.5-7.5, moisture content 30-70% with a carbon nitrogen ratio between 20-30.	Soil Conditioner
25.02	(f)	Preplanting / slow release fertiliser to be an approved granular slow release compound comprising Nitrogen (N) Phosphorus (P) and Potassium (K) and trace elements in the ratio 15:9:15:2	Preplanting / Slow Release Fertiliser

Workmanship

25.04	(a)	Clear away weeds, rubbish, litter and all deleterious material from the surface of the ground.	Clearing Ground
-------	-----	--	-----------------

Planting – General

Materials

25.12	(a)	All plants, seeds etc. shall be true to species; plants shall be healthy and with the habit and size of the plant as specified. Plants and seeds shall be free from pests, diseases, parasites, discoloration and damage. All plants shall be obtained from an approved cultivated source and not from the wild (unless translocation has been specified)..	Plants
-------	-----	---	--------

- | | | |
|-------|---|---------------------------|
| | (b) All plants shall have a vigorous fibrous root system, and have a well developed shape for the species as specified. | Plant Habit |
| | (c) In the event of there being a discrepancy between the botanical name, English common name, and the Chinese common names as specified, the botanical name shall prevail. | Plant name |
| 25.13 | Parasitic plants shall not be present in any form on any plant or soil brought to the Site. Plants and soil found to be affected by parasitic plants shall be removed from Site and destroyed. | Parasitic Plants |
| 25.14 | Containers shall be rigid or semi-rigid receptacles with drainage holes at the base in which plants are delivered and grown for not less than three months in the growing season before planting. All containerized plants shall not have pot bound roots. | Containers |
| 25.15 | Rootballs comprise the firmly bound fibrous root and soil of a plant. At all times and in particular during delivery, the root balls shall be retained in tact. | Rootballs |
| 25.16 | Substitution of specified plants materials shall not be permitted except under special circumstances and with prior approval. | Substitution |
| 25.18 | (a) Mulch shall be composed of an organic material such as leaf litter, tree bark, wood shavings, decomposed sawdust, chopped tree fern, with a nominal size of 2 – 20mm or other approved material. | Mulch |
| 25.26 | Container grown and containerized stock shall be well watered before dispatch from the nursery and shall remain in the containers until required for transplanting. | Containerized plants |
| 25.27 | (a) Protect all plants from mechanical damage, excessive transpiration and wilting during lifting, transportation and storage. Also protect all plants against excessive sunlight, wind and drought and in case of heavily foliated plants, i.e. most shrubs and especially evergreens, prevent overheating with its resultant loss of foliage. Replace any damaged plant material rejected by the Supervising Officer (SO) or, with approval, carefully prune and dress wounds with an approved sealant. | Protection during transit |

- | | | | |
|-------|-----|--|-----------------------------------|
| | (b) | Stand upright on level ground those trees and shrubs which are not immediately planted in their permanent positions or in an agreed position on site. Protect and maintain in good condition. | Storage of plant material on site |
| | | If trees and shrubs shall be delivered to the site with shoots and branches bundled, remove all tying materials immediately to prevent heating up and subsequent defoliation. | |
| | (c) | Cut loose and remove all wrapping materials round roots and containers. Trim any broken roots with clean secateurs or sharp knife. Dress wounds with approved sealant. | Before planting |
| 25.28 | (a) | Plants shall be thoroughly soaked with water for several hours before planting. The soil in the container or rootball shall be moist and cohesive. Containers or rootball wrapping shall not be removed until the time of planting and the rootball shall not be disturbed by loosening or breaking. Each plant shall be placed upright in the pit and set at the same level as planted in the nursery or container. | Planting |
| | (b) | Fabricated soil mix as Clause 25.01(e), or topsoil as Clause 25.01(d), shall be deposited and compacted in layers around the rootball until level with the surrounding ground in such a manner that the rootball is not disturbed. Plants shall be watered to soak the rootball and the fabricated soil mix or topsoil, immediately after planting. | Backfilling |
| | (c) | Apply slow release fertiliser as Clause 25.02(f) to plants with the fabricated soil mix or topsoil at the following rates:
200gm per heavy standard tree and large palm
100gm per standard tree, medium palm and conifer
50gm per seedling or whip tree, small palm and conifer, shrub, climbing plant and bamboo
25gm/m ² for grass areas, ground covers and herbaceous plants | Fertiliser |
| | (d) | All plants shall be planted in their final position within two days of delivery to site to avoid wilting. Immediately after planting and before mulching, thoroughly water all plants to settle the soil around the roots. Continue watering as necessary so as to maintain a moist soil at all times during the Contract Period and Establishment Period. | After planting |

- (e) After planting and watering, spread level and firm mulch 75 mm thick on areas where the gradient is less than 10° and within 72 hours after planting. **Mulching**
- (h) Pit plant seedlings, small shrubs and whips and herbaceous plants by excavating pits 100 mm larger all round than the root ball and 50 mm deeper than the rootball depth. When planting on a slope, measure the depth from the lowest adjacent ground level on the downward side of the pit. Prepare soil backfill material by adding and mixing in, pre-planting slow-release fertilizer in the quantities as specified in Clause 25.28(c) and backfill into the pit to a level in order to maintain the original relationship between the root collar of the plant and the soil surface. Remove the plant from its container and set upright in the pit and backfill with fabricated soil mix, or topsoil, firming first with the knuckles and then finally with the feet. Remove surplus and unsuitable material from site. **Pit planting of seedlings, small shrubs, whips, climbers and herbaceous plants**
- (k) Dig tree pits to size as specified below: **Pit planting of light standards, standard, heavy standard, semi-mature trees, conifers, palms**
- | <u>Type of Tree/Palm/Conifer</u> | <u>Size</u> |
|--|-----------------------|
| (a) Light standard, standard small conifers, small palms | 750mm F x 600mm deep |
| (b) Heavy standard, large palms, large conifers | 900mm F x 750mm deep |
| (c) Semi-mature trees | 1500mm F x 900mm deep |

Soak the rootball of the plant, and fork over the base of the tree pit to a depth of 150mm. Prepare backfill material by adding and mixing in fertilizer in the quantities as specified in Clause 25.28(c) with fabricated soil mix or topsoil. Backfill the base in layers and firm in, adjusting the planting depth so that the soil is level with the root collar of the plant. Remove the rootball covering, place the tree, adjust orientation of the crown and check planting depth, adjusting as necessary. Fix vertical stakes or guying stakes or as specified. Tie tree to stakes or secure trees with guys. Backfill in layers, firming in each layer with heel and water thoroughly. Adjust tree ties or guy wires as necessary. Mulch to a depth of 75 mm, water again and continue to water as required.

- (l) Pits excavated for planting on or adjacent to slopes shall not be left open during wet weather. Pit safety

Planting – Trees, Seedlings, Whips

Materials

- 25.32 (a) Seedling trees shall be trees grown from seed and to have all the following characteristics:- Seedling trees
- (i) aged between 1-2 years old;
 - (ii) a single slender stem;
 - (iii) a well developed vigorous root system;
 - (iv) a height over 200 mm and less than 600 mm;
 - (v) grown in a container not less than 75 mm diameter and 200 mm deep minimum
- (b) Whips shall have all the following characteristics:- Whips
- (i) aged between 2-3 years old;
 - (ii) a single central stem and elementary branch system;
 - (iii) a well developed vigorous root system;
 - (iv) a height over 600 mm and less than 1750 mm;
 - (v) grown in a container not less than 125 mm in diameter and 200 mm deep.
- (c) Light standard trees shall have all the following characteristics:- Light standard trees
- (i) a height over 1600 mm and less than 2000 mm from the root collar to the lowest branch;
 - (ii) total height above soil level: between 2400 mm - 3000 mm;
 - (iii) a well developed vigorous root system;

- (iv) strong, upright and reasonably straight unpruned stems of diameter over 25 mm to 40 mm measured at a point one metre above the root collar, well furnished with side branches with good symmetry;
- (v) the diameter of the rootball shall be not less than 300 mm and with a depth not less than 300 mm;
- (vi) grown in a container not less than 350 mm in diameter and 400 mm deep.

Planting – Ground cover, Shrubs, Climbers and Herbaceous Plants

Materials

- 25.34 (a) Ground cover plants shall have all the following Ground cover characteristics:-
- (i) well developed vigorous shoots, no fewer in number than specified;
 - (ii) a well-developed vigorous root system;
 - (iii) minimum dimensions not less than those specified, with a tolerance which shall not deviate from the specified dimension by more than + 50mm;
 - (iv) grown in a container not less than 125 mm in diameter and 150 mm deep
- (b) Small shrubs are seedlings or rooted cuttings and shall Small shrubs have all the following characteristics:-
- (i) a minimum of three vigorous shoots with a well balanced shape, and bushy habit;
 - (ii) a well-developed vigorous root system;
 - (iii) minimum dimensions not less than those specified, with a tolerance which shall not deviate from the specified dimension by more than + 100mm;
 - (iv) grown in a container not less than 125 mm in diameter and 150 mm deep

- | | | |
|-----|---|--------------|
| (c) | Large shrubs are transplanted seedlings or rooted cuttings and shall have all the following characteristics:- | Large shrubs |
| | (i) a minimum of five vigorous shoots with a well balanced shape, and bushy habit, to produce a diameter 2/3 of the height; | |
| | (ii) a well-developed vigorous root system; | |
| | (iii) minimum dimensions not less than those specified, with a tolerance which shall not deviate from the specified dimension by more than + 200mm; | |
| | (iv) grown in a container not less than 200 mm in diameter and 250 mm deep | |
| (d) | Climbers shall have all the following characteristics:- | Climbers |
| | (i) a minimum of four vigorous, one year old shoots not less than 500 mm long except when specified otherwise; | |
| | (ii) a well-developed vigorous root system; | |
| | (iii) grown in a container not less than 125 mm in diameter and 150 mm deep | |

Workmanship

- | | | |
|-------|--|---|
| 25.36 | Pit plant ground cover, small shrubs, climbers and herbaceous plants in pits shall be 100 mm greater than the diameter of the rootball or root spread and 50 mm deeper than the rootball depth | Planting ground cover, small shrubs, climbers and herbaceous plants |
| 25.37 | Pit plant large shrubs and bamboos in the pits shall be 150 mm greater than the diameter of the rootball and 50 mm deeper than the depth of the rootball. | Planting large shrubs, and bamboos |
| 25.39 | (a) Apply a 25 mm deep layer of mulch to the surface of all ground cover areas, immediately after watering in. | Mulching to ground cover |
| | (b) Apply a 50 mm deep layer of mulch to the surface of all shrub, climber and bamboo areas, immediately after watering in. | Mulching to shrubs, climber bamboos and palms |

Adapted from General Specification for Building 1993: Section 25 Landscape



5.4 Implementation and Maintenance

The landscape and compensatory planting within the Country Park will be carried out in rainy season around May 2006.

Maintenance should include watering during dry periods and during the first two months after planting. Compensatory planting will be subject to a maintenance period of 12 months after completion.

The Qualified Ecologist should identify during maintenance the requirements on-site to ensure the establishment and survival of plants which may be necessary, for example, measures such as fencing should be applied if planted species are being destroyed by domestic stock. In addition to the regular watering requirement, the key anticipated maintenance works to be carried out, all as agreed with and instructed by the Qualified Ecologist, will include:

- Monthly inspection to establish the need for weeding, pruning, securing stakes and ties, replacing dead plants and treatment of insect or fungal infestations;
- Periodic inspection, as required, after heavy rain and/ or wind to firm up loosened plants;
- Monthly cutting of grass during the wet season and every other month during the dry season;
- Two applications of fertilizer, one during early spring and one during late summer;
- One operation before the end of the maintenance period to thin the plants to prevent overcrowding, aerate all shrub areas and, after weeding, top up mulch to all shrub areas.

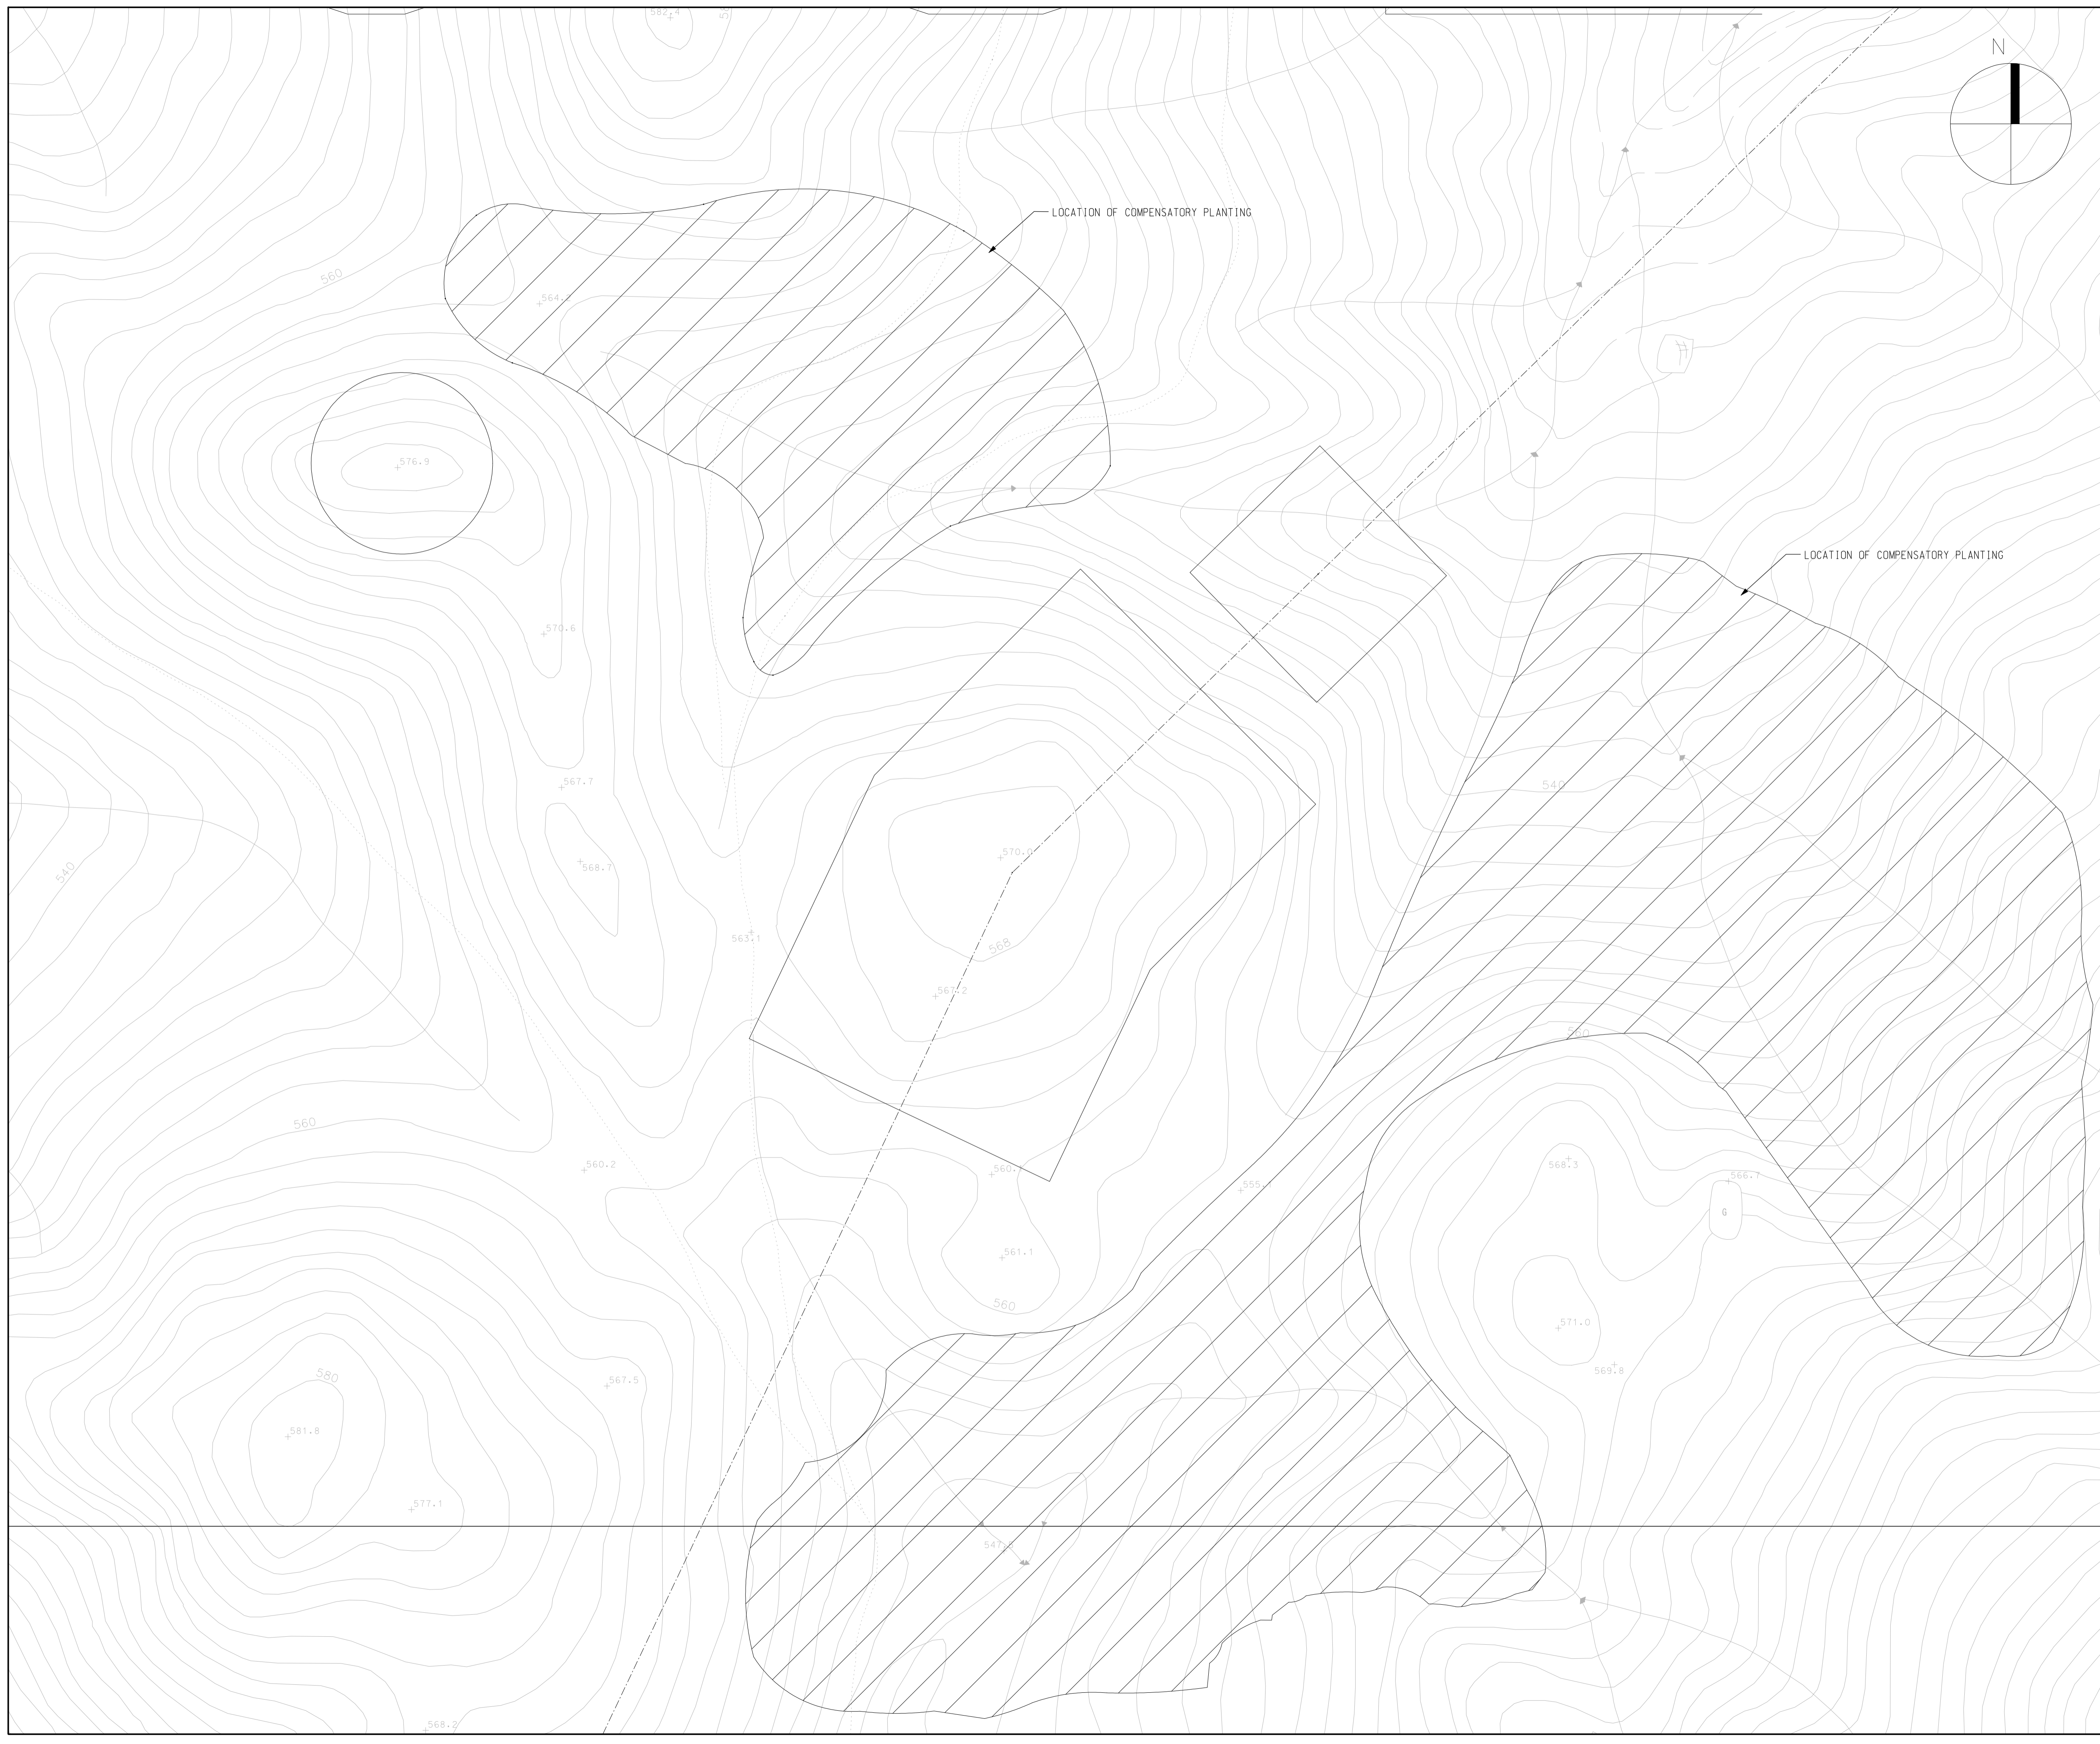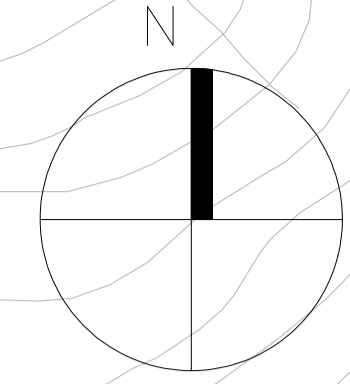

Rev.	Date	Dwn.	Description	Dgn.	Chd.	App'd.
------	------	------	-------------	------	------	--------

Designed: _____ Date: _____ Checked: _____

Drawn: _____ Date: _____ Checked: _____

Approved: _____ For MCL Date of Issue: _____

Client

 <p>地鐵公司 MTR Corporation</p>	MTR TOWER TELFORD PLAZA - KOWLOON BAY HONG KONG TEL : 2993 2111 FAX : 2796 8822
---	--


Consulting Engineers
Mott Connell Ltd.
 40/F Hopewell Centre
 183 Queen's Road East, Hong Kong
 Tel No. 2828 5757
 Fax No. 2827 1823

Project
TUNG CHUNG CABLE CAR PROJECT

Originator
 MTR Corporation Limited
 PROJECT DIVISION


Title

COMPENSATORY PLANTING
(2HA)

	Scale : 1 : 500
	Contract No. / Unit
Drawing No.	Rev.

© Copyright Reserved FIGURE 5-1

CAD File: \$FILES Status:

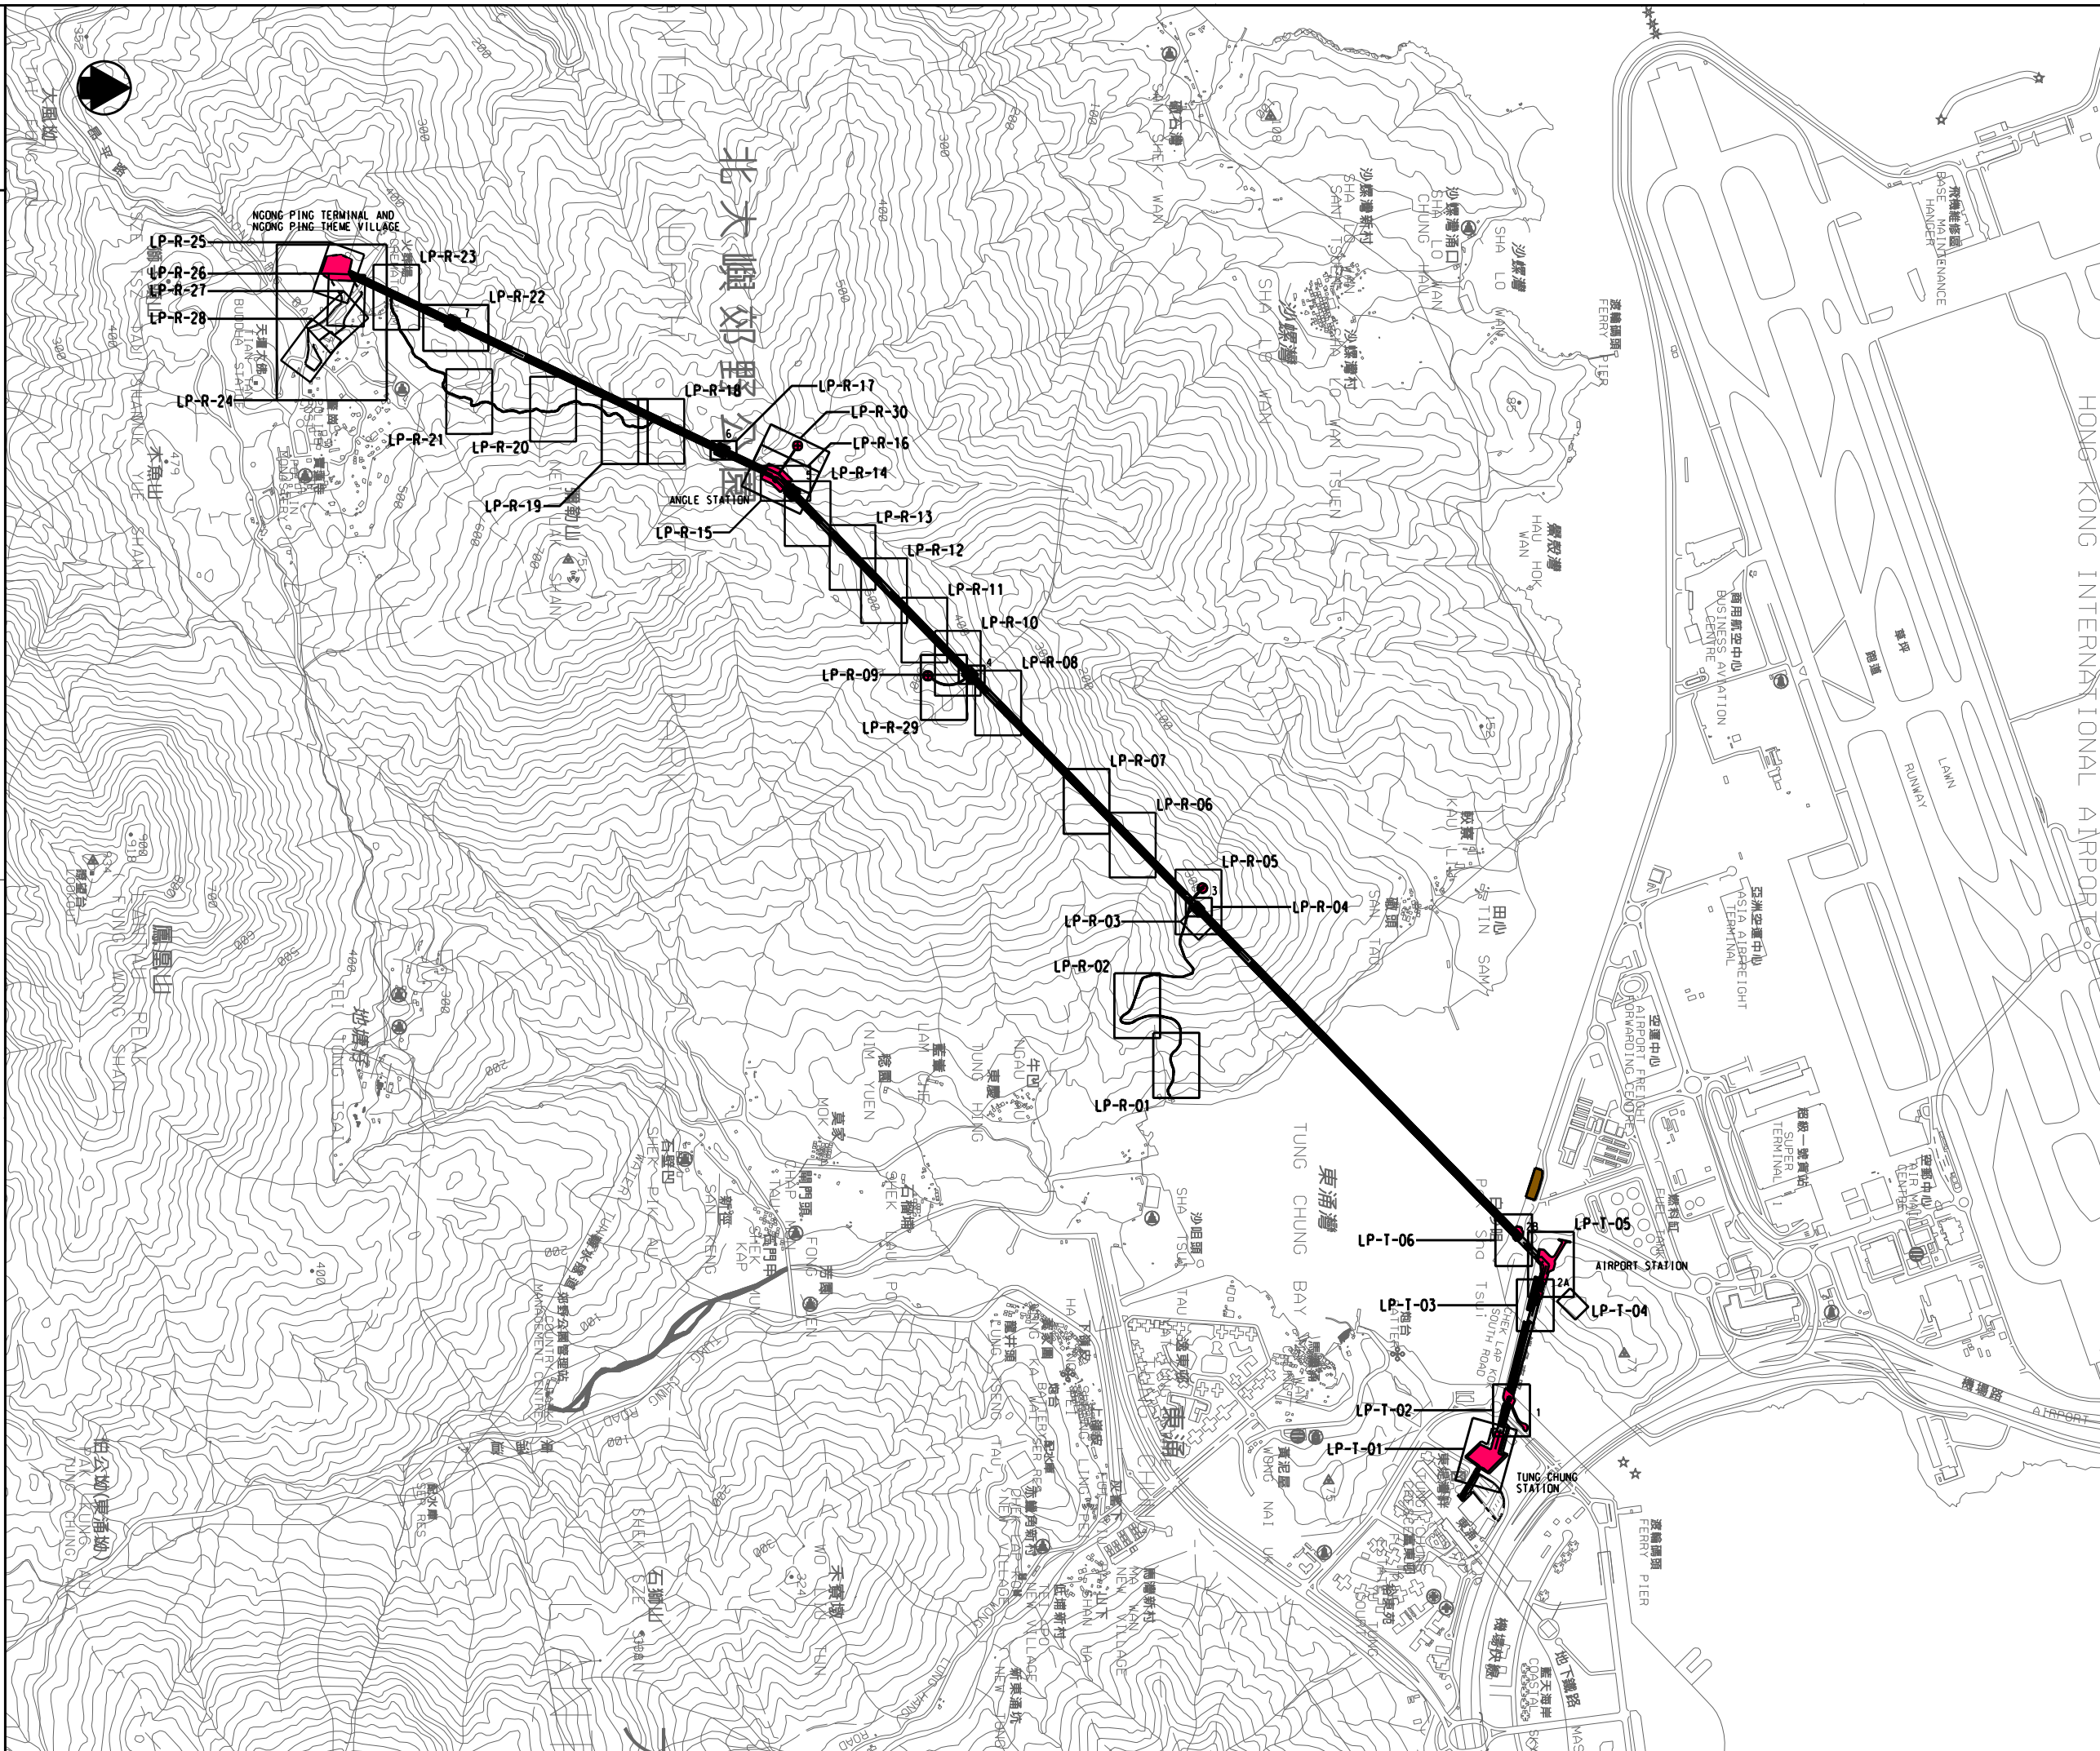

NOTES:

1. ALL PLANTING WORKS WILL BE WITHIN SITE BOUNDARY.
2. ALL AREAS TO BE HYDROSEED PRIOR TO PLANTING WORKS TO ASSIST EROSION CONTROL. HYDROSEED MIX TO CONSIST OF CYNODON DACTYLON + PASPALUM NOTATUM. (THERE IS TO BE NO GREEN DYE OR TERRAM COVER TO BE USED WITHIN COUNTRY PARK TO AVOID ANY POLLUTANTS TO PARK)
3. WOODLAND PLANTINGS TO BE SEEDLINGS/WHIP (500-1000mm HT.) WITH SPACING TO TAKE INTO CONSIDERATION EXISTING PLANTINGS + SITE CONDITIONS (RANGING FROM 2-5 METRES CENTRES.) LAYOUT OF WOODLAND MIX PLANTINGS TO BE IN A RANDOM DESIGN.
4. NPT + NPTV WILL HAVE APPROX. 205 NATIVE / ORNAMENTAL TREES AND APPROX. 13000 SHRUBS. (SEE NPTV LANDSCAPE PLAN)
5. T.2b, AIAS, T.1 + TCT WILL HAVE AN ADDITIONAL TREES APPROX. (SEE APPROPRIATE DRAWING)

PLANTING PROPOSAL SUMMARY (WOODLAND PLANTINGS)

NPT + NPTV (INCLUDING ALONG REDIRECTED STREAM) -SEE DRAWING	2000 NOS.
T.7	400 NOS.
T.6	200 NOS.
NLS	800 NOS.
T.5	200 NOS.
T.4	200 NOS.
T.3	200 NOS.
T.2b	200 NOS.
AIAS	1000 NOS.
T.2a	-
T.1	200 NOS.
TCT	600 NOS.
MARKER CABLE	400 NOS.
TOTAL	6400 NOS.

REVISION	DESCRIPTION	BY	DATE	APPROVED

前田建設工業株式会社
Maeda Corporation
 1001-5 NEW EAST OCEAN CENTRE
 9 SCIENCE MUSEUM ROAD
 T.S.T. EAST, KOWLOON, HONG KONG
 TEL : 2599 6267 FAX : 2724 4054

地鐵公司
MTR Corporation
 MTR TOWER
 TELFORD PLAZA - KOWLOON BAY
 HONG KONG
 TEL : 2988 2111 FAX : 2798 9822

東涌吊車
TUNG CHUNG CABLE CAR
凱達柏濤有限公司
Aedas Limited

TUNG CHUNG CABLE CAR
LANDSCAPE PLANTING PLAN
KEY PLAN - TUNG CHUNG TERMINAL TO TOWER 7

SCALE	1 : 10000 (A1)	CAD REF	AS BUILT APPROVED
DATE	23-02-06	AS BUILT DWG NO	
DRAWN	WL	DESIGNED	JW
CHECKED	JW	APPROVED	SF
DRAWING NO	LP-100		
REV	A		

Notes:

1. All planting works to be laid out in a random design to complement surrounding environment.
2. Plant spacings will vary from 2-5 metres depending on species and existing habitat.
3. Each planting area will be taken on its own merit to decide appropriate design with existing environmental conditions. ie. Rock outcrops, Streams, Slopes etc...
4. ALL AREAS TO BE HYDROSEED PRIOR TO PLANTING WORKS TO ASSIST EROSION CONTROL. HYDROSEED MIX TO CONSIST OF CYNODON DACTYLON + PASPALUM NOTATUM. (THERE IS TO BE NO GREEN DYE OR TERRAM COVER TO BE USED WITHIN COUNTRY PARK TO AVOID ANY POLLUTANTS TO PARK)

Plant schedule:

Woodland mix 'A'

Shrubs	Botanical Name	Size(mm)Ht.
Ga	Gordonia axillaris	500-1000mm
Scs	Schima Superba	500-1000mm
Rt	Rhodomyrtus tomentosa	500-1000mm
Ms	Melastoma sanguineum	500-1000mm
Bf	Baeckea frutescens	500-1000mm
Dp	Dicranopteris pedata	500-1000mm

Woodland mix 'B'

Sd	Sapium discolor	500-1000mm
Rc	Rhus chinensis	500-1000mm
Ls	Litsea rotundifolia	500-1000mm
Mch	Machilus chinensis	500-1000mm

Woodland mix 'C'

Mc	Melastoma candidum	500-1000mm
Mpan	Microcos paniculata	500-1000mm
Ri	Rhaphiolepis indica	500-1000mm
Ss	Sapium sebiferum	500-1000mm
Sh	Schefflera heptaphylla	500-1000mm
Mp	Mallotus paniculatus	500-1000mm

Woodland plantings	Quantities
NPT + NPTV	2000 nos.
Tower-7	400 nos.
Tower-6	200 nos.
Nei Lak Shan-Angle Station	800 nos.
Tower-5	200 nos.
Tower-4	200 nos.
Tower-3	200 nos.
Tower-2b	200 nos.
Airport Island-Angle Station	1000 nos.
Tower-2a	-
Tower-1	200 nos.
Tung Chung Terminal	600 nos.
MARKER CABLE	400 nos.
Total	6400 nos.

NO PART SHALL BE REPRODUCED, STORED OR TRANSMITTED IN ANY FORM OR BY ANY MEANS, ELECTRONIC OR MECHANICAL, INCLUDING PHOTOCOPYING, RECORDING, OR BY ANY INFORMATION STORAGE AND RETRIEVAL SYSTEM, WITHOUT THE WRITTEN CONSENT OF THE MTR CORPORATION.

REVISION	DESCRIPTION	BY	DATE	APPROVED

	前田建設工業株式会社 Maeda Corporation	1001-5 NEW EAST OCEAN CENTRE 9 SCIENCE MUSEUM ROAD T.S.T. EAST, KOWLOON, HONG KONG TEL : 2269 6267 FAX : 2724 4064
---	--	---


	地鐵公司 MTR Corporation	MTR TOWER TELFORD PLAZA - KOWLOON BAY HONG KONG TEL : 2983 2111 FAX : 2798 9822
---	--------------------------------	--

	東涌吊車 TUNG CHUNG CABLE CAR
---	-------------------------------------

	凱達柏濶有限公司 Aedas Limited
---	----------------------------------





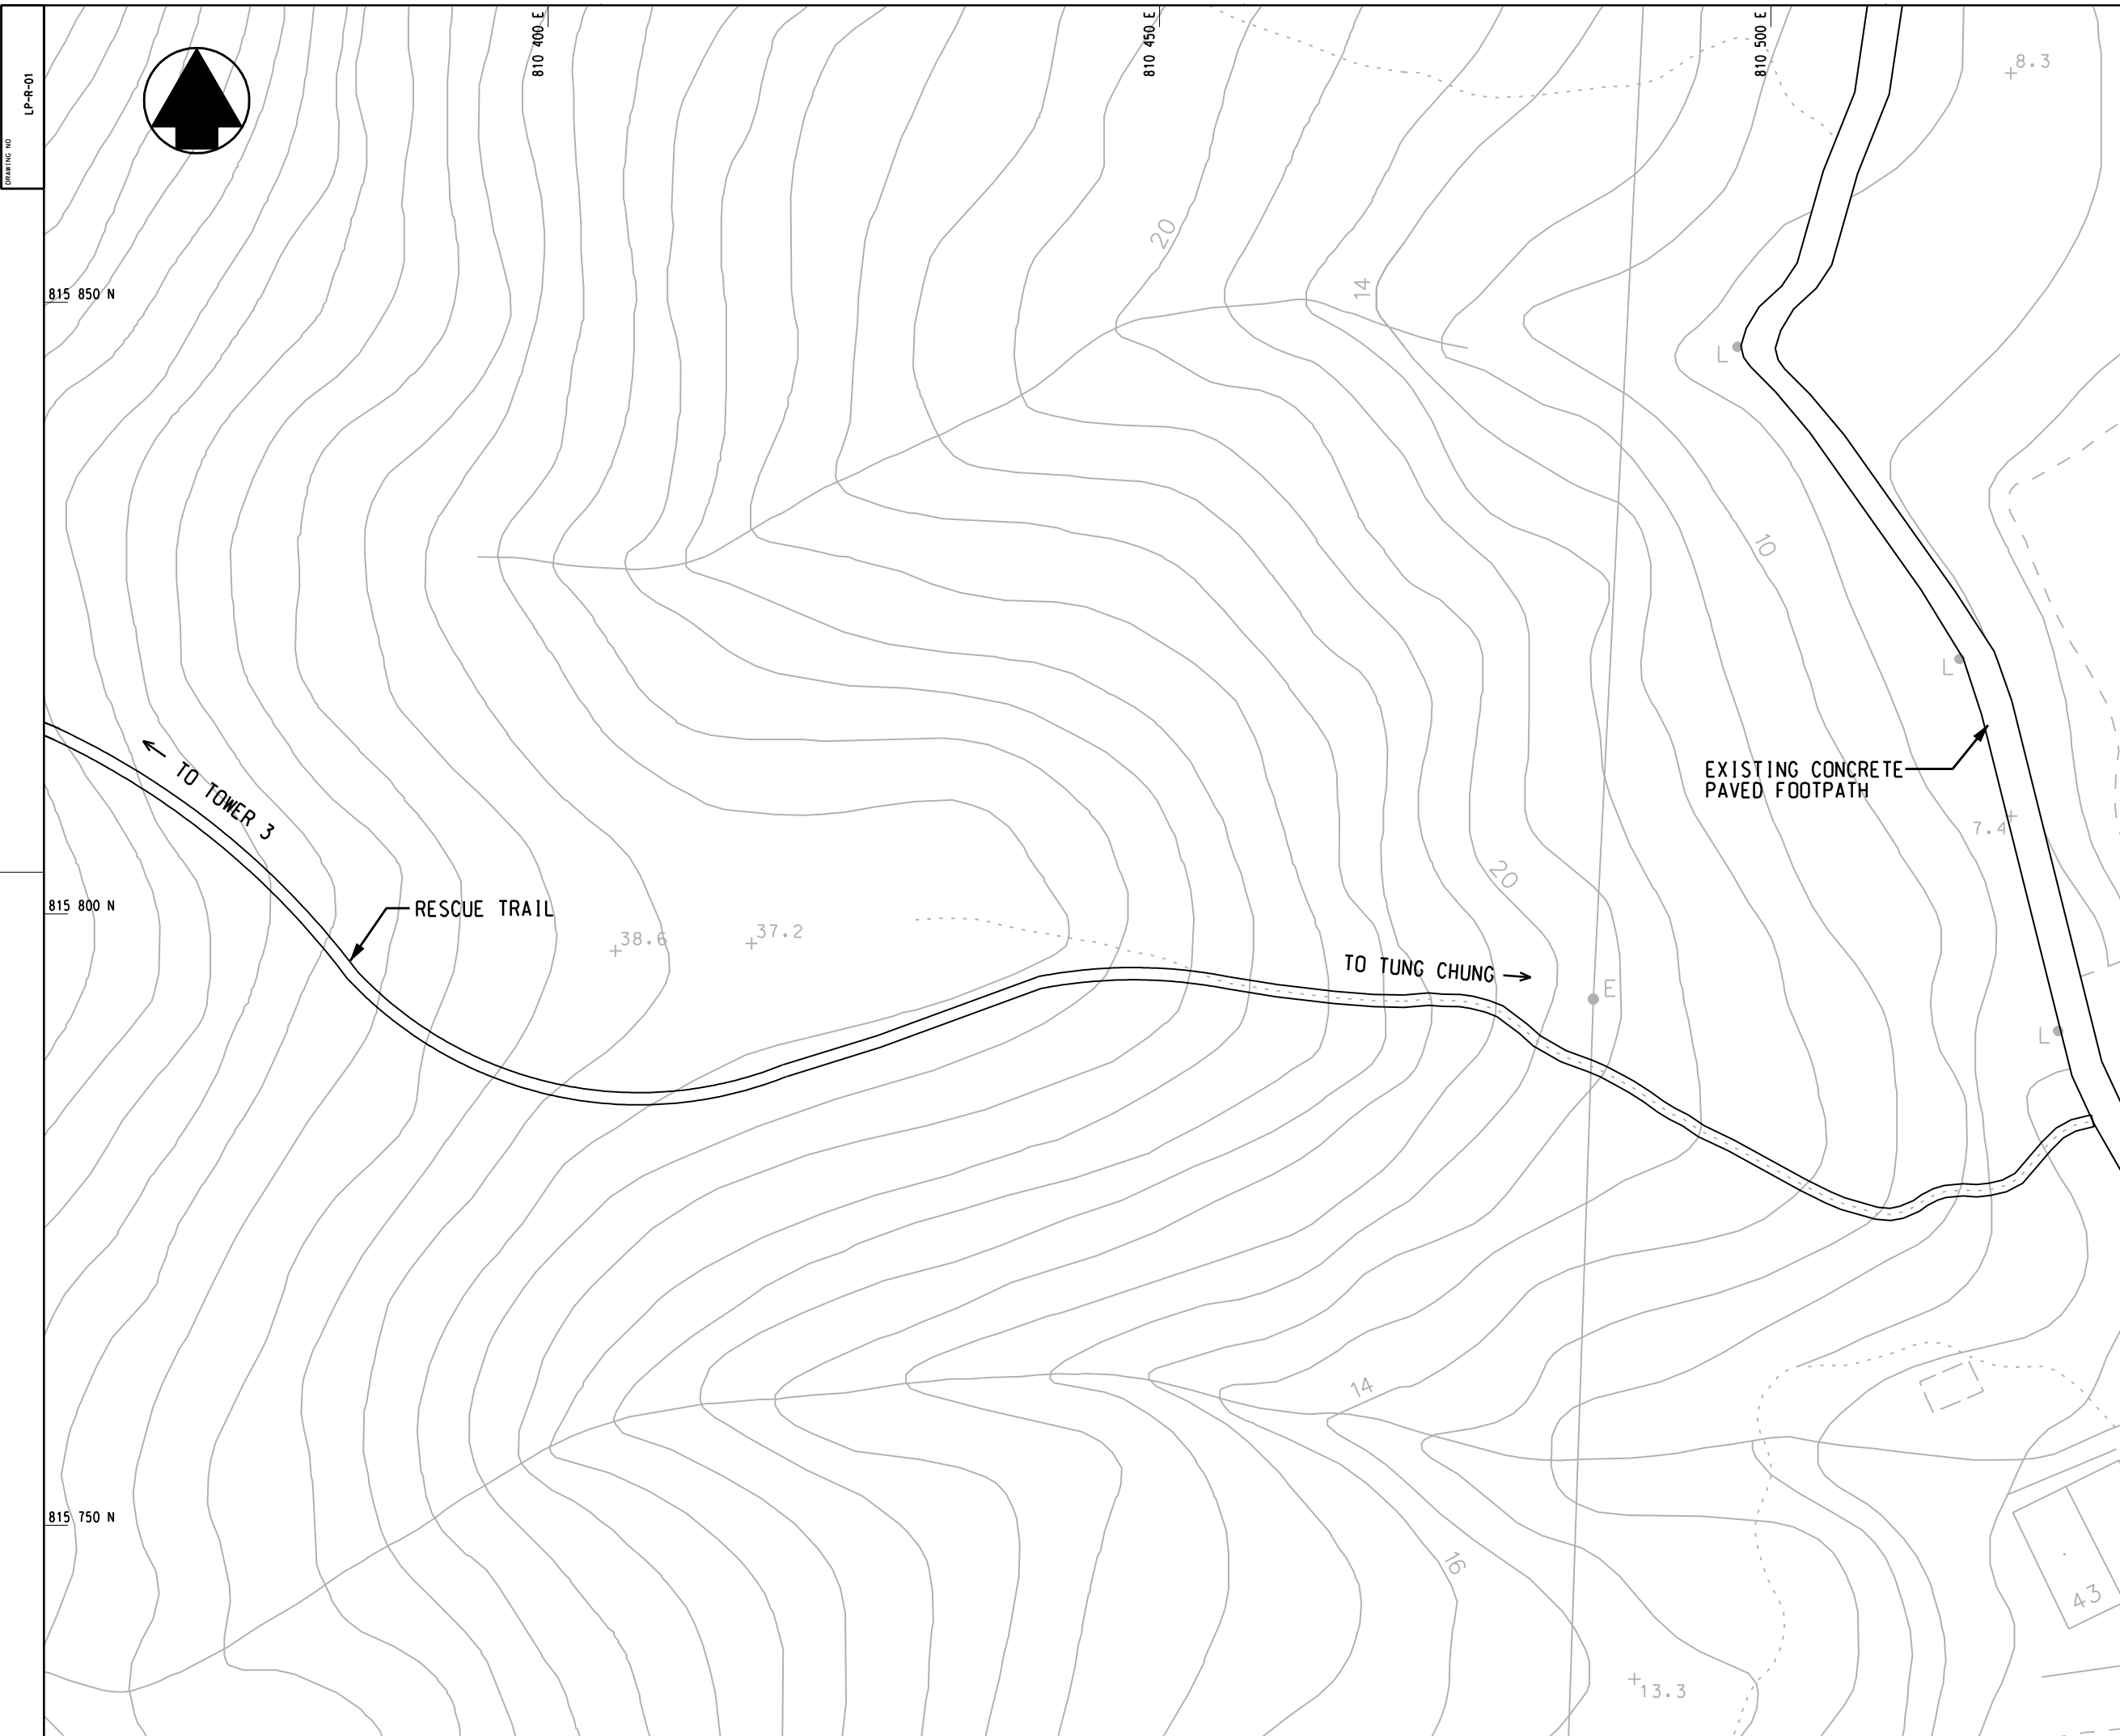

LANDSCAPE PLANTING PLAN
GENERAL NOTE

SCALE	N. T. S.	CAD REF	AS BUILT APPROVED
DATE	FEB. 2006	AS BUILT DWG NO	
DRAWN	WL	DESIGNED	JW
CHECKED	JW	APPROVED	SF
DRAWING NO		REV	
LP-101		A	



DRAWING NO
LP-R-01

NO NET SCALE DIMENSIONS. VERIFY ALL DIMENSIONS ON SITE.
 © 2002 HONG KONG METEOROLOGICAL DEPARTMENT
 INFORMATION ON WEATHER AND CLIMATE OF HONG KONG IS AVAILABLE ON THE INTERNET AT THE WEBSITE: www.hkmo.gov.hk
 IF YOU HAVE ANY INFORMATION OF THE CURRENT / FORECAST OF ANY HAZARD OR UNUSUAL WEATHER, PLEASE CONTACT THE HONG KONG METEOROLOGICAL DEPARTMENT.

- LEGENDS:**
-  WORKS SITE
 -  NEW TREE PLANTING
 -  RETAINED TREE
 -  TRANSPLANTED TREE
 -  PLANTING AREA
 -  RETAINED WOODLAND

NOTES:

ALL AREAS TO BE HYDROSEEDING PRIOR TO PLANTING WORKS TO ASSIST EROSION CONTROL. HYDROSEED MIX TO CONSIST OF CYNODON DACTYLON + PASPALUM NOTATUM. (THERE IS TO BE NO GREEN DYE OR TERRAM COVER TO BE USED WITHIN COUNTRY PARK TO AVOID ANY POLLUTANTS TO PARK)

REVISION	DESCRIPTION	BY	DATE	APPROVED


前田建設工業株式会社
 Maeda Corporation
 1901-5 NEW EAST OCEAN CENTRE
 9 SCIENCE MUSEUM ROAD
 T.S.T. EAST, KOWLOON, HONG KONG
 TEL.: 2599 6267 FAX.: 2724 4084


地鐵公司
 MTR Corporation
 MTR TOWER
 TELFORD PLAZA - KOWLOON BAY
 HONG KONG
 TEL.: 2988 2111 FAX.: 2798 9822



東涌吊車
 TUNG CHUNG CABLE CAR
 ORIGINATOR
凱達柏濤有限公司
 Aedas Limited

TITLE

RESCUE TRAIL FROM TOWER 3
TO TUNG CHUNG
LANDSCAPE PLANTING PLAN

SCALE	1 : 250 @ A1	CAD REF		AS BUILT	
DATE	08APR2003	AS BUILT		DWG NO	
DRAWN	WL	DESIGNED	JW	DRAWING NO	LP-R-01
CHECKED	JW	APPROVED	SF	REV	A

DRAWING NO
LP-R-02

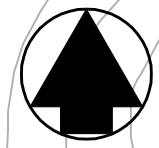

810 200 E

810 250 E

810 300 E

140

120

100

80

815 700 N

150.4

+150.5

← TO TOWER 3

TO TUNG CHUNG →

815 650 N

NO NET SCALE DIMENSIONS. VERIFY ALL DIMENSIONS ON SITE.
© 2002 HOKUKEI LANDSCAPE CORPORATION
DESIGNED BY HOKUKEI LANDSCAPE CORPORATION
FOR THE USE OF THE CLIENTS. ALL RIGHTS RESERVED. ANY REUSE OR MODIFICATION IS PROHIBITED WITHOUT THE WRITTEN CONSENT OF HOKUKEI LANDSCAPE CORPORATION.

LEGENDS:

- WORKS SITE
- NEW TREE PLANTING
- ⊙ RETAINED TREE
- ⊕ TRANSPLANTED TREE
- ☁ PLANTING AREA
- ▨ RETAINED WOODLAND

NOTES:

ALL AREAS TO BE HYDROSEEDING PRIOR TO PLANTING WORKS TO ASSIST EROSION CONTROL. HYDROSEED MIX TO CONSIST OF CYNODON DACTYLON + PASPALUM NOTATUM. (THERE IS TO BE NO GREEN DYE OR TERRAM COVER TO BE USED WITHIN COUNTRY PARK TO AVOID ANY POLLUTANTS TO PARK)

REVISION	DESCRIPTION	BY	DATE	APPROVED

前田建設工業株式会社
Maeda Corporation
1001-5 NEW EAST OCEAN CENTRE
9 SCIENCE MUSEUM ROAD
T.S.T. EAST, KOWLOON, HONG KONG
TEL : 2589 0287 FAX : 2724 4084


地鐵公司
MTR Corporation
MTR TOWER
TELFORD PLAZA - KOWLOON BAY
HONG KONG
TEL : 2988 2111 FAX : 2798 9822

東涌吊車
TUNG CHUNG CABLE CAR
ORIGINATOR
凱達柏濶有限公司
Aedas Limited

TITLE
RESCUE TRAIL FROM TOWER 3
TO TUNG CHUNG
LANDSCAPE PLANTING PLAN

SCALE	1 : 250 @ A1	CAD REF	AS BUILT APPROVED
DATE	08APR2003	AS BUILT DWG NO	
DRAWN	WL	DESIGNED	JW
CHECKED	JW	APPROVED	SF
DRAWING NO		REV	
LP-R-02		A	

RELOCATED FOOTPATH
ACCESS TO MATCH
EXISTING FOOTPATH
(STONE PAVING)

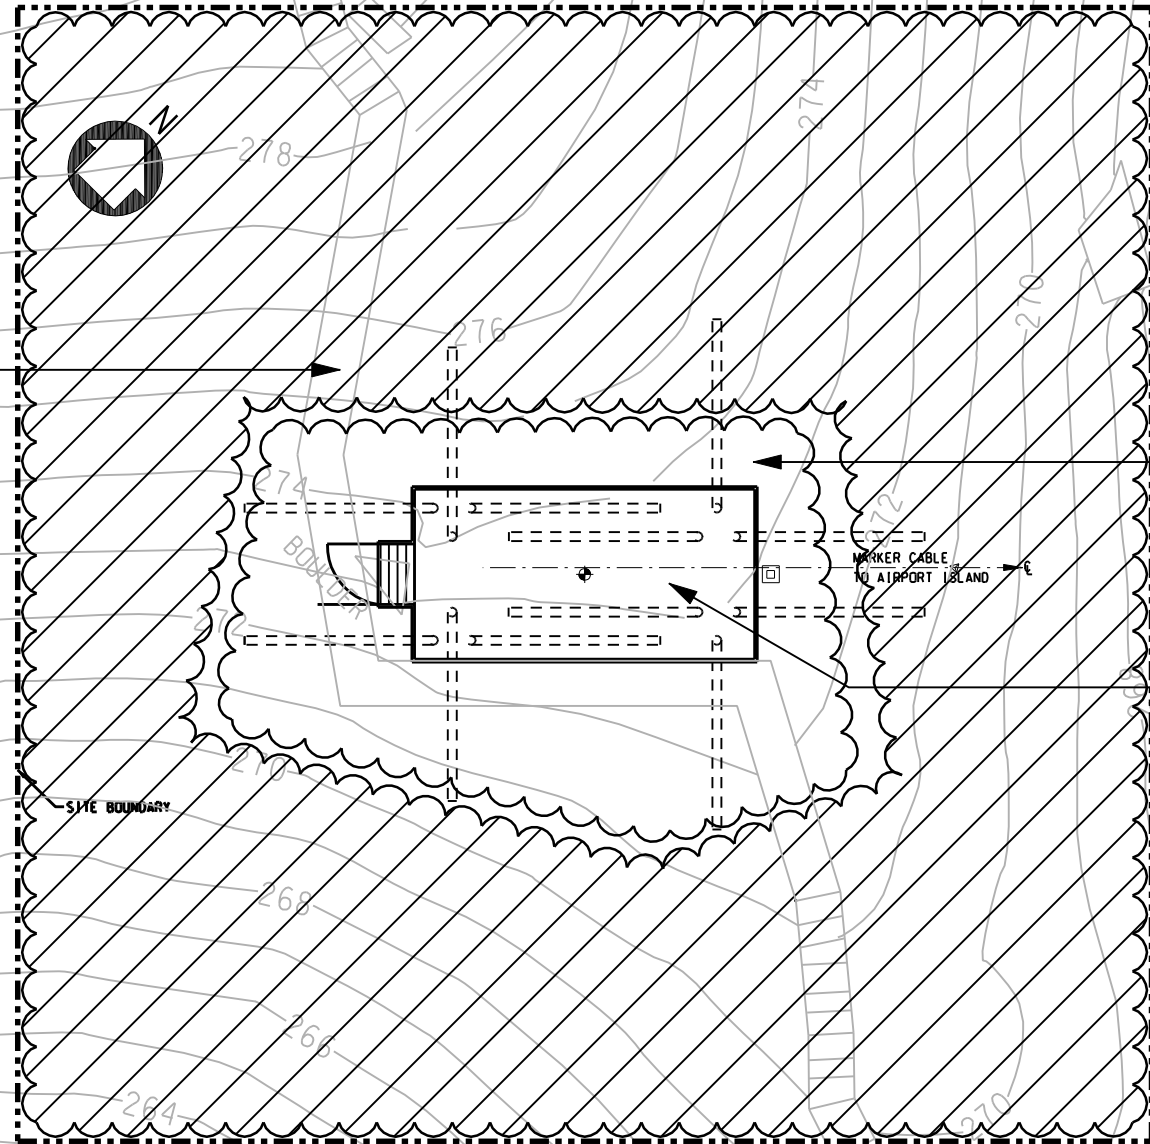

WOODLAND MIX
(A)+(B)+(C)

ANCHOR STRUCTURE TO
BE TREATED WITH A
VISUALLY RECESSIVE
COLOUR

NO PART SHALL BE REPRODUCED OR TRANSMITTED IN ANY FORM OR BY ANY MEANS, ELECTRONIC OR MECHANICAL, INCLUDING PHOTOCOPYING, RECORDING, OR BY ANY INFORMATION STORAGE AND RETRIEVAL SYSTEM, WITHOUT THE WRITTEN CONSENT OF THE HKS HONEYWELL CORPORATION.

- LEGENDS:**
- WORKS SITE
 - NEW TREE PLANTING
 - RETAINED TREE
 - TRANSPLANTED TREE
 - ☁ PLANTING AREA
 - ▨ RETAINED WOODLAND

NOTES:

ALL AREAS TO BE HYDROSEED PRIOR TO PLANTING WORKS TO ASSIST EROSION CONTROL. HYDROSEED MIX TO CONSIST OF CYNODON DACTYLON + PASPALUM NOTATUM. (THERE IS TO BE NO GREEN DYE OR TERRAM COVER TO BE USED WITHIN COUNTRY PARK TO AVOID ANY POLLUTANTS TO PARK)

PLANT SCHEDULE:

Woodland mix 'A'

Shrubs	Botanical Name	Size(mm)Ht.
Ga	Gordonia axillaris	1000mm
Scs	Schima Superba	1000mm
Rt	Rhodomyrtus tomentosa	1000mm
Ms	Melastoma sanguineum	1000mm
Bf	Baeckea frutescens	1000mm
Dp	Dicranopteris pedata	1000mm

Woodland mix 'B'

Shrubs	Botanical Name	Size(mm)Ht.
Sd	Sapium discolor	1000mm
Rc	Rhus chinensis	1000mm
Ls	Litsea rotundifolia	1000mm
Mch	Machilus chinensis	1000mm

Woodland mix 'C'

Shrubs	Botanical Name	Size(mm)Ht.
Mc	Melastoma candidum	1000mm
Mpan	Microcos paniculata	1000mm
Ri	Rhaphiolepis indica	1000mm
Ss	Sapium sebiferum	1000mm
Sh	Schefflera heptaphylla	1000mm
Mp	Malotus paniculatus	1000mm

REVISION	DESCRIPTION	BY	DATE	APPROVED

前田建設工業株式会社
Maeda Corporation
 1001-8 NEW EAST OCEAN CENTRE
 8 SCIENCE MUSEUM ROAD
 T.S.T. EAST, KOWLOON, HONG KONG
 TEL : 2269 6267 FAX : 2724 4084

地鐵公司
MTR Corporation
 MTR TOWER
 TELFORD PLAZA - KOWLOON BAY
 HONG KONG
 TEL : 2262 2111 FAX : 2798 9822

東涌吊車
TUNG CHUNG CABLE CAR

凱達柏濤有限公司
Aedas Limited

TITLE

CABLE MARKER (a) NEAR
TOWER 3
LANDSCAPE PLAN


SCALE	NTS	CAD REF	AS BUILT APPROVED
DATE	JUNE, 2005	AS BUILT DWG NO	
DRAWN	DESIGNED	DRAWING NO	REV
CHECKED	APPROVED	LP-R-03	A



N 815940
E 889920

N 815940
E 889940

N 815940
E 889960

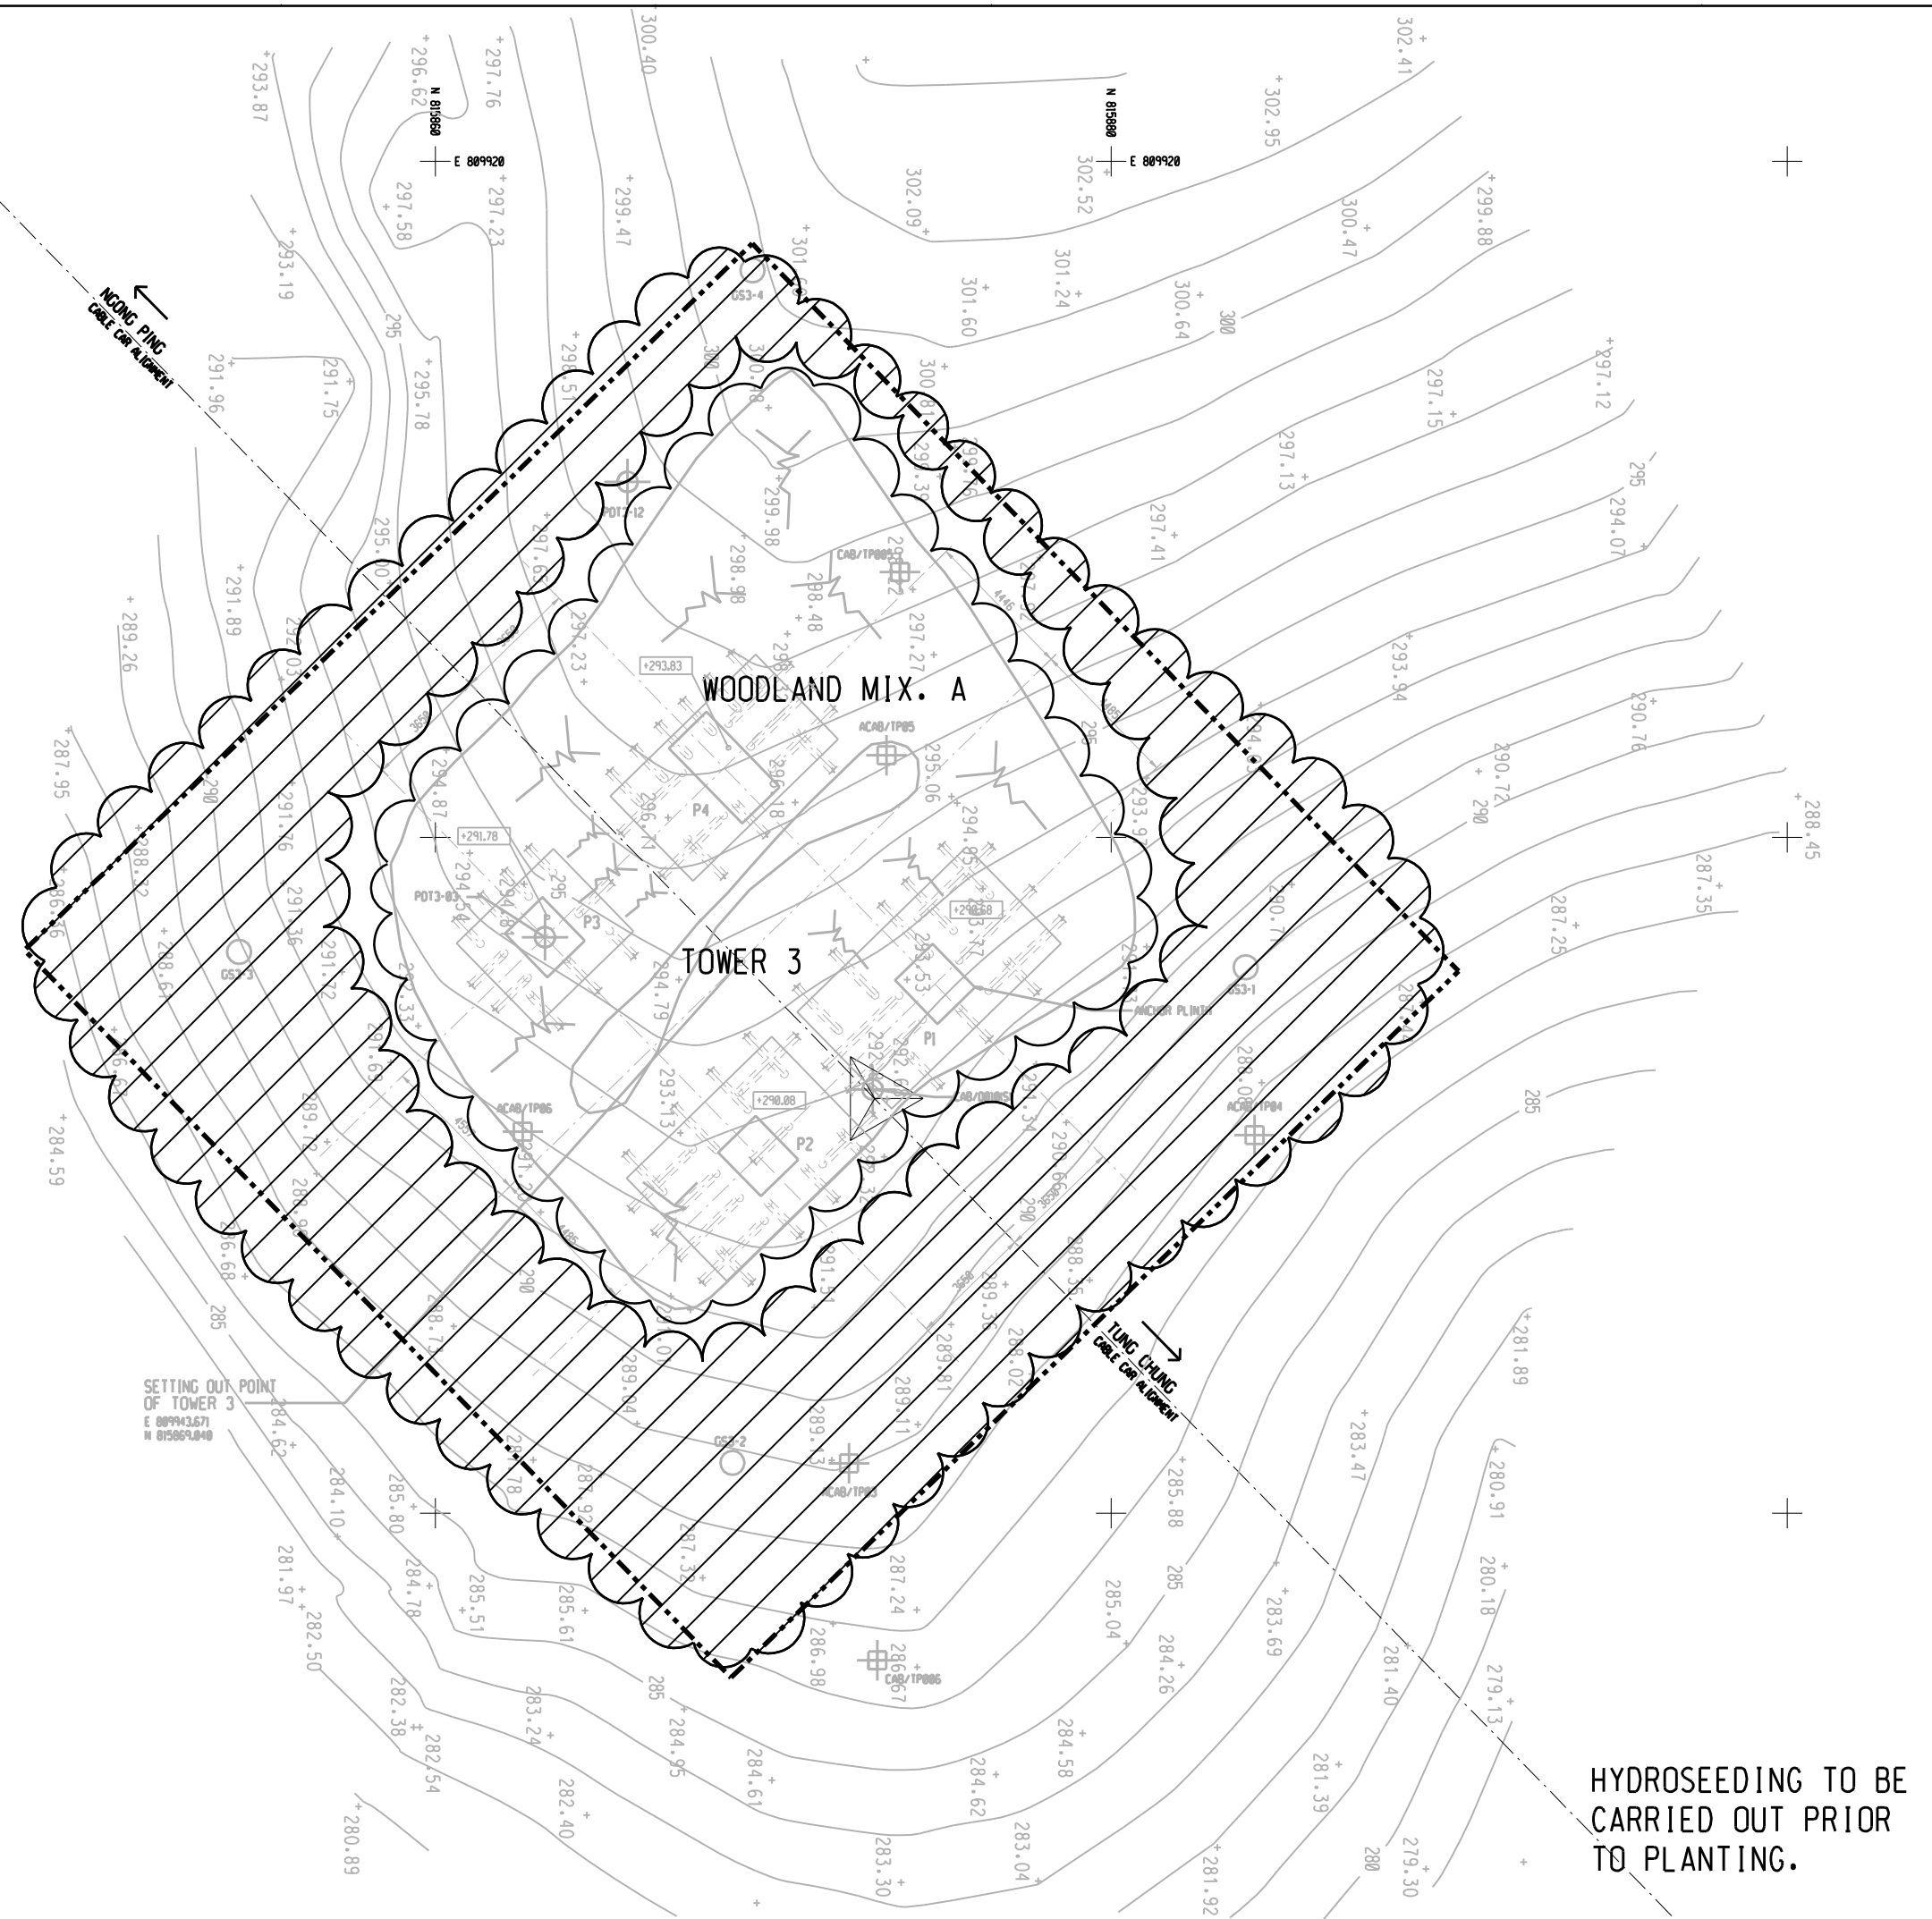

NO NEW TREE PLANTINGS, EXCEPT AS INDICATED ON SITE
 © 2005 HONGKONG DEVELOPMENT CORPORATION
 ALL RIGHTS RESERVED. NO PART OF THIS DRAWING IS TO BE REPRODUCED OR TRANSMITTED IN ANY FORM OR BY ANY MEANS, ELECTRONIC OR MECHANICAL, WITHOUT THE WRITTEN PERMISSION OF HONGKONG DEVELOPMENT CORPORATION.

- LEGENDS:**
- WORKS SITE
 - NEW TREE PLANTING
 - RETAINED TREE
 - TRANSPLANTED TREE
 - ☁ PLANTING AREA
 - ▨ RETAINED WOODLAND
- NOTES:**
- ALL AREAS TO BE HYDROSEED PRIOR TO PLANTING WORKS TO ASSIST EROSION CONTROL. HYDROSEED MIX TO CONSIST OF CYNODON DACTYLON + PASPALUM NOTATUM. (THERE IS TO BE NO GREEN DYE OR TERRAM COVER TO BE USED WITHIN COUNTRY PARK TO AVOID ANY POLLUTANTS TO PARK)
- WOODLAND PLANTINGS MIX TO EXTEND INTO SURROUNDING HABITAT TO PROVIDE NATURAL TRANSITION.

PLANT SCHEDULE:

Woodland mix 'A'

Shrubs	Botanical Name	Size(mm)Ht.
Ga	Gordonia axillaris	1000mm
Scs	Schima Superba	1000mm
Rt	Rhodomyrtus tomentosa	1000mm
Ms	Melastoma sanguineum	1000mm
Bf	Baeckea frutescens	1000mm
Dp	Dicranopteris pedata	1000mm

Woodland mix 'B'

Shrubs	Botanical Name	Size(mm)Ht.
Sd	Sapium discolor	1000mm
Rc	Rhus chinensis	1000mm
Ls	Litsea rotundifolia	1000mm
Mch	Machilus chinensis	1000mm

Woodland mix 'C'

Shrubs	Botanical Name	Size(mm)Ht.
Mc	Melastoma candidum	1000mm
Mpan	Microcos paniculata	1000mm
Ri	Rhaphiolepis indica	1000mm
Ss	Sapium sebiferum	1000mm
Sh	Scheffiera heptaphylla	1000mm
Mp	Mallotus paniculatus	1000mm

REVISION	DESCRIPTION	BY	DATE	APPROVED

前田建設工業株式会社
 Maeda Corporation
 1501-5 NEW EAST OCEAN CENTRE
 9 SCIENCE MUSEUM ROAD
 T.S.T. EAST, KOWLOON, HONG KONG
 TEL.: 2599 6287 FAX: 2724 4084

地鐵公司
 MTR Corporation
 MTR TOWER
 TELFORD PLAZA - KOWLOON BAY
 HONG KONG
 TEL.: 2883 2111 FAX: 2798 8822


PROJECT: 東涌吊車
 TUNG CHUNG CABLE CAR
 ORIGINATOR: 凱達柏灣有限公司
 Aedas Limited

TITLE: TOWER 3
 LANDSCAPE PLANTING PLAN

SCALE	1 : 100 @ A1	CAD REF.	AS BUILT APPROVED
DATE	APR. 2005	AS BUILT DWG NO.	
DRAWN	WL	DESIGNED	JW
CHECKED	JW	APPROVED	SF

DRAWING NO. LP-R-04

HYDROSEEDING TO BE CARRIED OUT PRIOR TO PLANTING.

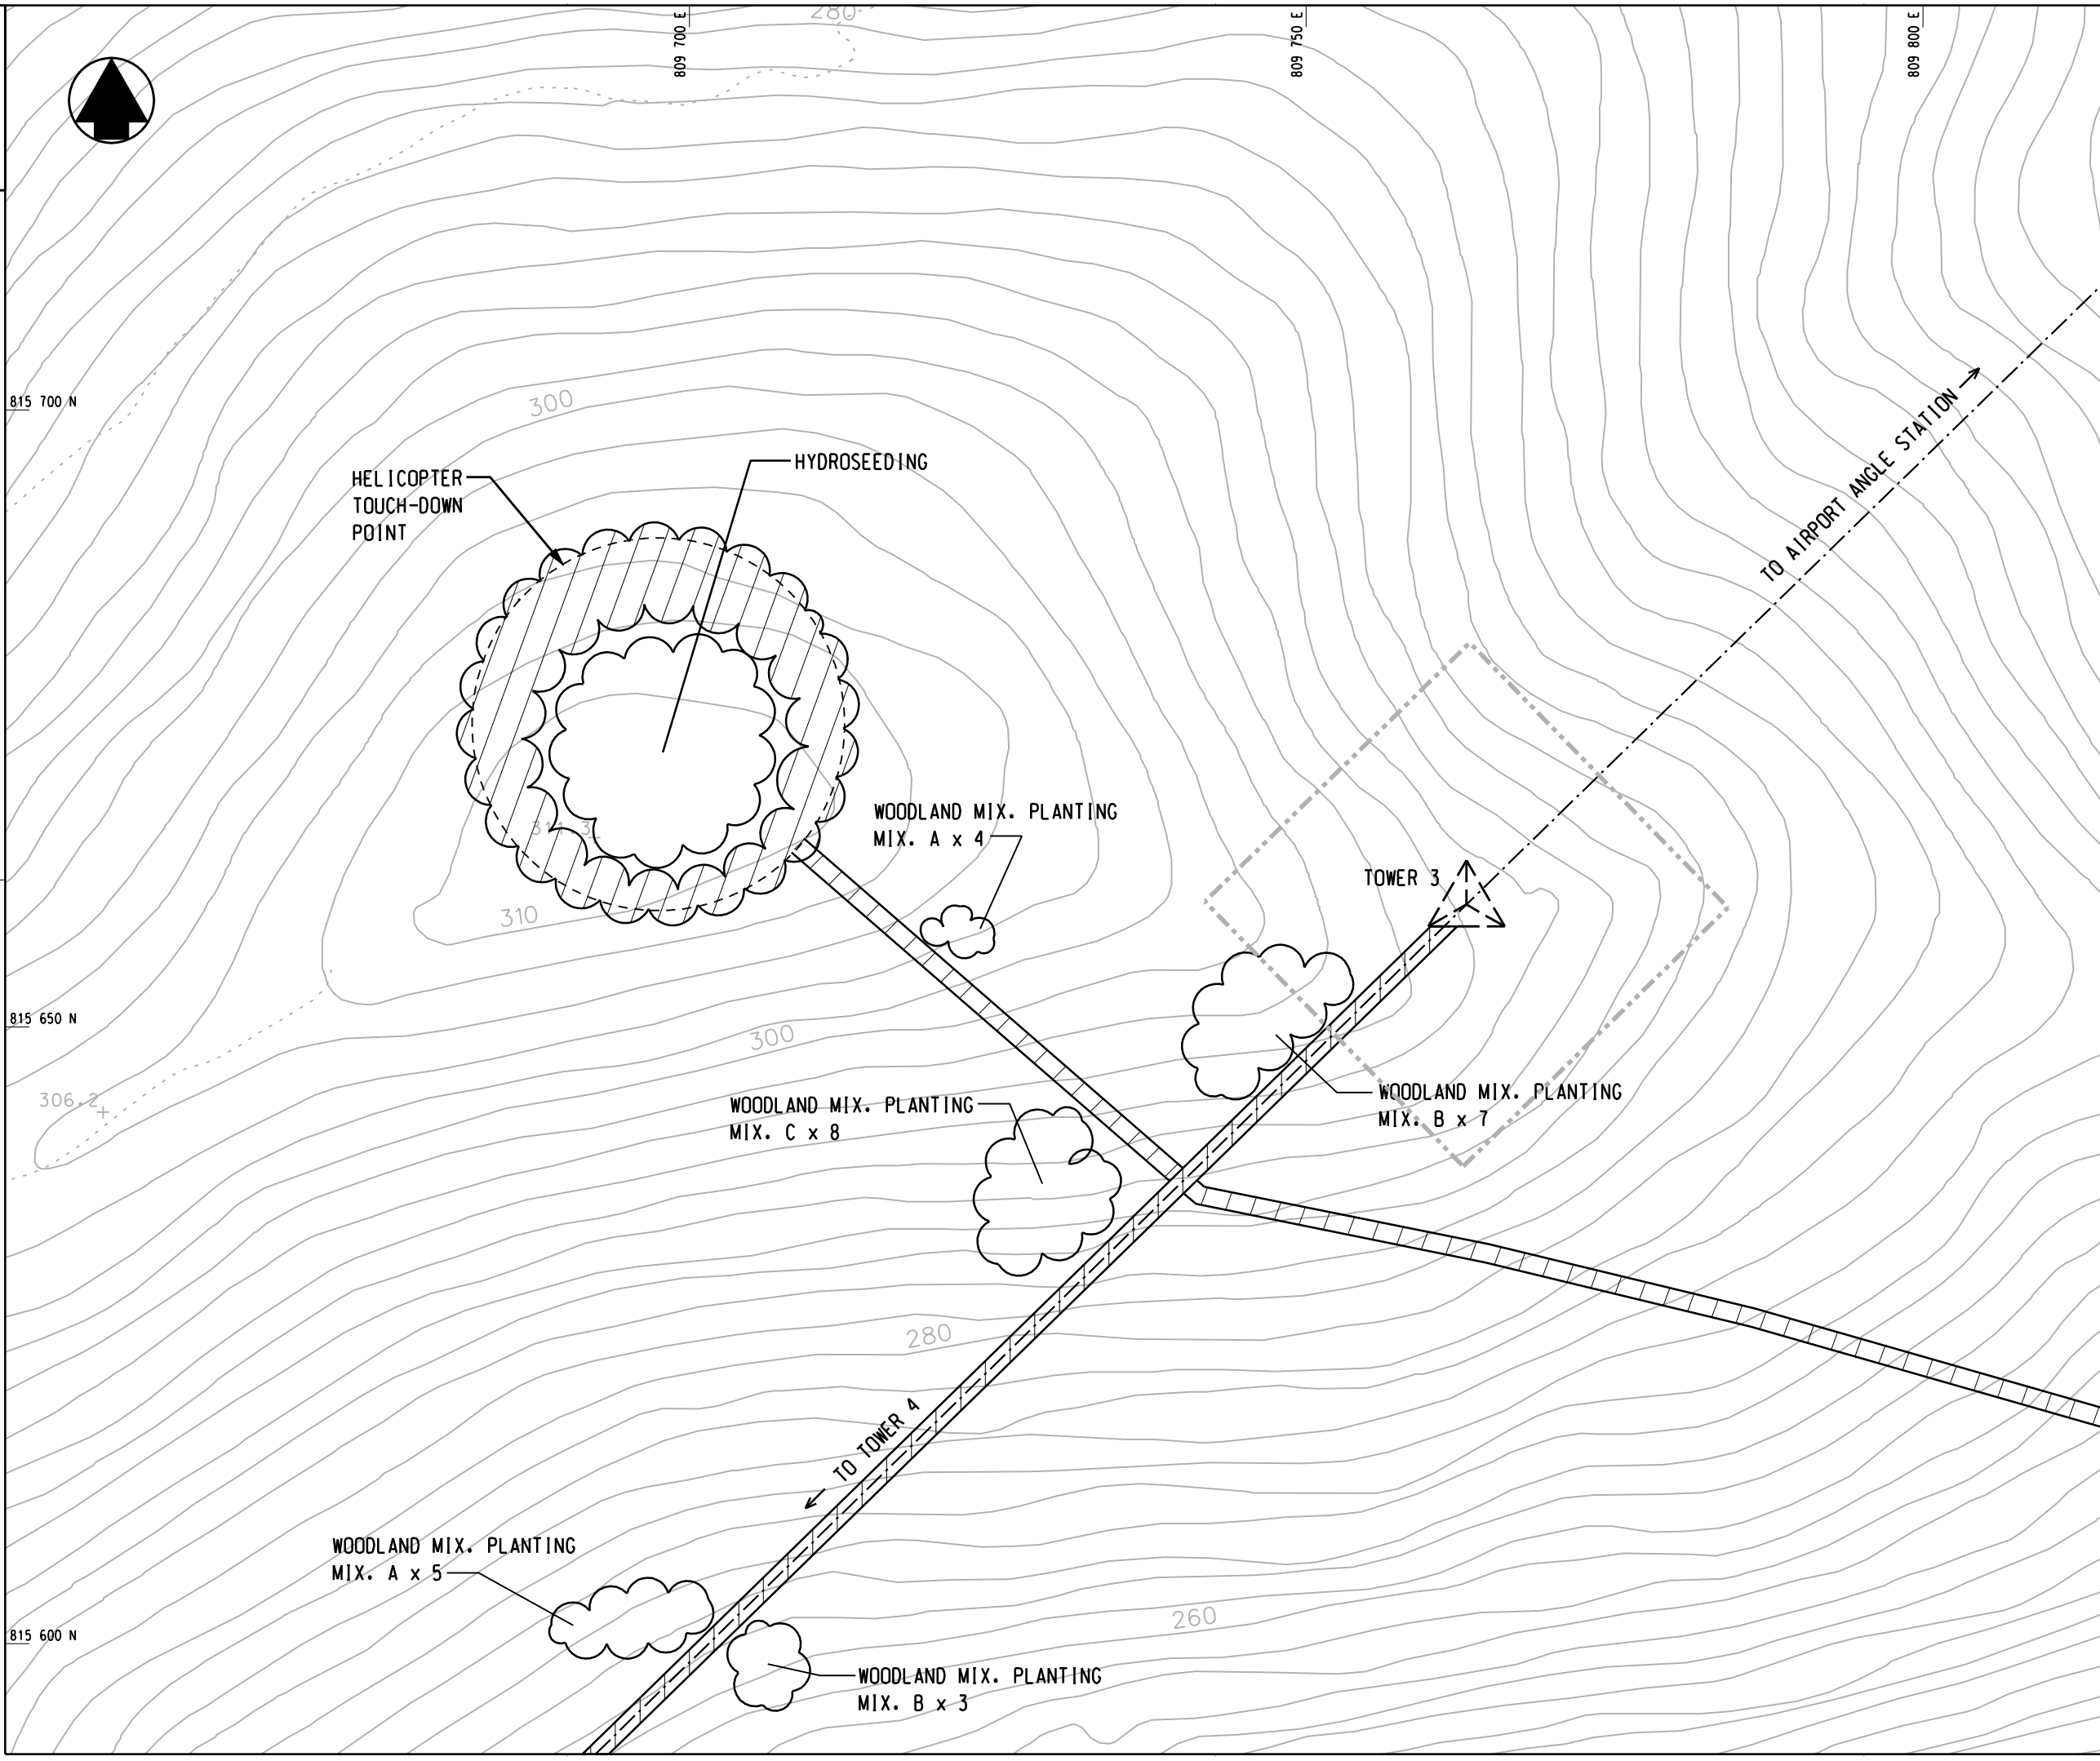

NO NET SCALE DIMENSIONS. VERIFY ALL DIMENSIONS ON SITE.
 © 2005 HONGKONG AIRCRAFT COMPANY LTD.
 PREPARED ON BEHALF OF THE CLIENT BY THE CONSULTANT ENGINEER.
 IT IS THE RESPONSIBILITY OF THE CLIENT TO OBTAIN ALL NECESSARY PERMISSIONS FROM THE RELEVANT AUTHORITIES FOR THE PROPOSED WORKS TO BE CARRIED OUT IN ACCORDANCE WITH THE RELEVANT LEGISLATION.

- LEGENDS:**
- WORKS SITE
 - NEW TREE PLANTING
 - ◉ RETAINED TREE
 - ◌ TRANSPLANTED TREE
 - ☁ PLANTING AREA
 - ▨ RETAINED WOODLAND

NOTES:

ALL AREAS TO BE HYDROSEEDING PRIOR TO PLANTING WORKS TO ASSIST EROSION CONTROL. HYDROSEED MIX TO CONSIST OF CYNODON DACTYLON + PASPALUM NOTATUM. (THERE IS TO BE NO GREEN DYE OR TERRAM COVER TO BE USED WITHIN COUNTRY PARK TO AVOID ANY POLLUTANTS TO PARK)

PLANT SCHEDULE:

Woodland mix 'A'

Shrubs	Botanical Name	Size(mm)Ht.
Ga	Gordonia axillaris	1000mm
Scs	Schima Superba	1000mm
Rt	Rhodomyrtus tomentosa	1000mm
Ms	Melastoma sanguineum	1000mm
Bf	Baeckea frutescens	1000mm
Dp	Dicranopteris pedata	1000mm

Woodland mix 'B'

Shrubs	Botanical Name	Size(mm)Ht.
Sd	Sapium discolor	1000mm
Rc	Rhus chinensis	1000mm
Ls	Litsea rotundifolia	1000mm
Mch	Machilus chinensis	1000mm

Woodland mix 'C'

Shrubs	Botanical Name	Size(mm)Ht.
Mc	Melastoma candidum	1000mm
Mpan	Microcos paniculata	1000mm
Ri	Rhaphiolepis indica	1000mm
Ss	Sapium sebiferum	1000mm
Sh	Schefflera heptaphylla	1000mm
Mp	Mallotus paniculatus	1000mm

REVISION	DESCRIPTION	BY	DATE	APPROVED

前田建設工業株式会社
 Maeda Corporation
 1901-5 NEW EAST OCEAN CENTRE
 9 SCIENCE MUSEUM ROAD
 T.S.T. EAST, KOWLOON, HONG KONG
 TEL.: 2589 6287 FAX: 2724 4084

地鐵公司
 MTR Corporation
 MTR TOWER
 TELFORD PLAZA - KOWLOON BAY
 HONG KONG
 TEL.: 2988 2111 FAX: 2798 9822


東涌吊車
 TUNG CHUNG CABLE CAR

凱達柏濶有限公司
 Aedas Limited

TITLE

RESCUE TRAIL FROM TOWER 3 TO TOWER 4 AND
 HELICOPTER TOUCH-DOWN POINT
 LANDSCAPE PLANTING PLAN

SCALE	1 : 250 @ A1	CAD REF.	AS BUILT
DATE	FEB. 2005	DWG NO.	AS BUILT
DRAWN	WL	DESIGNED	JW
CHECKED	JW	APPROVED	SF
DRAWING NO.		REV	
LP-R-05		B	

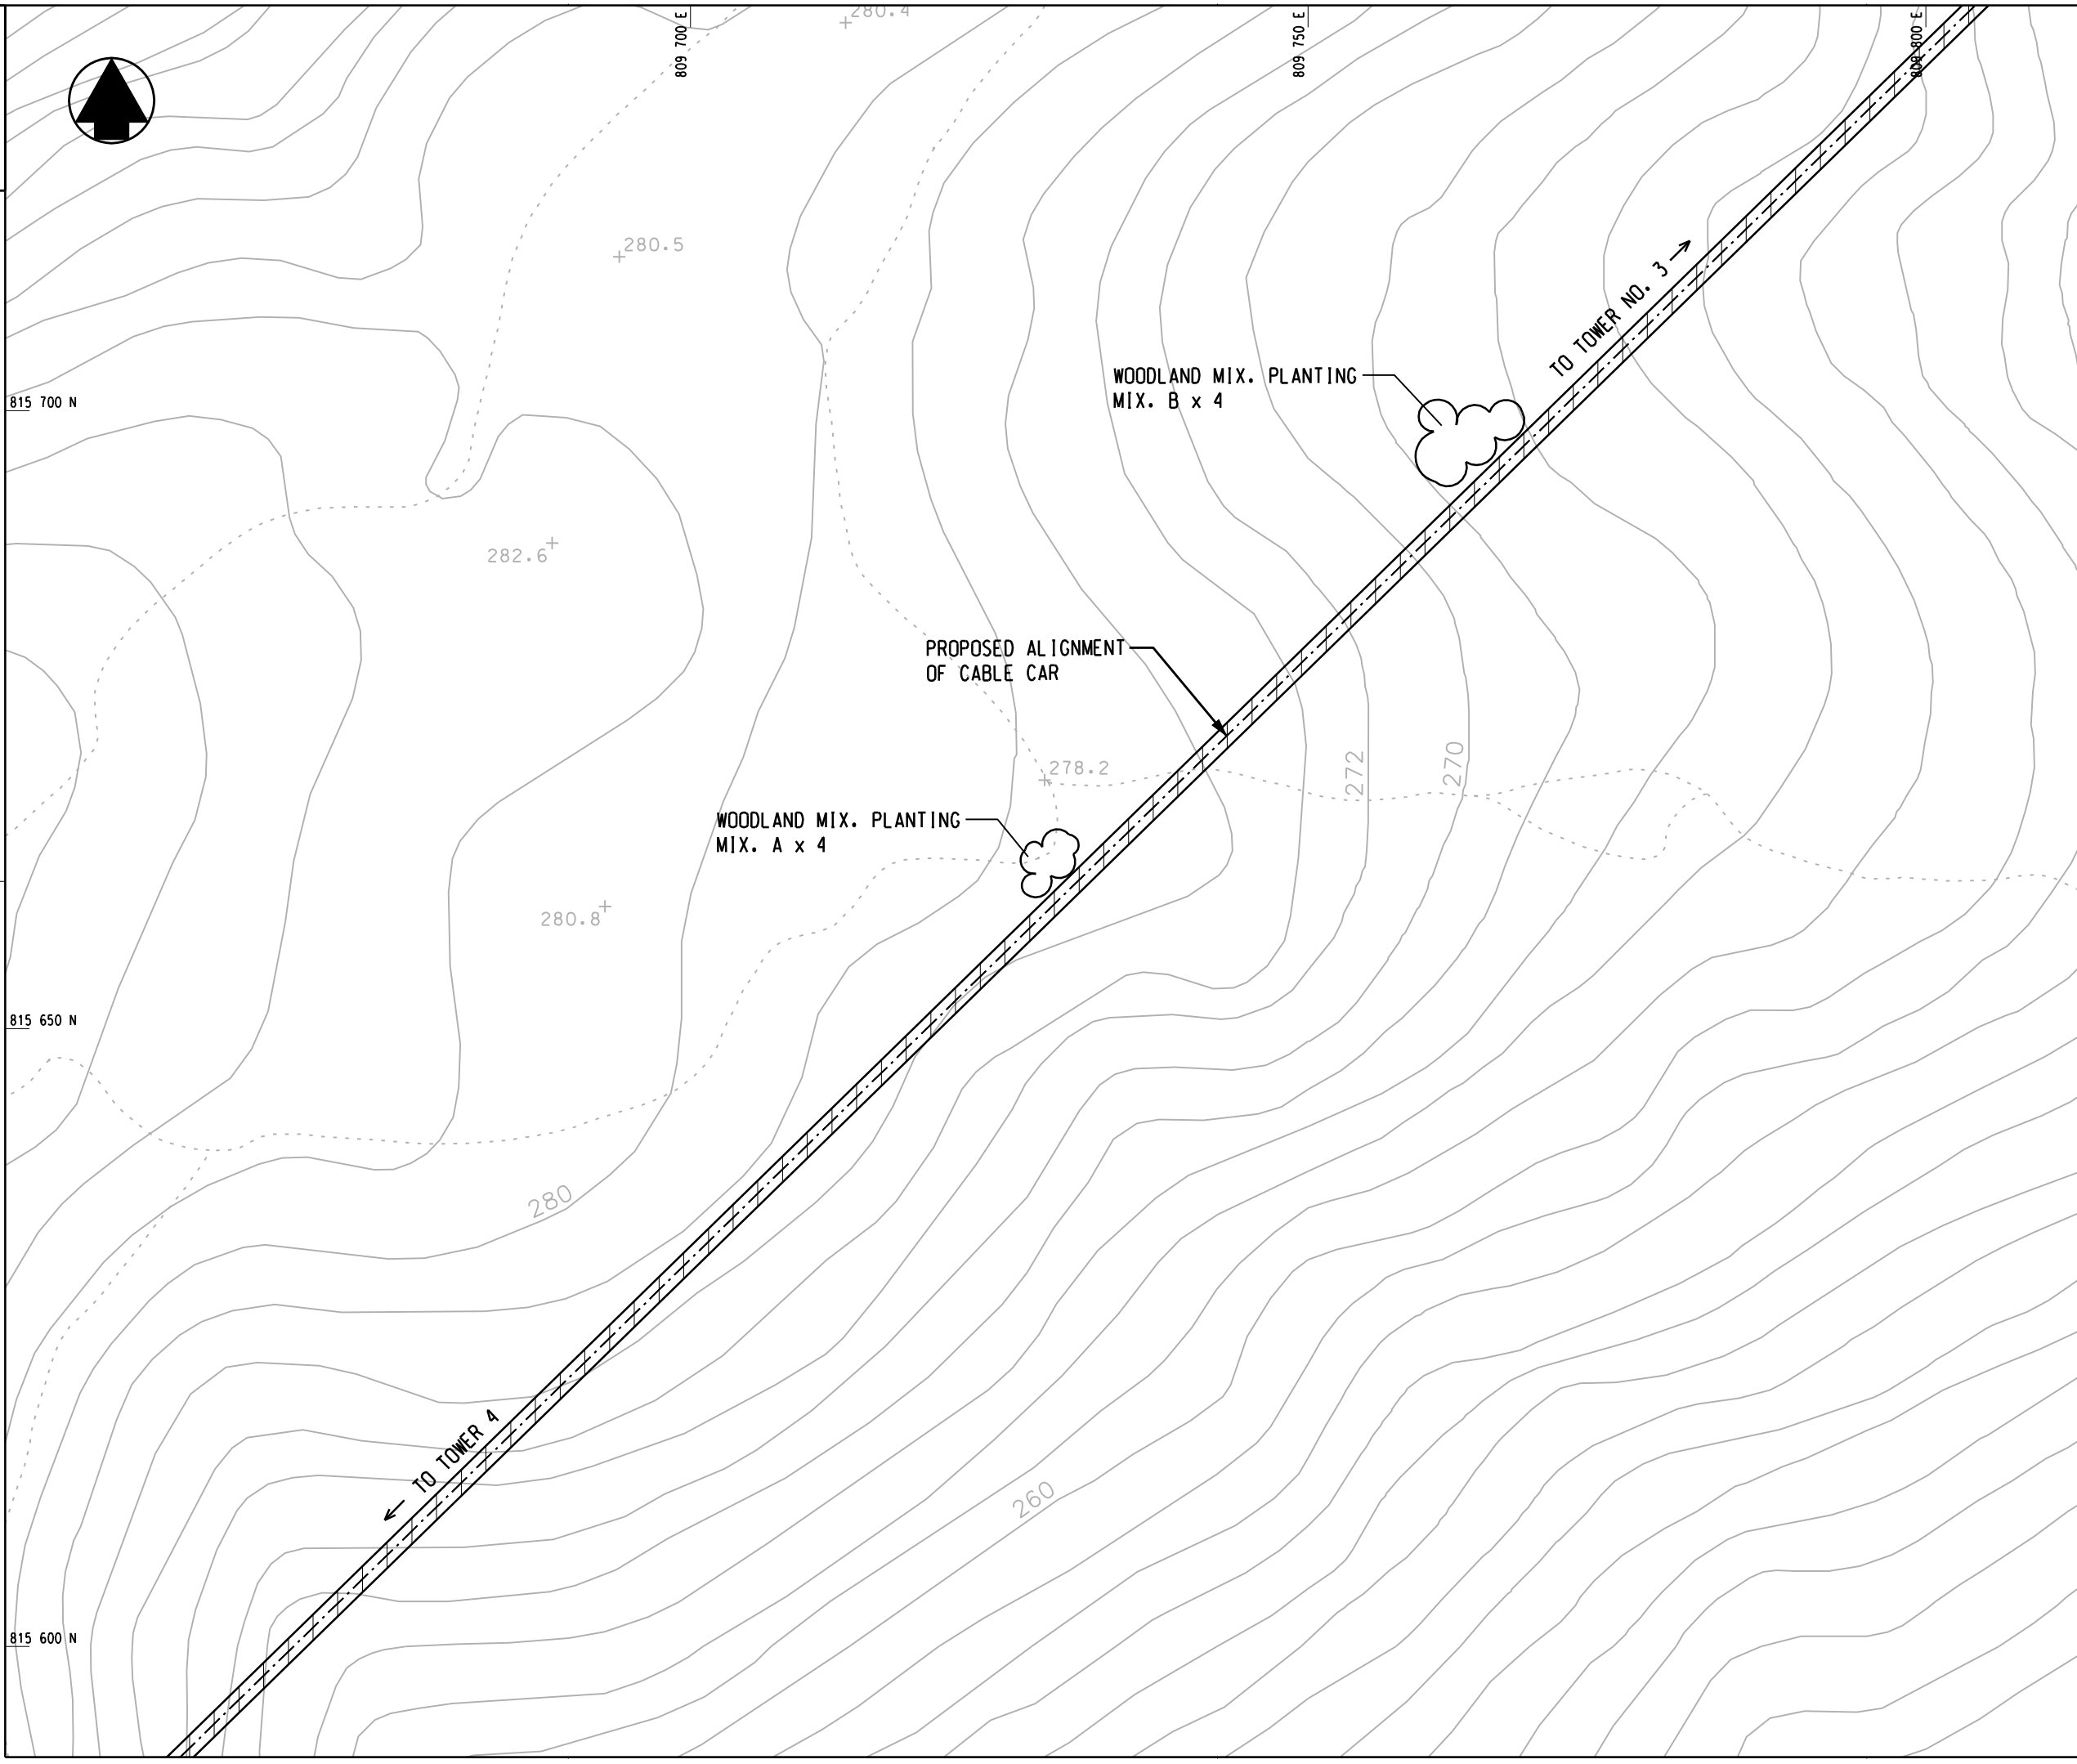

NO PART SHALL BE REPRODUCED OR TRANSMITTED IN ANY FORM OR BY ANY MEANS, ELECTRONIC OR MECHANICAL, WITHOUT THE WRITTEN PERMISSION OF THE MTR CORPORATION LIMITED.

- LEGENDS:**
- WORKS SITE
 - NEW TREE PLANTING
 - RETAINED TREE
 - TRANSPLANTED TREE
 - PLANTING AREA
 - RETAINED WOODLAND

NOTES:

ALL AREAS TO BE HYDROSEEDED PRIOR TO PLANTING WORKS TO ASSIST EROSION CONTROL. HYDROSEED MIX TO CONSIST OF CYNODON DACTYLON + PASPALUM NOTATUM. (THERE IS TO BE NO GREEN DYE OR TERRAM COVER TO BE USED WITHIN COUNTRY PARK TO AVOID ANY POLLUTANTS TO PARK)

PLANT SCHEDULE:

Woodland mix 'A'

Shrubs	Botanical Name	Size(mm)Ht.
Ga	Gordonia axillaris	1000mm
Scs	Schima Superba	1000mm
Rt	Rhodomyrtus tomentosa	1000mm
Ms	Melastoma sanguineum	1000mm
Bf	Baeckea frutescens	1000mm
Dp	Dicranopteris pedata	1000mm

Woodland mix 'B'

Sd	Sapium discolor	1000mm
Rc	Rhus chinensis	1000mm
Ls	Litsea rotundifolia	1000mm
Mch	Machilus chinensis	1000mm

Woodland mix 'C'

Mc	Melastoma candidum	1000mm
Mpan	Microcos paniculata	1000mm
Ri	Rhaphiolepis Indica	1000mm
Ss	Sapium sebiferum	1000mm
Sh	Schefflera heptaphylla	1000mm
Mp	Mallotus paniculatus	1000mm

REVISION	DESCRIPTION	BY	DATE	APPROVED

前田建設工業株式会社
 Maeda Corporation
 1001-5 NEW EAST OCEAN CENTRE
 9 SCIENCE MUSEUM ROAD
 T.S.T. EAST, KOWLOON, HONG KONG
 TEL.: 2599 0287 FAX.: 2724 4084

地鐵公司
 MTR Corporation
 MTR TOWER
 TELFORD PLAZA - KOWLOON BAY
 HONG KONG
 TEL.: 2988 2111 FAX.: 2798 9822

東涌吊車
 TUNG CHUNG CABLE CAR


凱達柏濶有限公司
 Aedas Limited

TITLE

RESCUE TRAIL FROM TOWER 3 TO TOWER 4
LANDSCAPE PLANTING PLAN

SCALE	1 : 250 @ A1	CAD REF	AS BUILT
DATE	FEB. 2005	AS BUILT	DWG NO
DRAWN	WL	DESIGNED	JW
CHECKED	JW	APPROVED	SF
DRAWING NO	LP-R-06	REV	A

DRAWING NO. LP-R-07

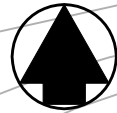

NO PART SHALL BE REPRODUCED OR TRANSMITTED IN ANY FORM OR BY ANY MEANS, ELECTRONIC OR MECHANICAL, WITHOUT THE WRITTEN PERMISSION OF THE MTR CORPORATION LIMITED.

- LEGENDS:**
- WORKS SITE
 - NEW TREE PLANTING
 - RETAINED TREE
 - TRANSPLANTED TREE
 - PLANTING AREA
 - RETAINED WOODLAND

NOTES:

ALL AREAS TO BE HYDROSEEDED PRIOR TO PLANTING WORKS TO ASSIST EROSION CONTROL. HYDROSEED MIX TO CONSIST OF CYNODON DACTYLON + PASPALUM NOTATUM. (THERE IS TO BE NO GREEN DYE OR TERRAM COVER TO BE USED WITHIN COUNTRY PARK TO AVOID ANY POLLUTANTS TO PARK)

REVISION	DESCRIPTION	BY	DATE	APPROVED

前田建設工業株式会社
 Maeda Corporation
 1001-5 NEW EAST OCEAN CENTRE
 9 SCIENCE MUSEUM ROAD
 T.S.T. EAST, KOWLOON, HONG KONG
 TEL.: 2599 6287 FAX.: 2724 4084

地鐵公司
 MTR Corporation
 MTR TOWER
 TELFORD PLAZA - KOWLOON BAY
 HONG KONG
 TEL.: 2983 2111 FAX.: 2798 9822

PROJECT **東涌吊車**
 TUNG CHUNG CABLE CAR


ORIGINATOR **凱達柏濶有限公司**
 Aedas Limited

TITLE

RESCUE TRAIL FROM TOWER 3 TO TOWER 4

LANDSCAPE PLANTING PLAN

SCALE	1 : 250 @ A1	CAD REF	AS BUILT	APPROVED
DATE	FEB. 2005	AS BUILT	DWG NO	
DRAWN	WL	DESIGNED	JW	DRAWING NO
CHECKED	JW	APPROVED	SF	LP-R-07
				REV
				A

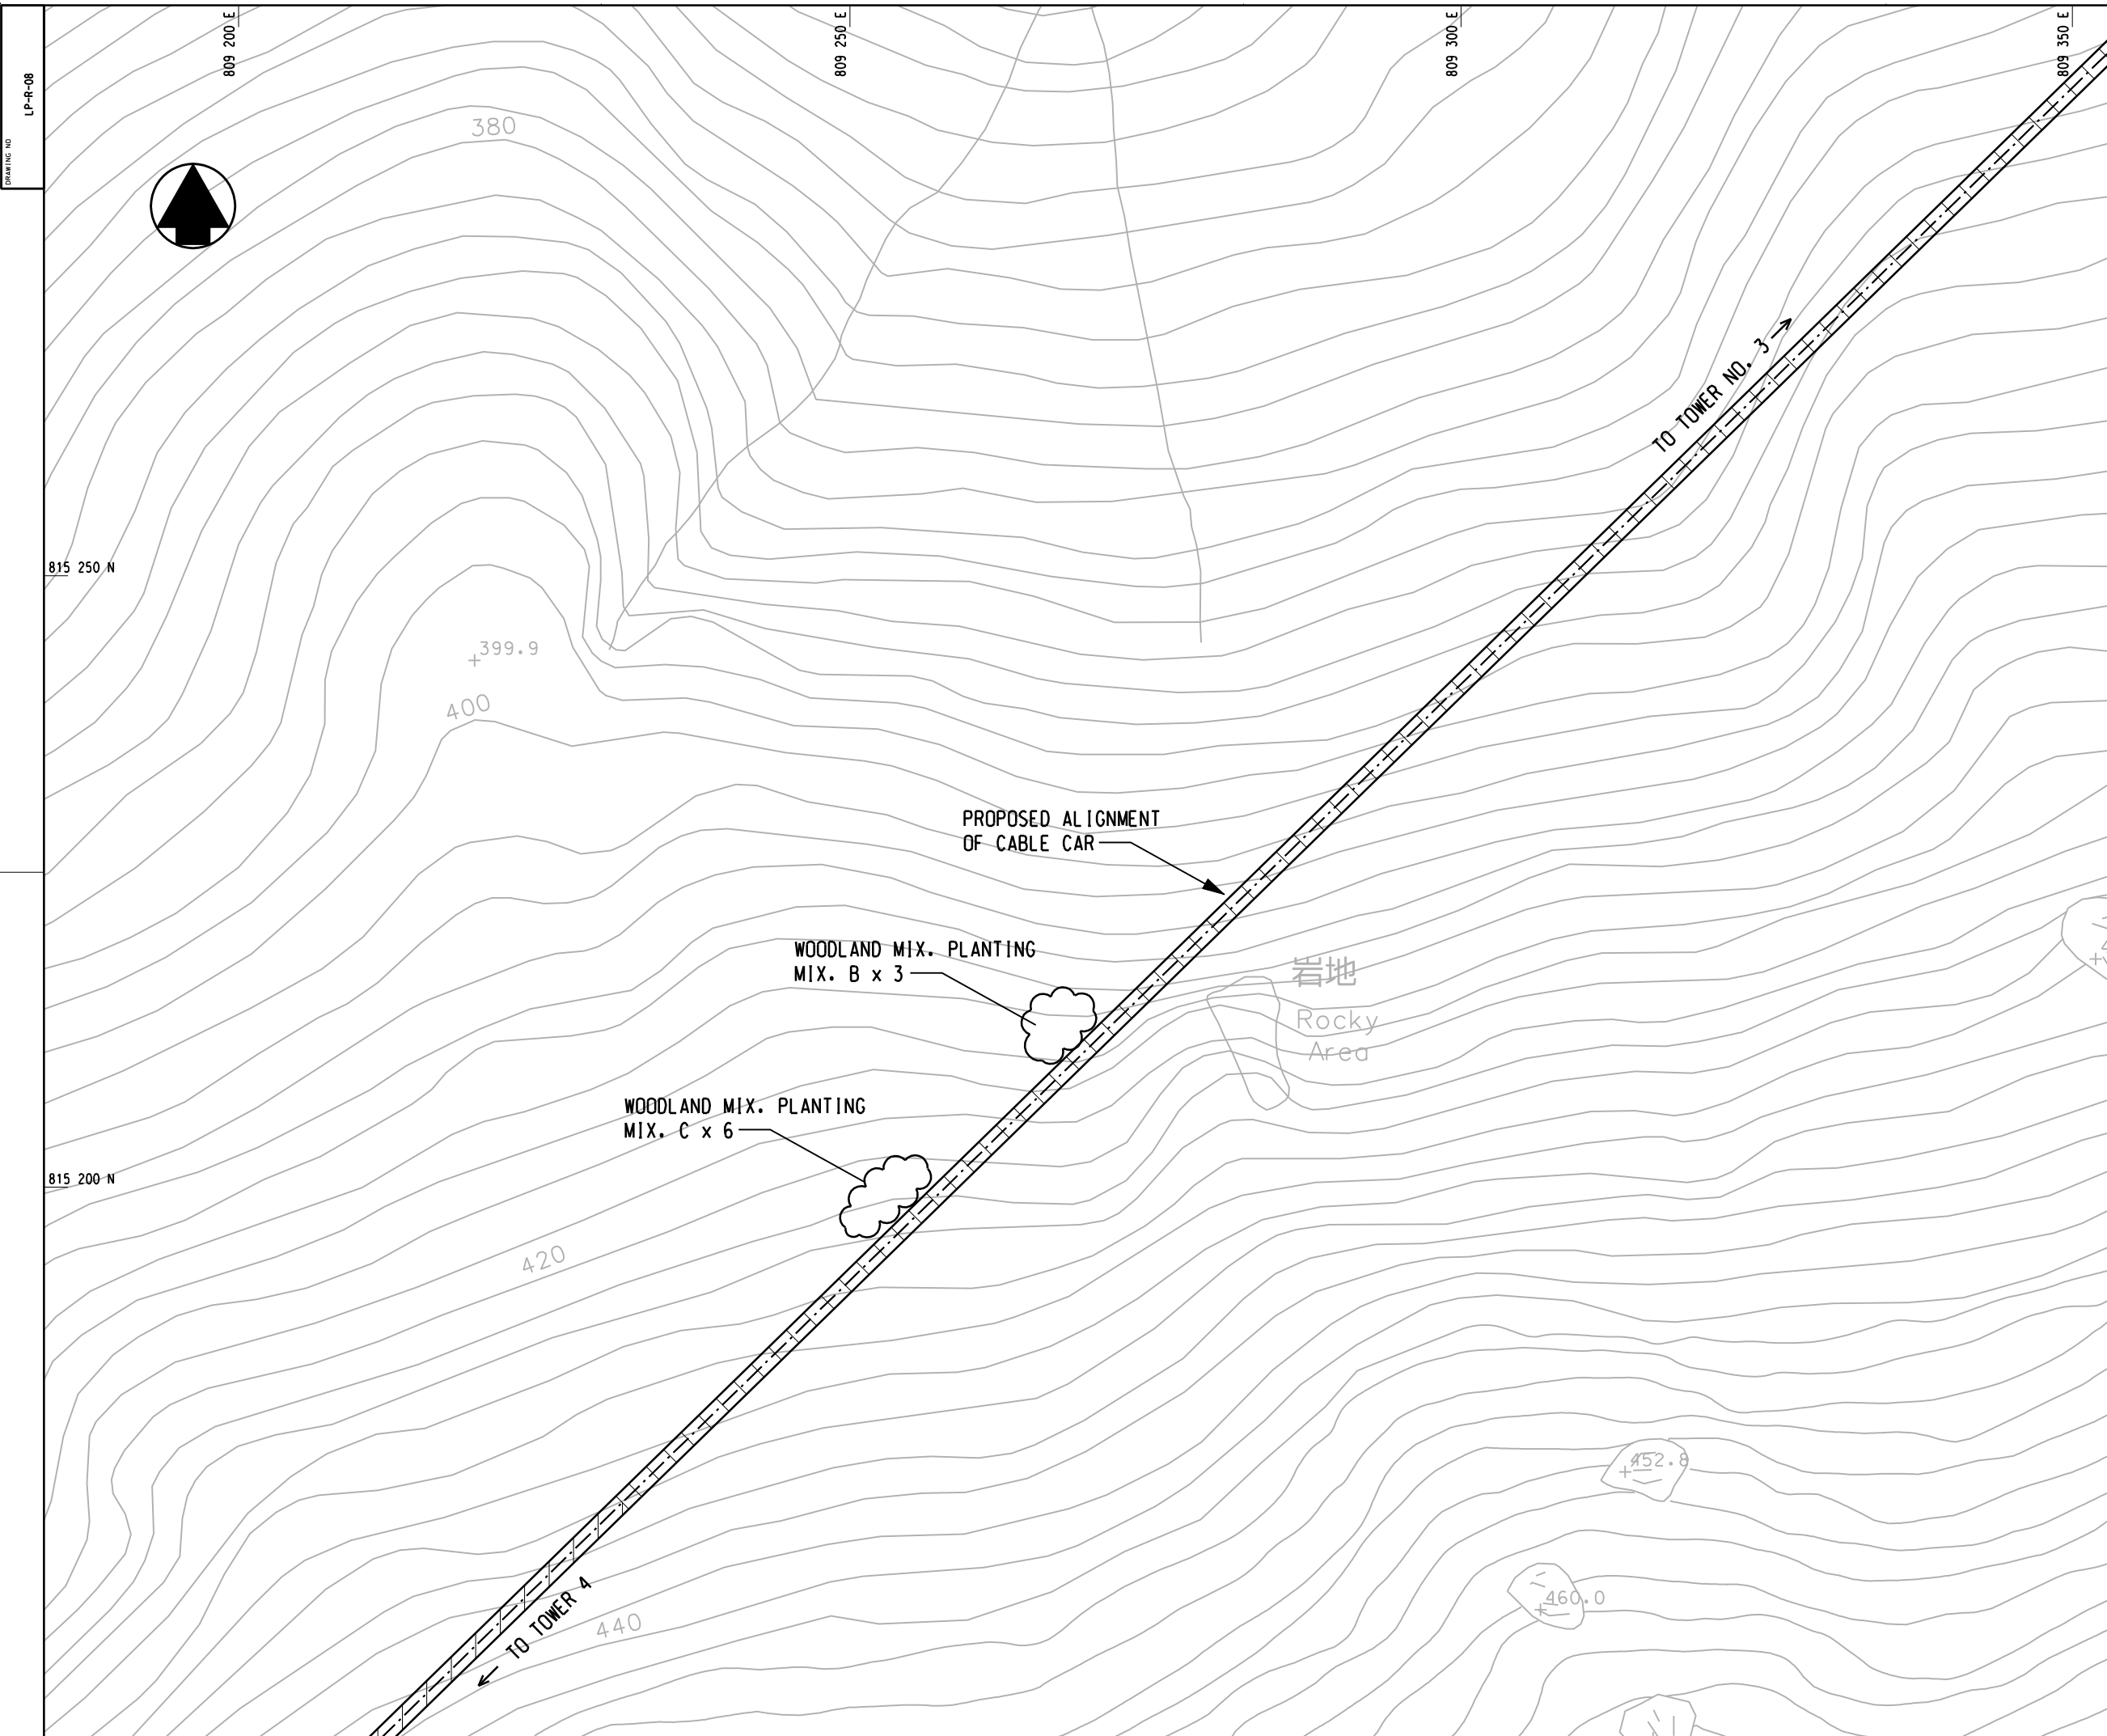

DRAWING NO. LP-R-08

NO. OF SCALE SHEETS: SEVEN (7) SHEETS IN ALL
 © 2005 HONG KONG CABLE CAR CORPORATION
 PREPARED ON BEHALF OF THE COMPANY / PREPARED BY THE HONG KONG CABLE CAR CORPORATION
 ALL RIGHTS RESERVED. NO PART OF THIS DRAWING IS TO BE REPRODUCED OR TRANSMITTED IN ANY FORM OR BY ANY MEANS, ELECTRONIC OR MECHANICAL, WITHOUT THE WRITTEN CONSENT OF THE HONG KONG CABLE CAR CORPORATION.

- LEGENDS:**
- WORKS SITE
 - NEW TREE PLANTING
 - RETAINED TREE
 - TRANSPLANTED TREE
 - PLANTING AREA
 - RETAINED WOODLAND

NOTES:

ALL AREAS TO BE HYDROSEED PRIOR TO PLANTING WORKS TO ASSIST EROSION CONTROL. HYDROSEED MIX TO CONSIST OF CYNODON DACTYLON + PASPALUM NOTATUM. (THERE IS TO BE NO GREEN DYE OR TERRAM COVER TO BE USED WITHIN COUNTRY PARK TO AVOID ANY POLLUTANTS TO PARK)

PLANT SCHEDULE:

Woodland mix 'A'

Shrubs	Botanical Name	Size(mm)Ht.
Ga	Gordonia axillaris	1000mm
Scs	Schima Superba	1000mm
Rt	Rhodomyrtus tomentosa	1000mm
Ms	Melastoma sanguineum	1000mm
Bf	Baeckea frutescens	1000mm
Dp	Dicranopteris pedata	1000mm

Woodland mix 'B'

Sd	Sapium discolor	1000mm
Rc	Rhus chinensis	1000mm
Ls	Litsea rotundifolia	1000mm
Mch	Machilus chinensis	1000mm

Woodland mix 'C'

Mc	Melastoma candidum	1000mm
Mpan	Microcos paniculata	1000mm
Ri	Rhaphiolepis indica	1000mm
Ss	Sapium sebiferum	1000mm
Sh	Schefflera heptaphylla	1000mm
Mp	Mallotus paniculatus	1000mm

REVISION	DESCRIPTION	BY	DATE	APPROVED

前田建設工業株式会社
 Maeda Corporation
 1001-5 NEW EAST OCEAN CENTRE
 9 SCIENCE MUSEUM ROAD
 T.S.T. EAST, KOWLOON, HONG KONG
 TEL.: 2268 0287 FAX.: 2264 4084

MTR TOWER
 TELFORD PLAZA - KOWLOON BAY
 HONG KONG
 TEL.: 2988 2111 FAX.: 2798 9822

東涌吊車
 TUNG CHUNG CABLE CAR

凱達柏濤有限公司
 Aedas Limited

TITLE

RESCUE TRAIL FROM TOWER 3 TO TOWER 4
 LANDSCAPE PLANTING PLAN

SCALE	1 : 250 @ A1	CAD REF.	AS BUILT
DATE	FEB. 2005	AS BUILT DWG NO.	
DRAWN	WL	DESIGNED	JW
CHECKED	JW	APPROVED	SF
DRAWING NO.	LP-R-08	REV	A

DRAWING NO.

LP-R-09

E 809150

E 809200

E 809250

N 813090

N 813130

N 813180




← NGONG PING
CABLE CAR ALIGNMENT

→ TUNG CHUNG
CABLE CAR ALIGNMENT

PARK

Rocky Area

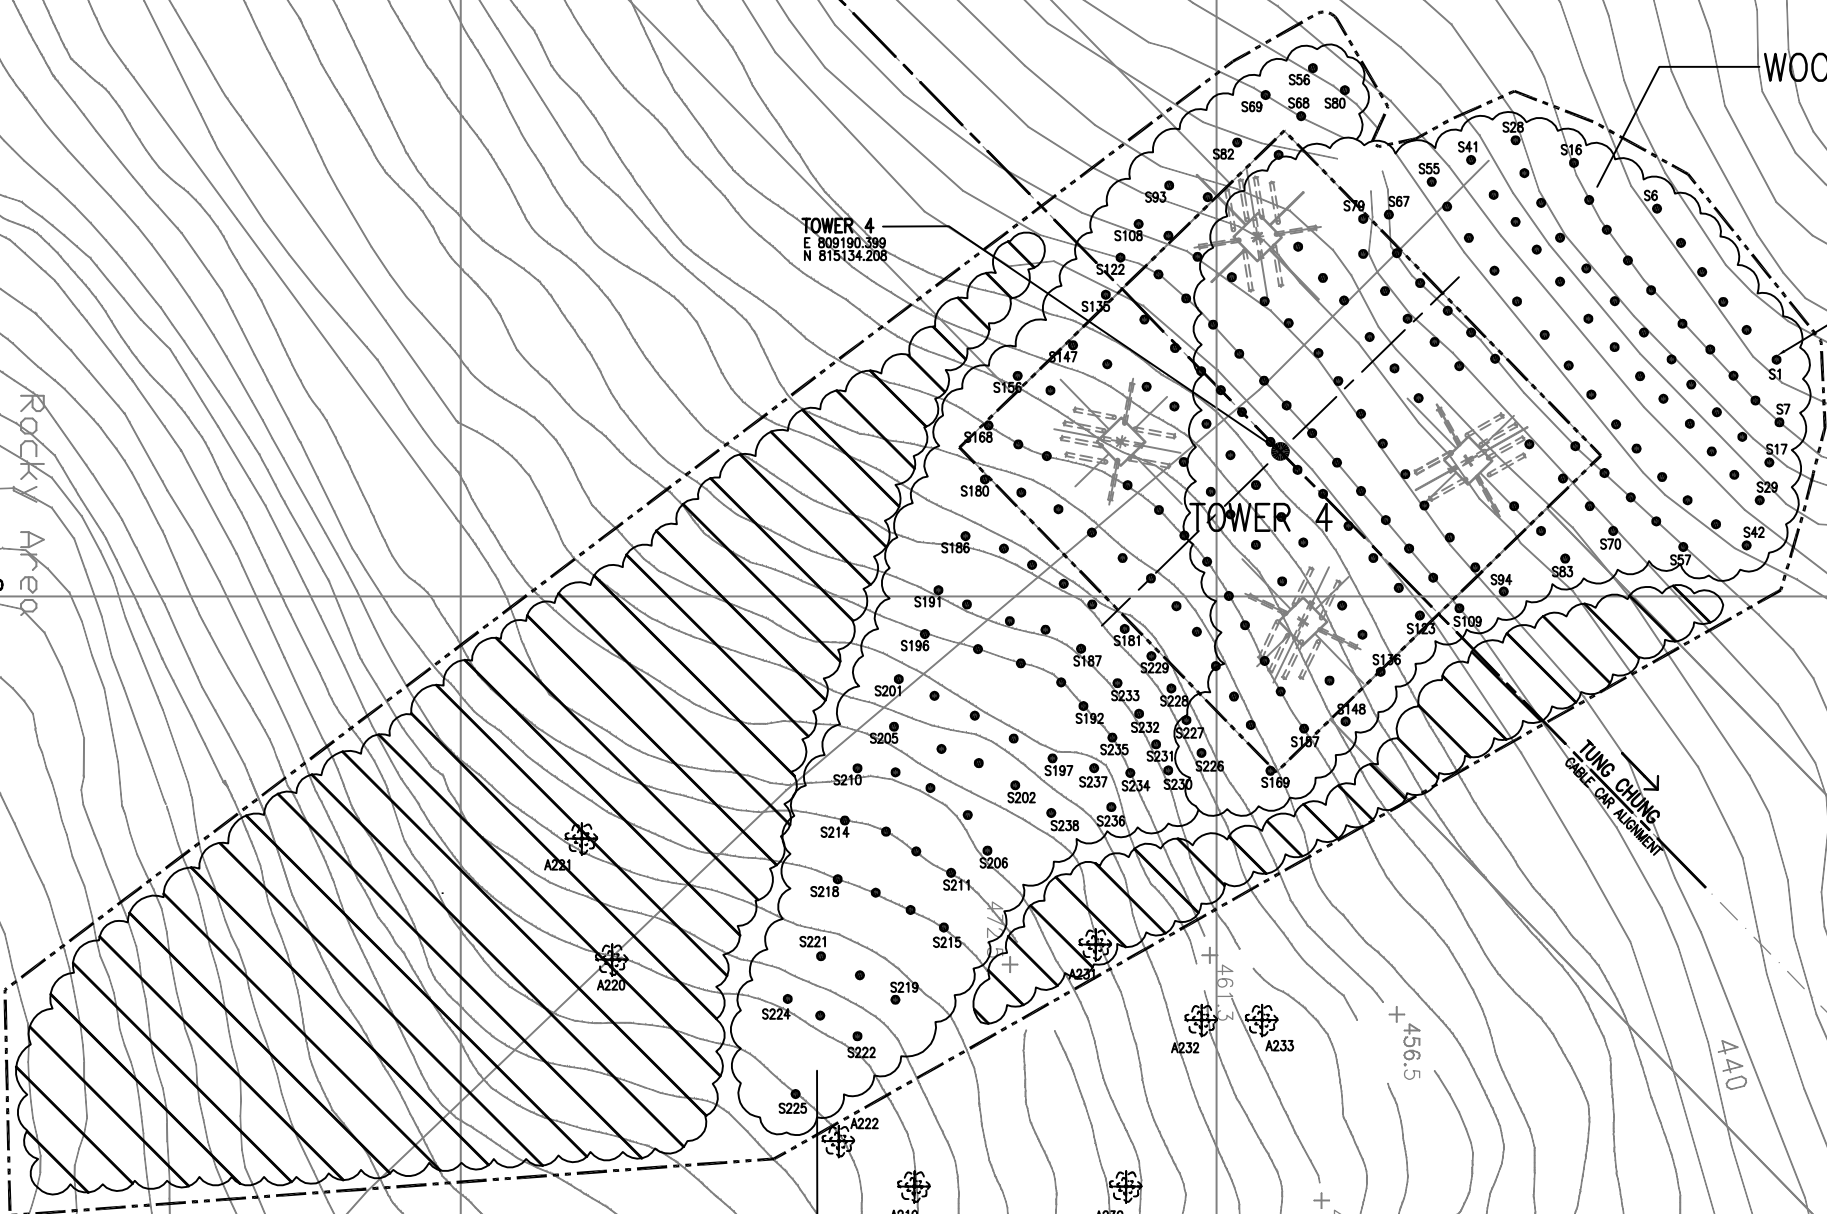

WOODLAND MIX. (A)

WOODLAND MIX.
(A)+(C)

TOWER 4
E 809190.399
N 815134.208

FIRST NAIL
E 809184.331
N 815167.028

TOWER 4

DO NOT SCALE DRAWING. VERIFY ALL DIMENSIONS ON SITE.
© MTR CORPORATION LIMITED 2003
COPYRIGHT IN RESPECT OF THE DESIGN / SCHEME IS OWNED BY THE MTR CORPORATION LIMITED.
NO PART OF THIS DRAWING IS TO BE REPRODUCED OR TRANSMITTED IN ANY FORM OR BY ANY MEANS, ELECTRONIC OR MECHANICAL, WITHOUT THE WRITTEN CONSENT OF THE MTR CORPORATION LIMITED.

LEGEND:

- WORKS SITE
- NEW TREE PLANTING
- ⊗ RETAINED TREE
- ⊗ TRANSPLANTED TREE
- ☁ PLANTING AREA
- ▨ RETAINED WOODLAND
- S1 LOCATION OF SOIL NAIL
- ⊕ P4 TOWER BASE NO.
- ⊕ A219 PROTECTED TREES

NOTES:

ALL AREAS TO BE HYDROSEED PRIOR TO PLANTING WORKS TO ASSIST EROSION CONTROL. HYDROSEED MIX TO CONSIST OF CYNODON DACTYLON + PASPALUM NOTATUM. (THERE IS TO BE NO GREEN DYE OR TERRAM COVER TO BE USED WITHIN COUNTRY PARK TO AVOID ANY POLLUTANTS TO PARK)

PLANT SCHEDULE:

Woodland mix 'A'		
Shrubs	Botanical Name	Size(mm)Ht.
Ga	Gordonia axillaris	1000mm
Scs	Schima Superba	1000mm
Rt	Rhodomyrtus tomentosa	1000mm
Ms	Melastoma sanguineum	1000mm
Bf	Baeckea frutescens	1000mm
Dp	Dicranopteris pedata	1000mm

Woodland mix 'B'		
Shrubs	Botanical Name	Size(mm)Ht.
Sd	Sapium discolor	1000mm
Rc	Rhus chinensis	1000mm
Ls	Litsea rotundifolia	1000mm
Mch	Machilus chinensis	1000mm

Woodland mix 'C'		
Shrubs	Botanical Name	Size(mm)Ht.
Mc	Melastoma candidum	1000mm
Mpan	Microcos paniculata	1000mm
Ri	Rhaphiolepis indica	1000mm
Ss	Sapium sebiferum	1000mm
Sh	Schefflera heptaphylla	1000mm
Mp	Mallotus paniculatus	1000mm

REVISION	DESCRIPTION	BY	DATE	APPROVED


地鐵公司
MTR Corporation
 MTR TOWER
 TELFORD PLAZA - KOWLOON BAY
 HONG KONG
 TEL : 2993 2111 FAX : 2798 8822

TUNG CHUNG CABLE CAR

CONTRACTOR **MAEDA CORPORATION**
 ORIGINATOR

TITLE
TOWER 4
LANDSCAPE PLANTING PLAN

SCALE	1 : 250	CAD REF	AS BUILT APPROVED
DATE	14A MAY 2004	AS BUILT DWG NO	
DRAWN	AL	DESIGNED	JH
CHECKED	JH	APPROVED	ST
DRAWING NO		REV	
LP-R-09		A	

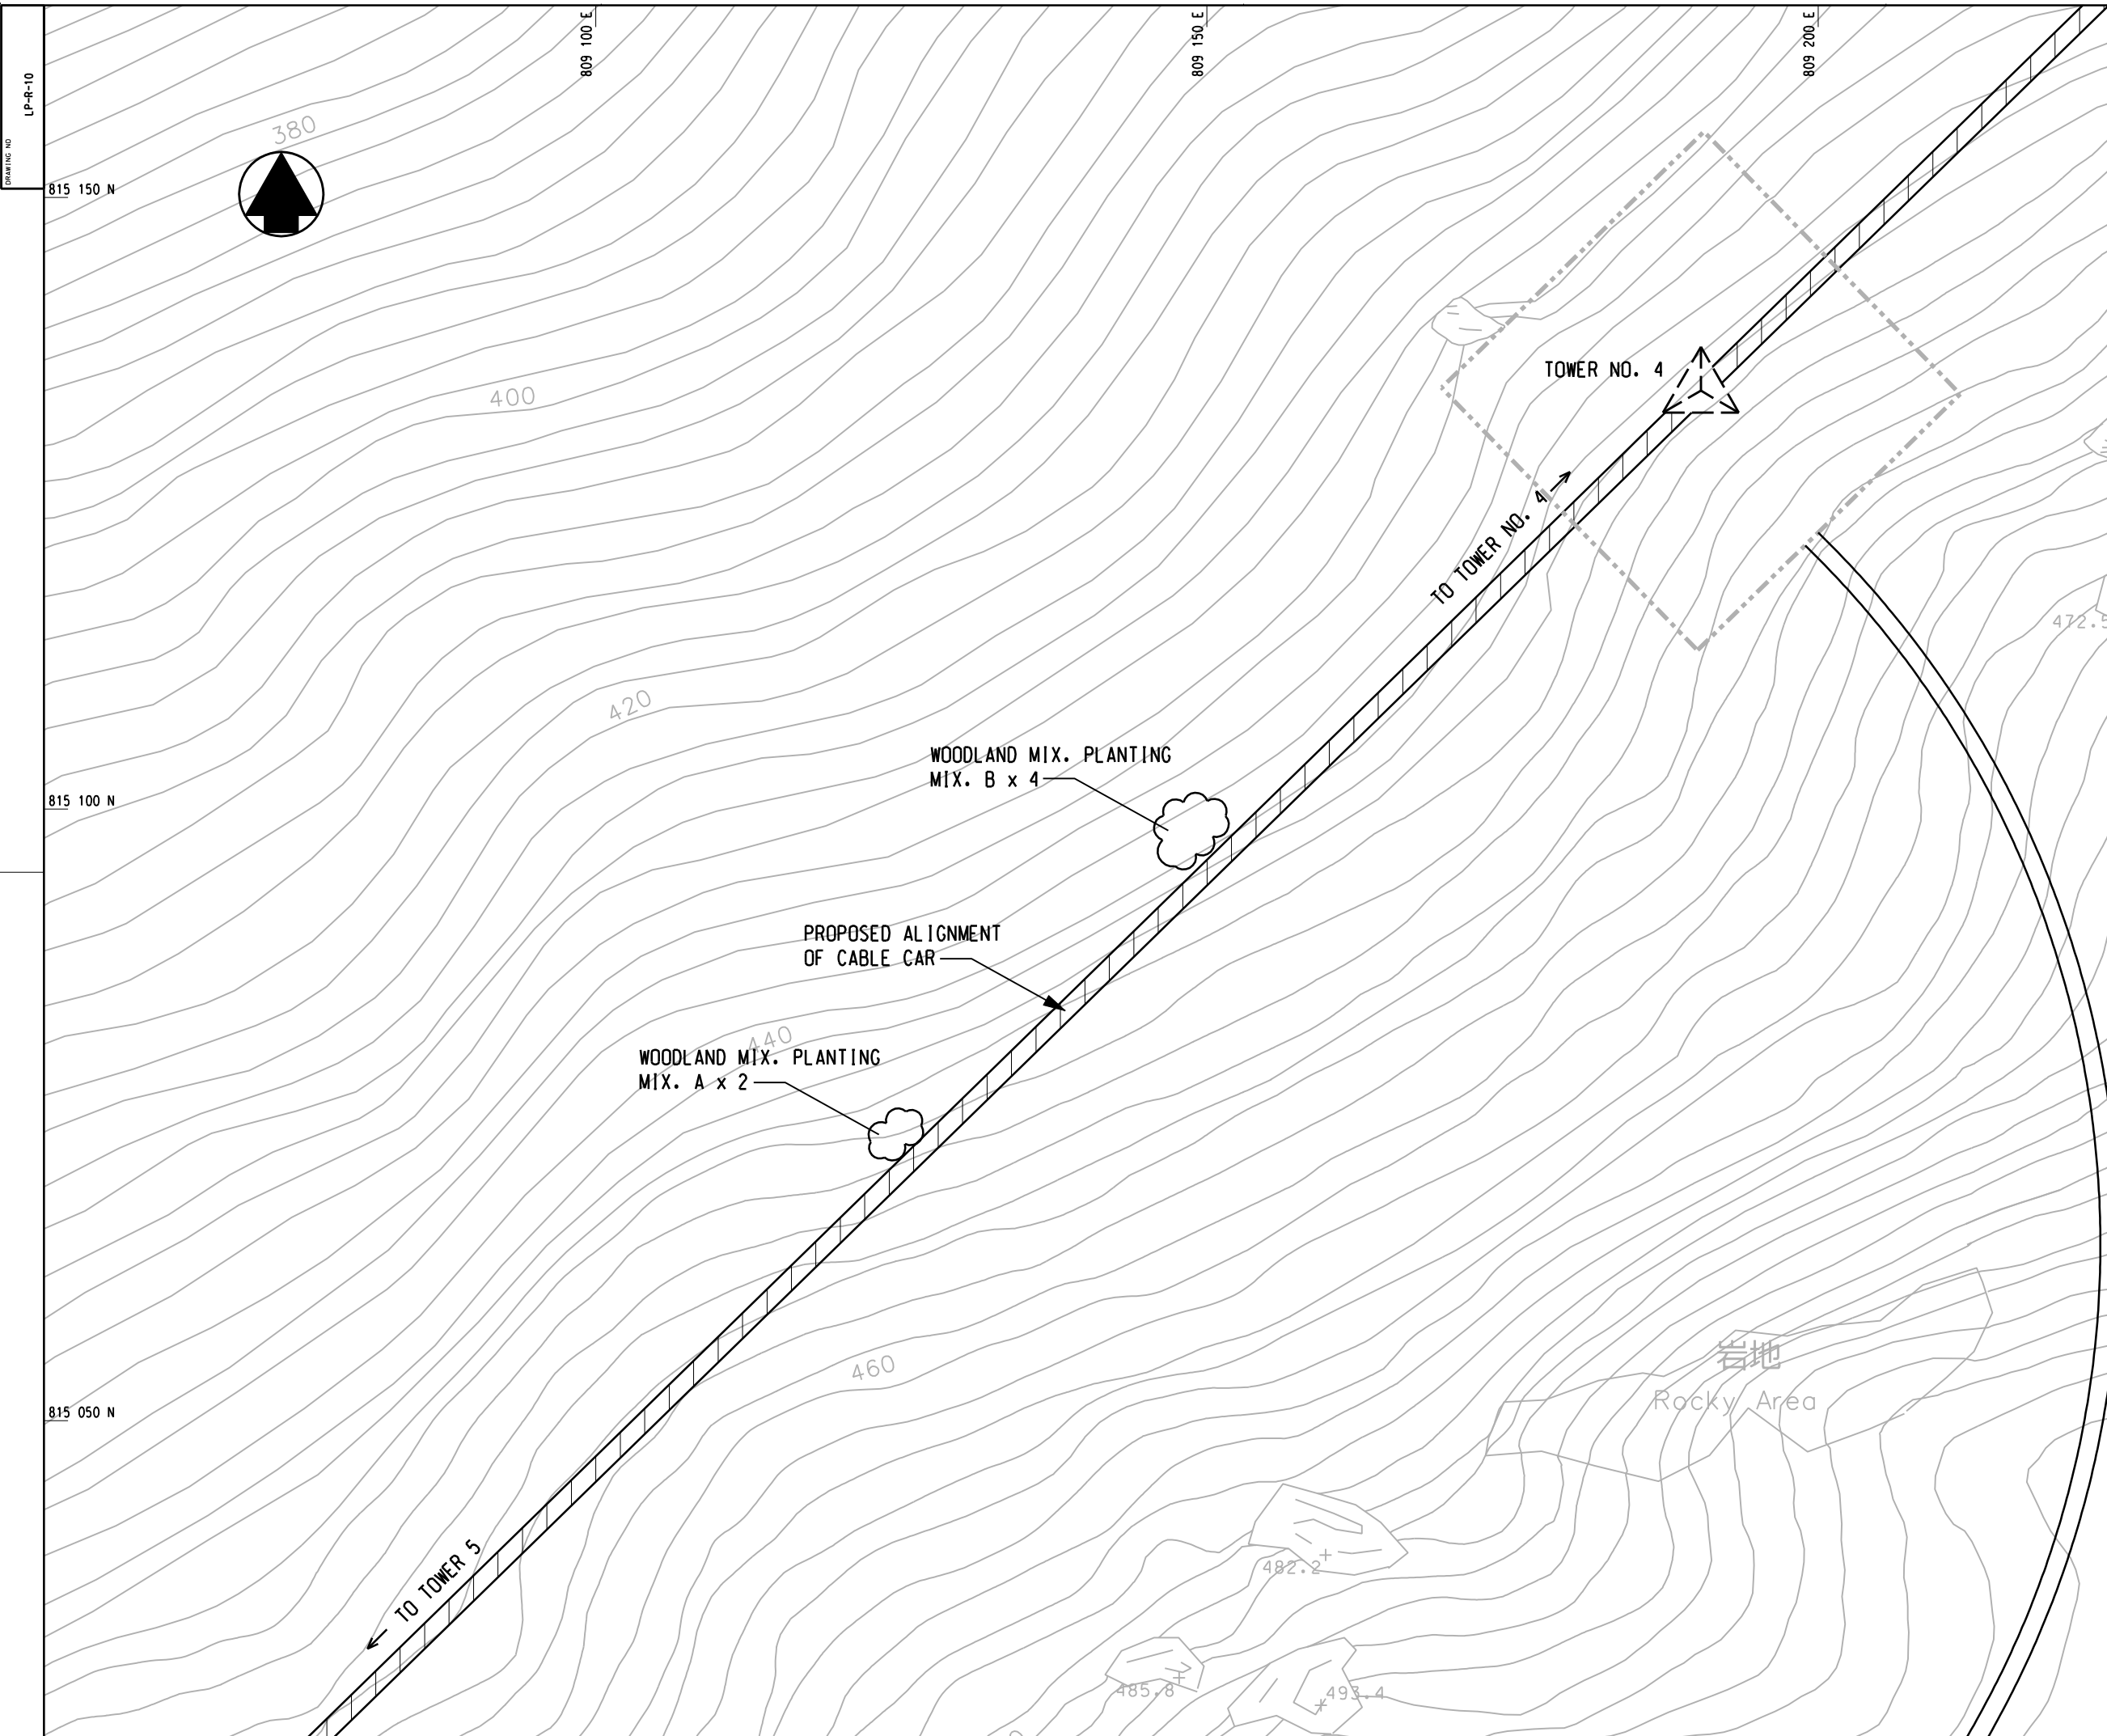

NO PART SHALL BE REPRODUCED OR TRANSMITTED IN ANY FORM OR BY ANY MEANS, ELECTRONIC OR MECHANICAL, INCLUDING PHOTOCOPYING, RECORDING, OR BY ANY INFORMATION STORAGE AND RETRIEVAL SYSTEM, WITHOUT THE WRITTEN PERMISSION OF THE MTR CORPORATION LIMITED.

- LEGENDS:**
- WORKS SITE
 - NEW TREE PLANTING
 - RETAINED TREE
 - TRANSPLANTED TREE
 - ☁ PLANTING AREA
 - ▨ RETAINED WOODLAND

NOTES:

ALL AREAS TO BE HYDROSEED PRIOR TO PLANTING WORKS TO ASSIST EROSION CONTROL. HYDROSEED MIX TO CONSIST OF CYNODON DACTYLON + PASPALUM NOTATUM. (THERE IS TO BE NO GREEN DYE OR TERRAM COVER TO BE USED WITHIN COUNTRY PARK TO AVOID ANY POLLUTANTS TO PARK)

PLANT SCHEDULE:

Woodland mix 'A'

Shrubs	Botanical Name	Size(mm)Ht.
Ga	Gordonia axillaris	1000mm
Scs	Schima Superba	1000mm
Rt	Rhodomyrtus tomentosa	1000mm
Ms	Melastoma sanguineum	1000mm
Bf	Baeckea frutescens	1000mm
Dp	Dicranopteris pedata	1000mm

Woodland mix 'B'

Sd	Sapium discolor	1000mm
Rc	Rhus chinensis	1000mm
Ls	Litsea rotundifolia	1000mm
Mch	Machilus chinensis	1000mm

Woodland mix 'C'

Mc	Melastoma candidum	1000mm
Mpan	Microcos paniculata	1000mm
Ri	Rhaphiolepis indica	1000mm
Ss	Sapium sebiferum	1000mm
Sh	Schefflera heptaphylla	1000mm
Mp	Mallotus paniculatus	1000mm

REVISION	DESCRIPTION	BY	DATE	APPROVED

前田建設工業株式会社
Maeda Corporation
1901-5 NEW EAST OCEAN CENTRE
9 SCIENCE MUSEUM ROAD
T.S.T. EAST, KOWLOON, HONG KONG
TEL : 2589 6287 FAX : 2724 4084


地鐵公司
MTR Corporation
MTR TOWER
TELFORD PLAZA - KOWLOON BAY
HONG KONG
TEL : 2983 2111 FAX : 2798 9822

PROJECT
東涌吊車
TUNG CHUNG CABLE CAR

ORIGINATOR
凱達柏濤有限公司
Aedas Limited

TITLE
RESCUE TRAIL FROM TOWER 4 TO TOWER 5
LANDSCAPE PLANTING PLAN

SCALE	1 : 250 @ A1	CAD REF	AS BUILT
DATE	FEB. 2005	AS BUILT	DWG NO
DRAWN	WL	DESIGNED	JW
CHECKED	JW	APPROVED	SF
DRAWING NO		REV	
LP-R-10		A	

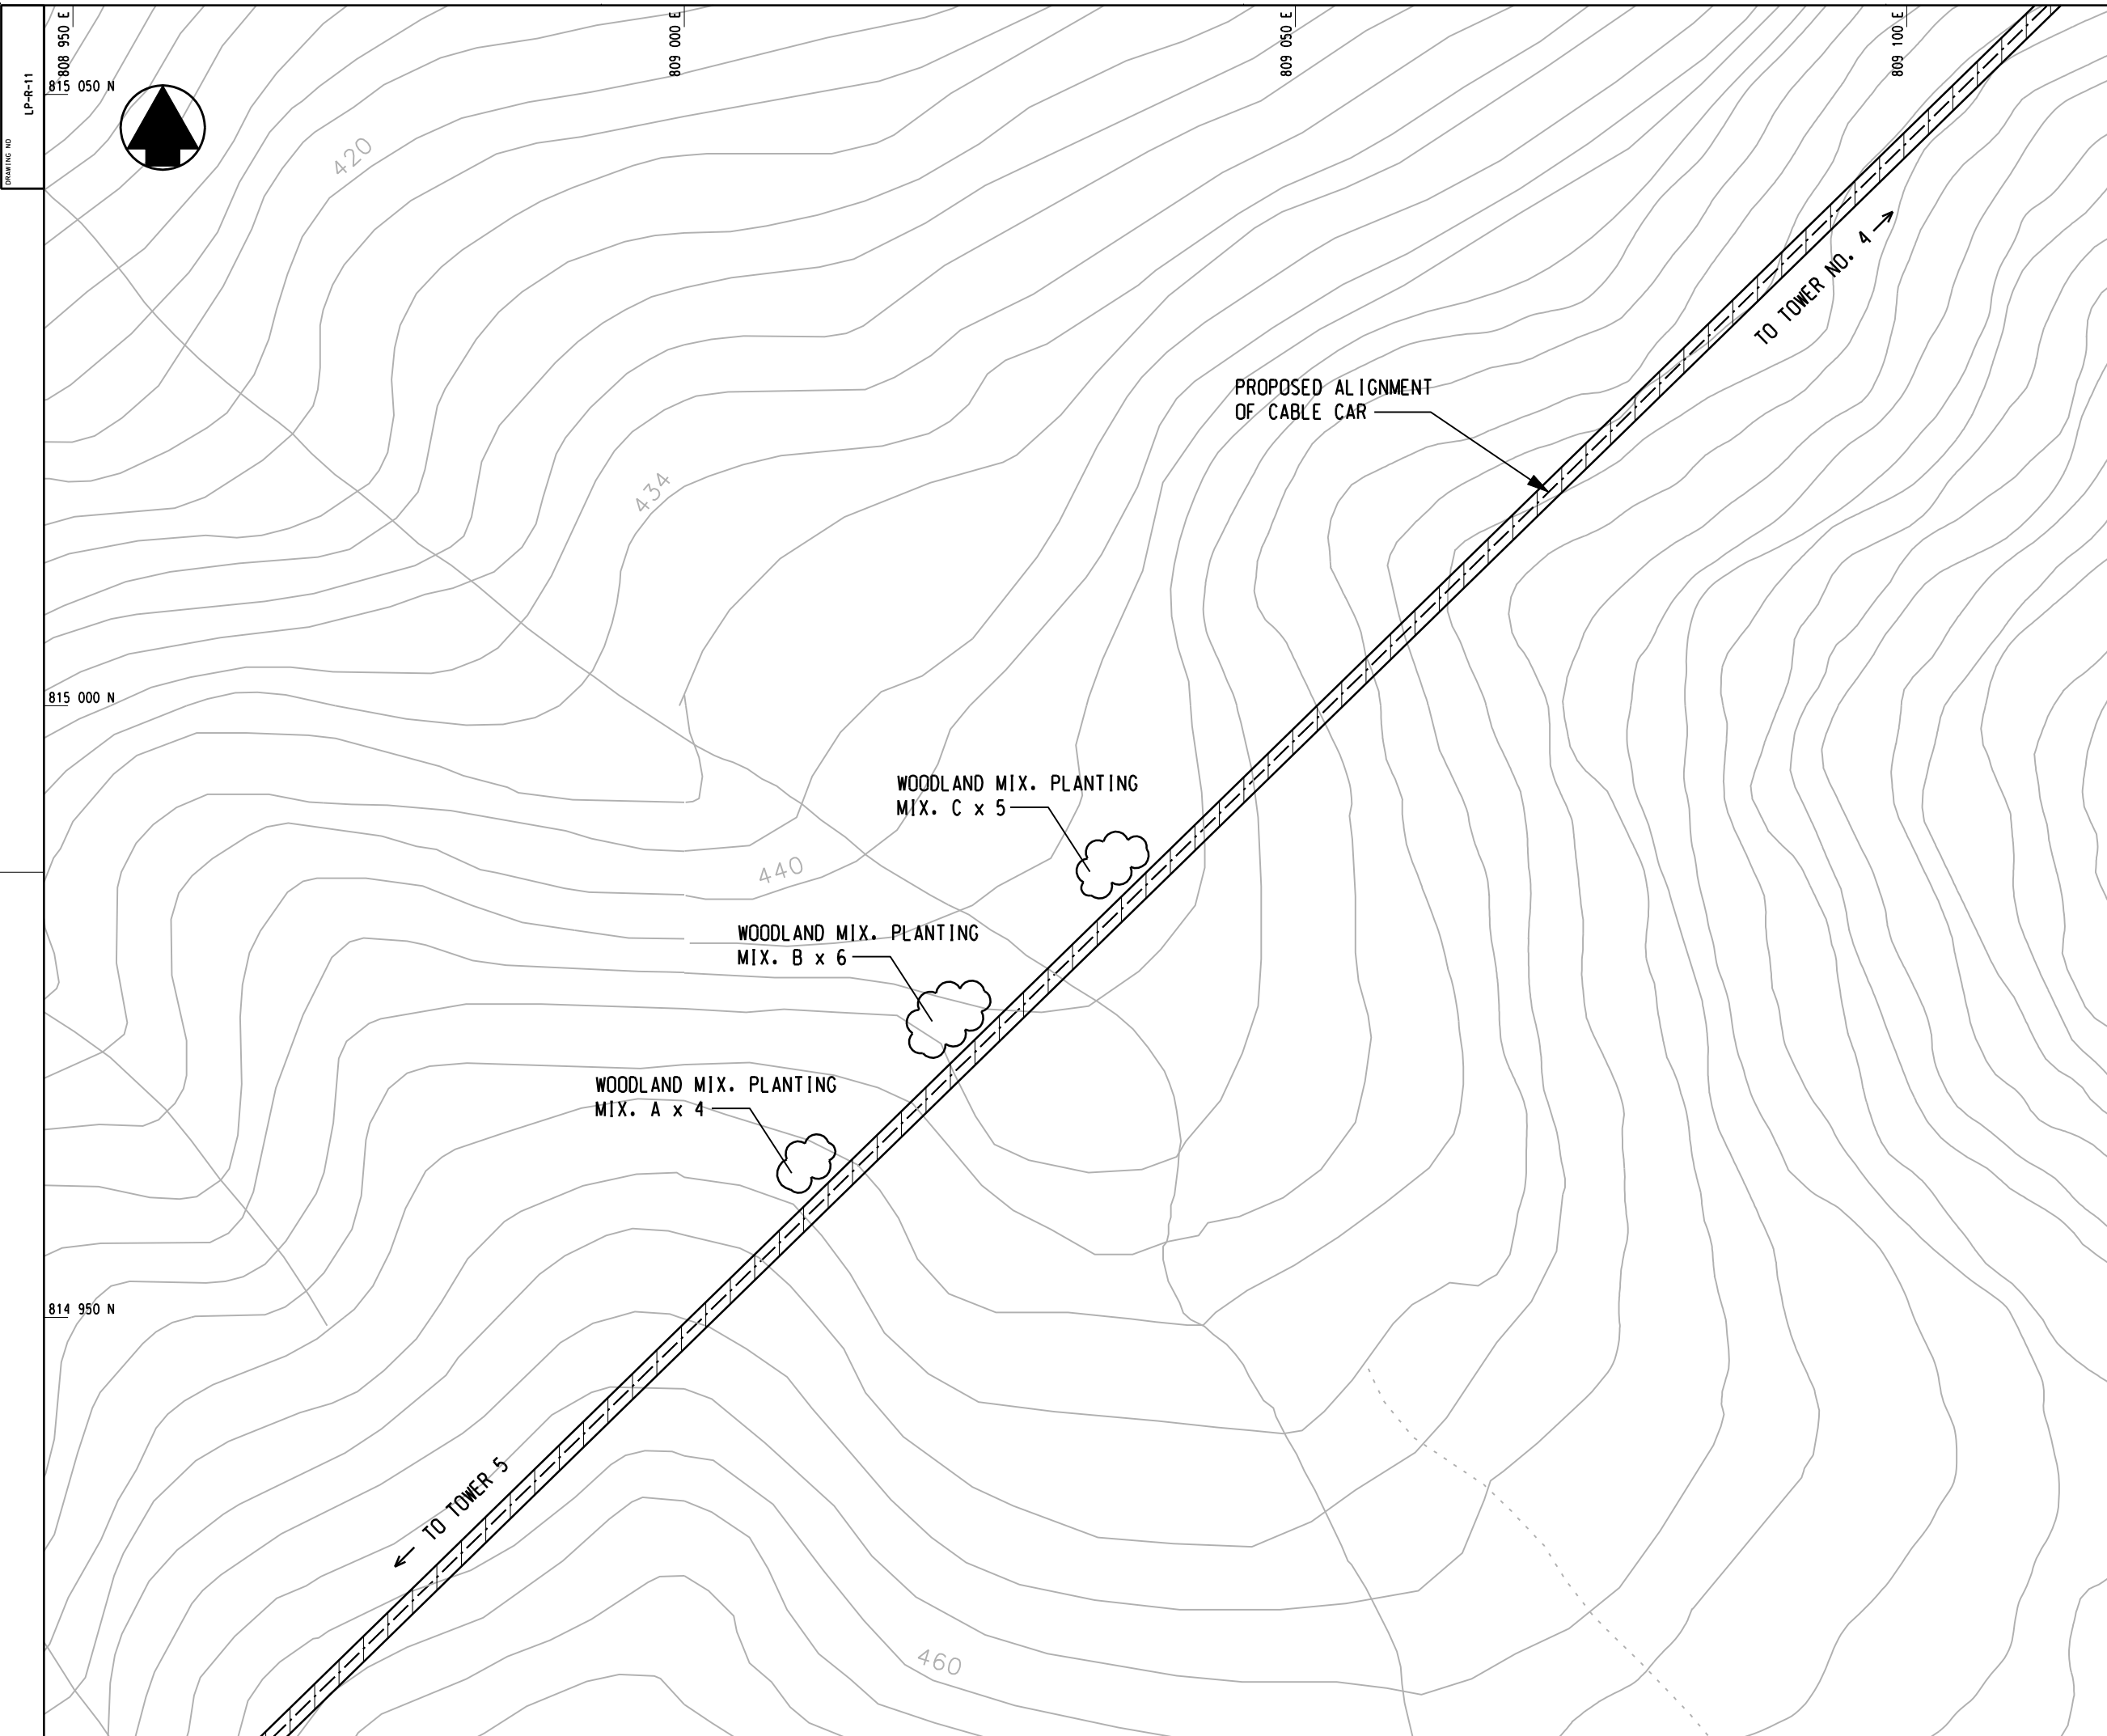

NO SCALE DIMENSIONS, VERIFY ALL DIMENSIONS ON SITE
 © 2005 HONG KONG CABLE CAR CORPORATION
 PREPARED ON BEHALF OF THE COMPANY / CONTRACTOR BY THE HONG KONG CABLE CAR CORPORATION
 IF ANY ERROR OR OMISSION IS FOUND IN THIS DRAWING, IT SHALL BE THE RESPONSIBILITY OF THE CONTRACTOR TO CORRECT IT BEFORE COMMENCING WORKS.

- LEGENDS:**
- WORKS SITE
 - NEW TREE PLANTING
 - RETAINED TREE
 - TRANSPLANTED TREE
 - PLANTING AREA
 - RETAINED WOODLAND

NOTES:

ALL AREAS TO BE HYDROSEED PRIOR TO PLANTING WORKS TO ASSIST EROSION CONTROL. HYDROSEED MIX TO CONSIST OF CYNODON DACTYLON + PASPALUM NOTATUM. (THERE IS TO BE NO GREEN DYE OR TERRAM COVER TO BE USED WITHIN COUNTRY PARK TO AVOID ANY POLLUTANTS TO PARK)

PLANT SCHEDULE:

Woodland mix 'A'

Shrubs	Botanical Name	Size(mm)Ht.
Ga	Gordonia axillaris	1000mm
Scs	Schima Superba	1000mm
Rt	Rhodomyrtus tomentosa	1000mm
Ms	Melastoma sanguineum	1000mm
Bf	Baeckea frutescens	1000mm
Dp	Dicranopteris pedata	1000mm

Woodland mix 'B'

Sd	Sapium discolor	1000mm
Rc	Rhus chinensis	1000mm
Ls	Litsea rotundifolia	1000mm
Mch	Machilus chinensis	1000mm

Woodland mix 'C'

Mc	Melastoma candidum	1000mm
Mpan	Micracos paniculata	1000mm
Ri	Rhaphiolepis indica	1000mm
Ss	Sapium sebiferum	1000mm
Sh	Schefflera heptaphylla	1000mm
Mp	Mallotus paniculatus	1000mm

REVISION	DESCRIPTION	BY	DATE	APPROVED

前田建設工業株式会社
 1901-5 NEW EAST OCEAN CENTRE
 9 SCIENCE MUSEUM ROAD
 T.S.T. EAST, KOWLOON, HONG KONG
 TEL.: 2589 6287 FAX: 2724 4084
 Maeda Corporation

地鐵公司
 MTR Corporation
 MTR TOWER
 TELFORD PLAZA - KOWLOON BAY
 HONG KONG
 TEL.: 2983 2111 FAX: 2798 9822


東涌吊車
 TUNG CHUNG CABLE CAR

凱達柏濤有限公司
 Aedas Limited

TITLE

RESCUE TRAIL FROM TOWER 4 TO TOWER 5
 LANDSCAPE PLANTING PLAN

SCALE	1 : 250 @ A1	CAD REF	AS BUILT
DATE	FEB. 2005	AS BUILT DWG NO	
DRAWN	WL	DESIGNED	JW
CHECKED	JW	APPROVED	SF
DRAWING NO	LP-R-11	REV	A

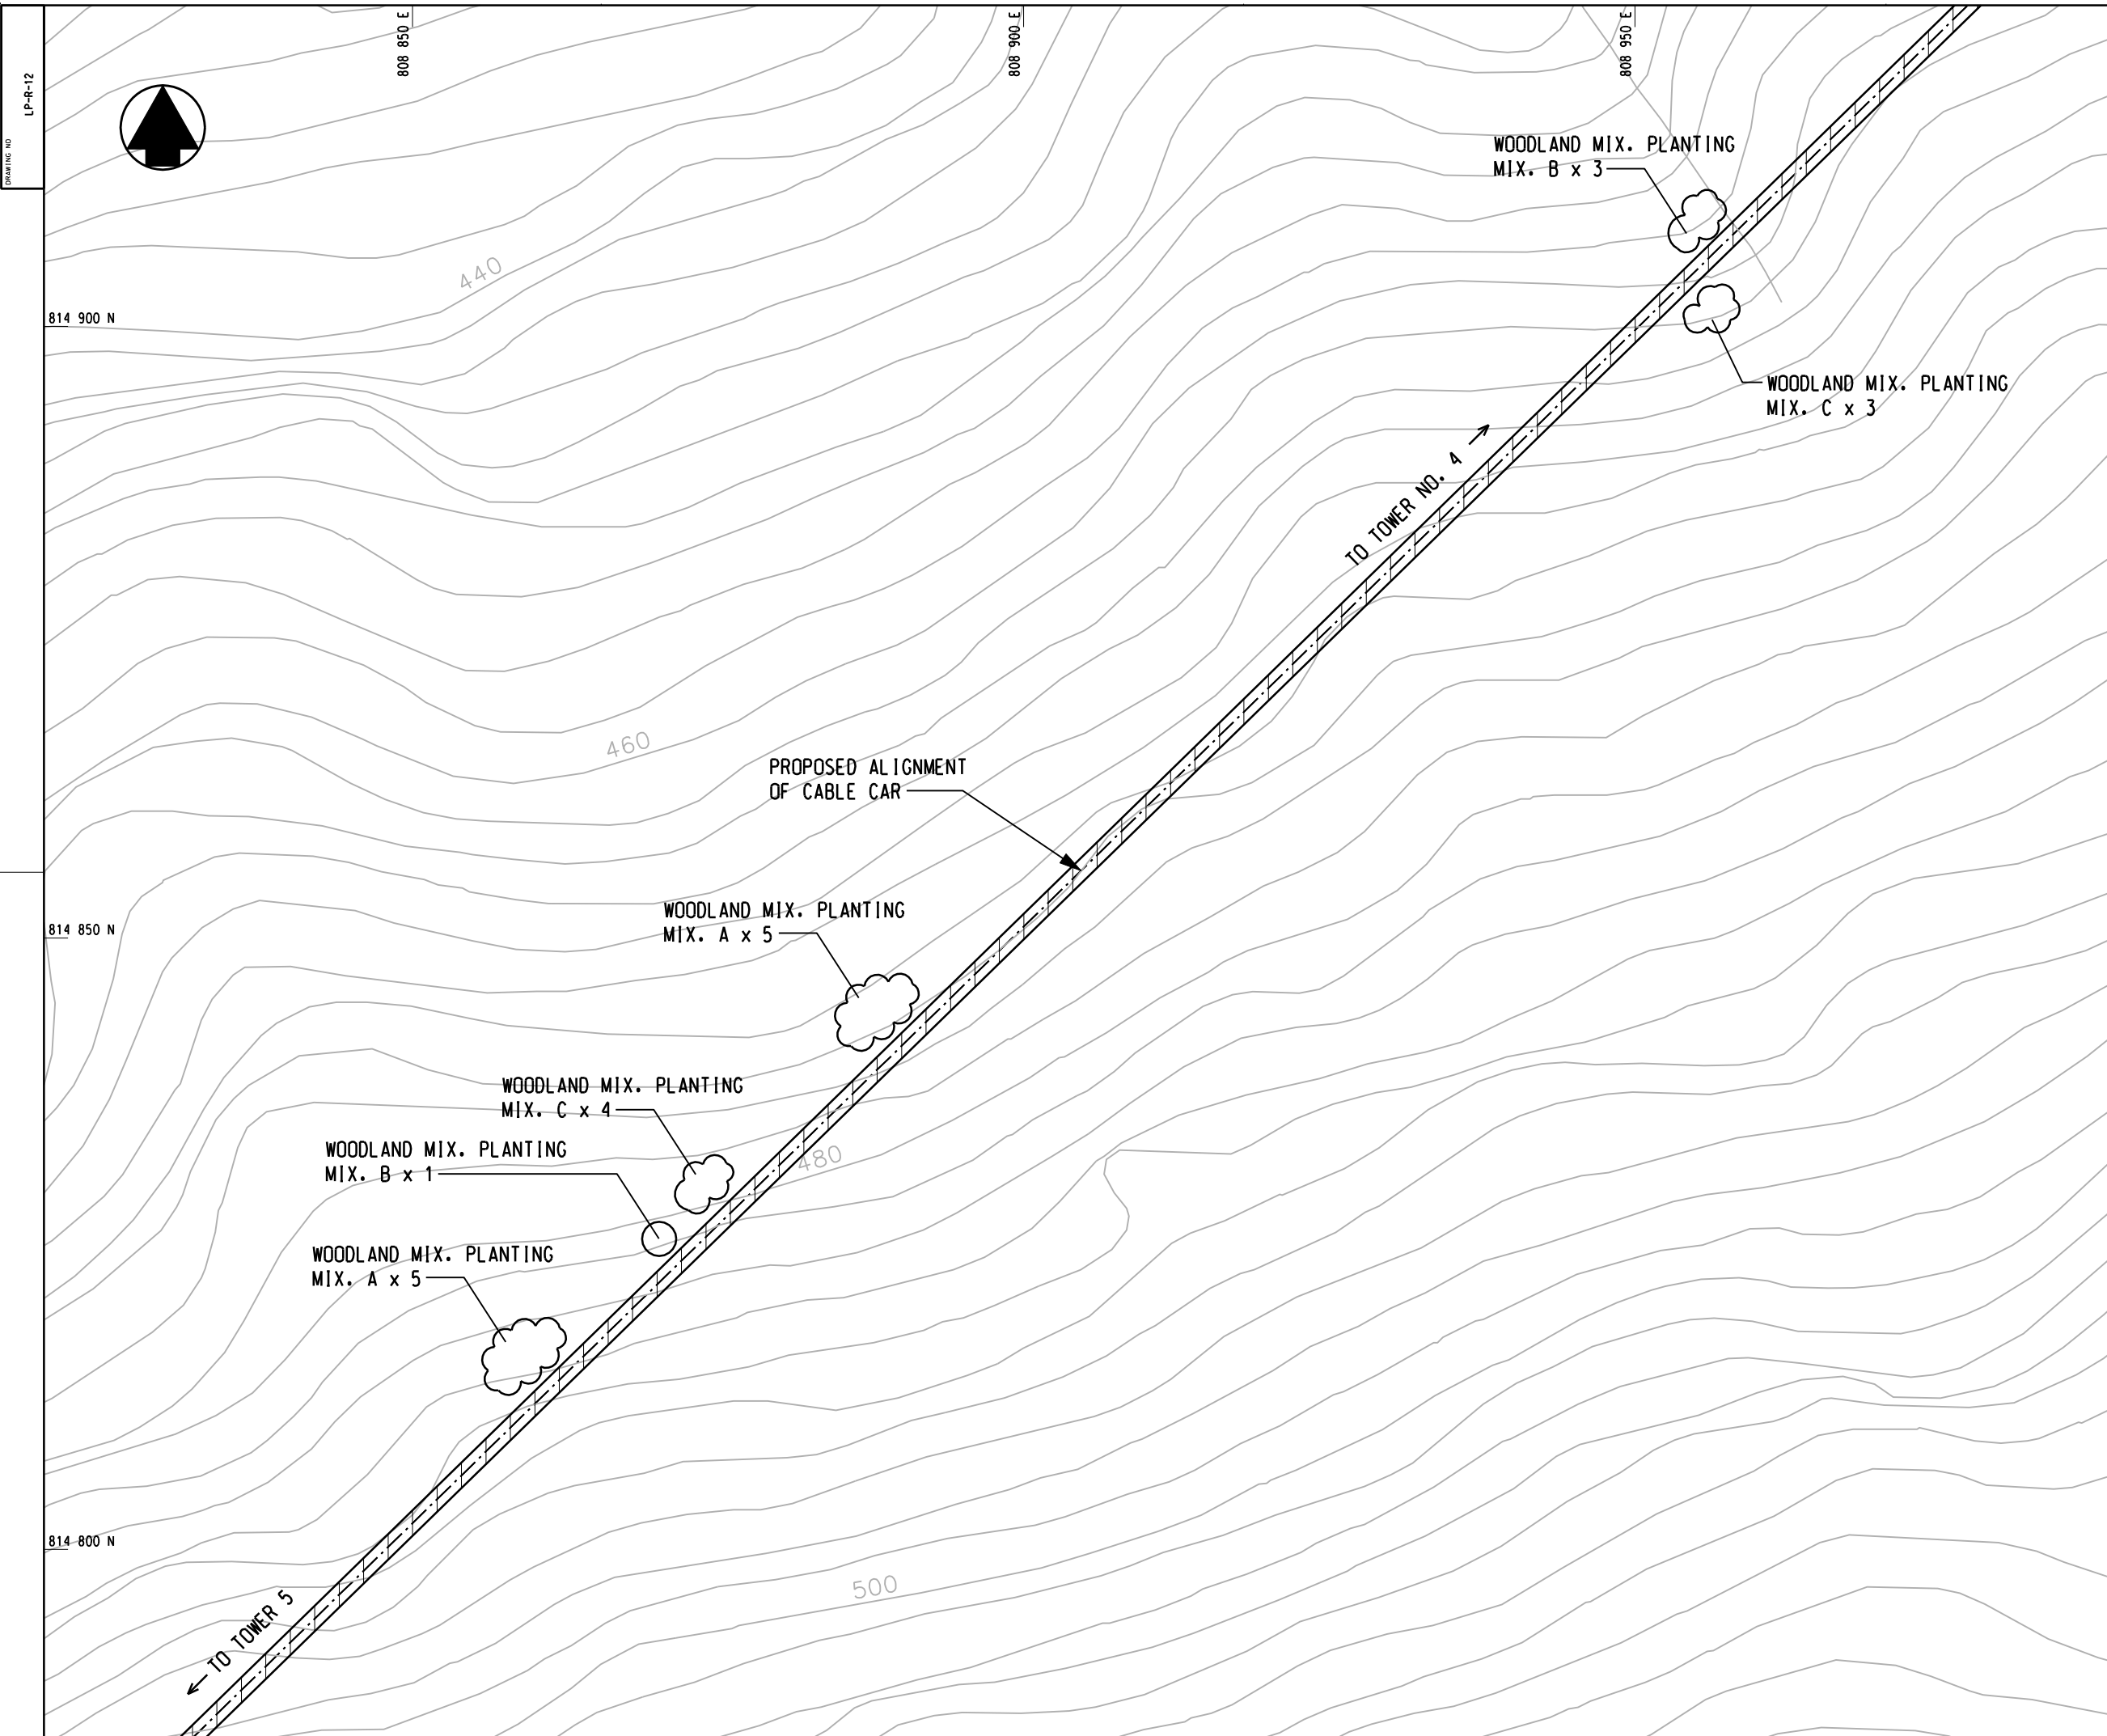

NO NET SCALE DIMENSIONS, VERIFY ALL DIMENSIONS ON SITE
 © 2005 HOKUKEI ARCHITECTURAL CONSULTANTS LTD
 CONSULTANT IN RESPECT OF THIS DRAWING / CONTRACT IS MADE BY THE HOKUKEI ARCHITECTURAL CONSULTANTS LTD
 IN ACCORDANCE WITH THE TERMS / CONDITIONS OF THE CONTRACT AND THE HOKUKEI ARCHITECTURAL CONSULTANTS LTD
 WILL BE RESPONSIBLE FOR THE DESIGN / CONSTRUCTION OF THE PROJECT AND THE HOKUKEI ARCHITECTURAL CONSULTANTS LTD

- LEGENDS:**
- WORKS SITE
 - NEW TREE PLANTING
 - ⊙ RETAINED TREE
 - ⊗ TRANSPLANTED TREE
 - ☁ PLANTING AREA
 - ▨ RETAINED WOODLAND

NOTES:

ALL AREAS TO BE HYDROSEEDED PRIOR TO PLANTING WORKS TO ASSIST EROSION CONTROL. HYDROSEED MIX TO CONSIST OF CYNODON DACTYLON + PASPALUM NOTATUM. (THERE IS TO BE NO GREEN DYE OR TERRAM COVER TO BE USED WITHIN COUNTRY PARK TO AVOID ANY POLLUTANTS TO PARK)

PLANT SCHEDULE:

Woodland mix 'A'

Shrubs	Botanical Name	Size(mm)Ht.
Ga	Gordonia axillaris	1000mm
Scs	Schima Superba	1000mm
Rt	Rhodomyrtus tomentosa	1000mm
Ms	Melastoma sanguineum	1000mm
Bf	Baeckea frutescens	1000mm
Dp	Dicranopteris pedata	1000mm

Woodland mix 'B'

Sd	Sapium discolor	1000mm
Rc	Rhus chinensis	1000mm
Ls	Litsea rotundifolia	1000mm
Mch	Machilus chinensis	1000mm

Woodland mix 'C'

Mc	Melastoma candidum	1000mm
Mpan	Microcos paniculata	1000mm
Ri	Rhaphiolepis indica	1000mm
Ss	Sapium sebiferum	1000mm
Sh	Schefflera heptaphylla	1000mm
Mp	Mallotus paniculatus	1000mm

REVISION	DESCRIPTION	BY	DATE	APPROVED

前田建設工業株式会社
 Maeda Corporation
 1001-5 NEW EAST OCEAN CENTRE
 9 SCIENCE MUSEUM ROAD
 T.S.T. EAST, KOWLOON, HONG KONG
 TEL.: 2589 6287 FAX: 2724 4084

地鐵公司
 MTR Corporation
 MTR TOWER
 TELFORD PLAZA - KOWLOON BAY
 HONG KONG
 TEL.: 2988 2111 FAX: 2798 9822


東涌吊車
 TUNG CHUNG CABLE CAR
 含

凱達柏濤有限公司
 Aedas Limited

TITLE

RESCUE TRAIL FROM TOWER 4 TO TOWER 5
 LANDSCAPE PLANTING PLAN

SCALE	1 : 250 @ A1	CAD REF	AS BUILT
DATE	FEB. 2005	AS BUILT	DWG NO
DRAWN	WL	DESIGNED	JW
CHECKED	JW	APPROVED	SF
DRAWING NO		REV	
LP-R-12		A	

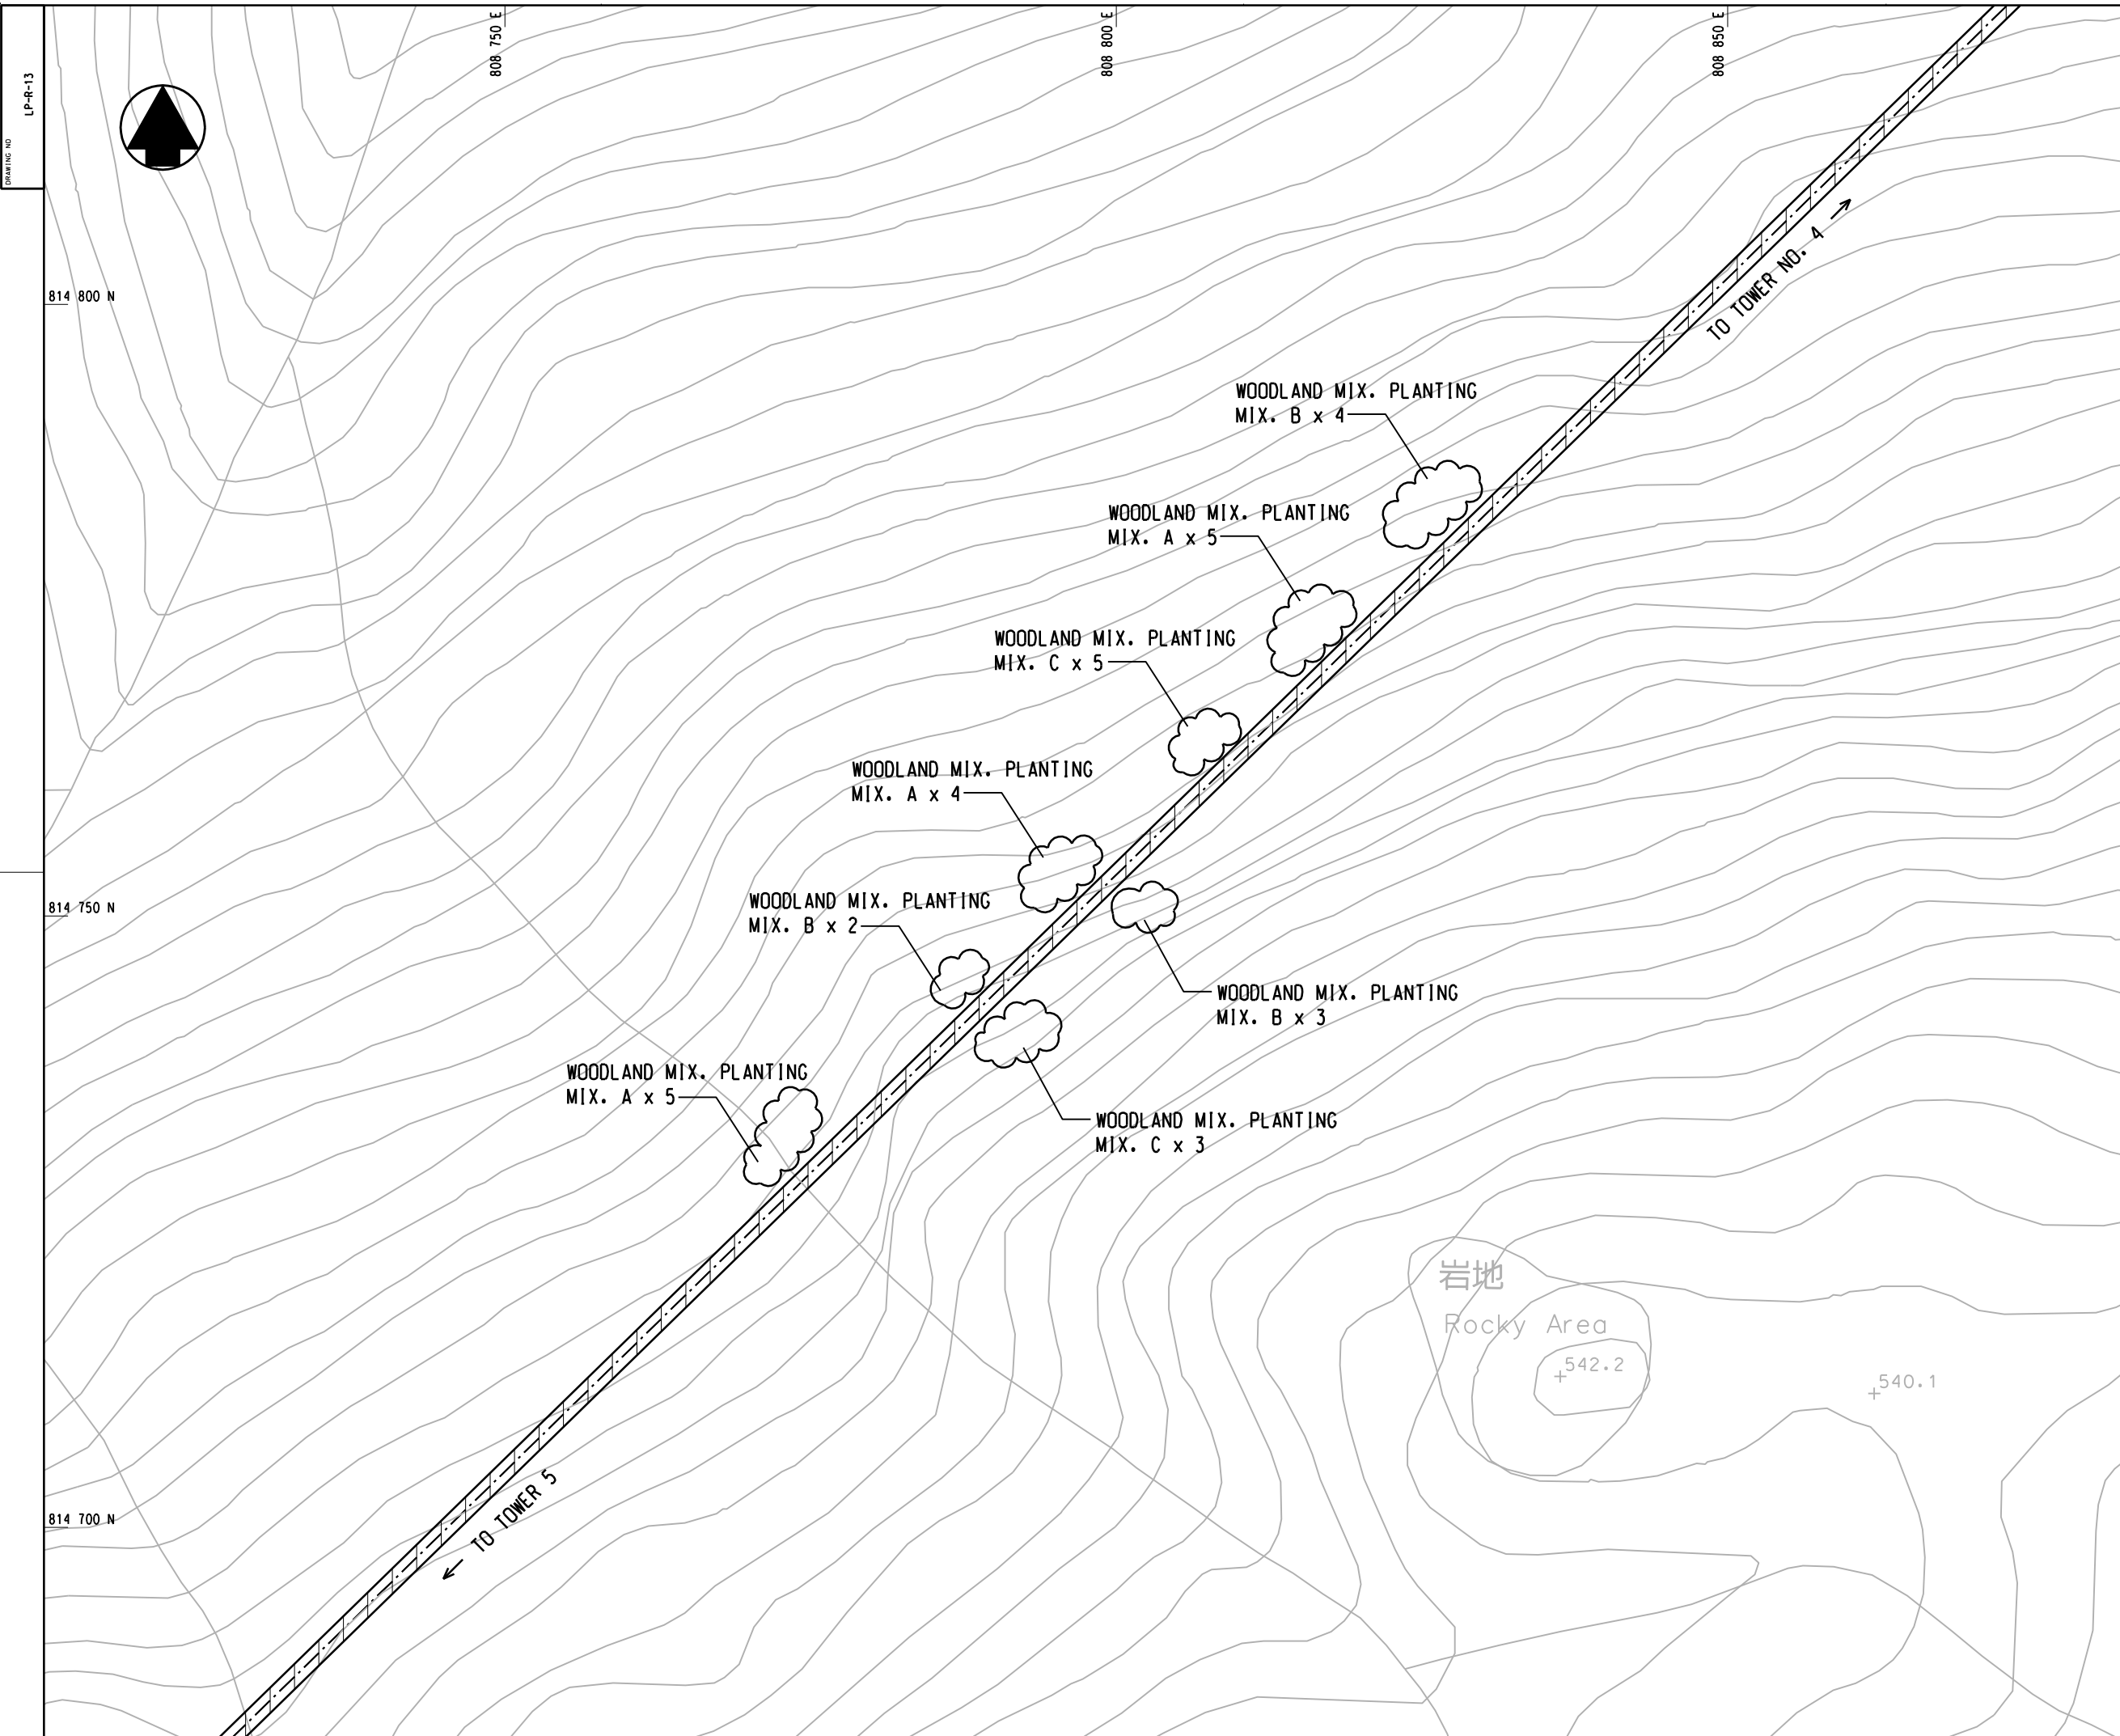

DRAWING NO
LP-R-13

NO NET SCALE DIMENSIONS, VERIFY ALL DIMENSIONS ON SITE
 © 2005 HONGKONG LANDSCAPE ARCHITECTURE CO. LTD.
 CONSULTANT TO THE PROJECT OF THE SCIENCE MUSEUM / EXHIBITOR 13 UNDER THE NEW TOWER 4 CABLE CAR PROJECT
 ALL RIGHTS RESERVED. NO PART OF THIS DRAWING IS TO BE REPRODUCED OR TRANSMITTED IN ANY FORM OR BY ANY MEANS, ELECTRONIC OR MECHANICAL, WITHOUT THE WRITTEN PERMISSION OF THE HONGKONG LANDSCAPE ARCHITECTURE CO. LTD.

- LEGENDS:**
- WORKS SITE
 - NEW TREE PLANTING
 - ◐ RETAINED TREE
 - ◑ TRANSPLANTED TREE
 - ☁ PLANTING AREA
 - ▨ RETAINED WOODLAND

NOTES:

ALL AREAS TO BE HYDROSEEDED PRIOR TO PLANTING WORKS TO ASSIST EROSION CONTROL. HYDROSEED MIX TO CONSIST OF CYNODON DACTYLON + PASPALUM NOTATUM. (THERE IS TO BE NO GREEN DYE OR TERRAM COVER TO BE USED WITHIN COUNTRY PARK TO AVOID ANY POLLUTANTS TO PARK)

PLANT SCHEDULE:

Woodland mix 'A'

Shrubs	Botanical Name	Size(mm)Ht.
Ga	Gordonia axillaris	1000mm
Scs	Schima Superba	1000mm
Rt	Rhodomyrtus tomentosa	1000mm
Ms	Melastoma sanguineum	1000mm
Bf	Baeckea frutescens	1000mm
Dp	Dicranopteris pedata	1000mm

Woodland mix 'B'

Sd	Sapium discolor	1000mm
Rc	Rhus chinensis	1000mm
Ls	Litsea rotundifolia	1000mm
Mch	Machilus chinensis	1000mm

Woodland mix 'C'

Mc	Melastoma candidum	1000mm
Mpan	Microcos paniculata	1000mm
Ri	Rhaphiolepis indica	1000mm
Ss	Sapium sebiferum	1000mm
Sh	Schefflera heptaphylla	1000mm
Mp	Mallotus paniculatus	1000mm

REVISION	DESCRIPTION	BY	DATE	APPROVED

前田建設工業株式会社
Maeda Corporation
1901-5 NEW EAST OCEAN CENTRE
9 SCIENCE MUSEUM ROAD
T.S.T. EAST, KOWLOON, HONG KONG
TEL.: 2589 6287 FAX.: 2724 4084


MTR 地鐵公司
MTR Corporation
MTR TOWER
TELFORD PLAZA - KOWLOON BAY
HONG KONG
TEL.: 2988 2111 FAX.: 2798 9822

東涌吊車
TUNG CHUNG CABLE CAR

凱達柏濤有限公司
Aedas Limited

TITLE
RESCUE TRAIL FROM TOWER 4 TO TOWER 5
LANDSCAPE PLANTING PLAN

SCALE	1 : 250 @ A1	CAD REF	AS BUILT
DATE	FEB. 2005	AS BUILT	DWG NO
DRAWN	WL	DESIGNED	JW
CHECKED	JW	APPROVED	SF
DRAWING NO	LP-R-13	REV	A

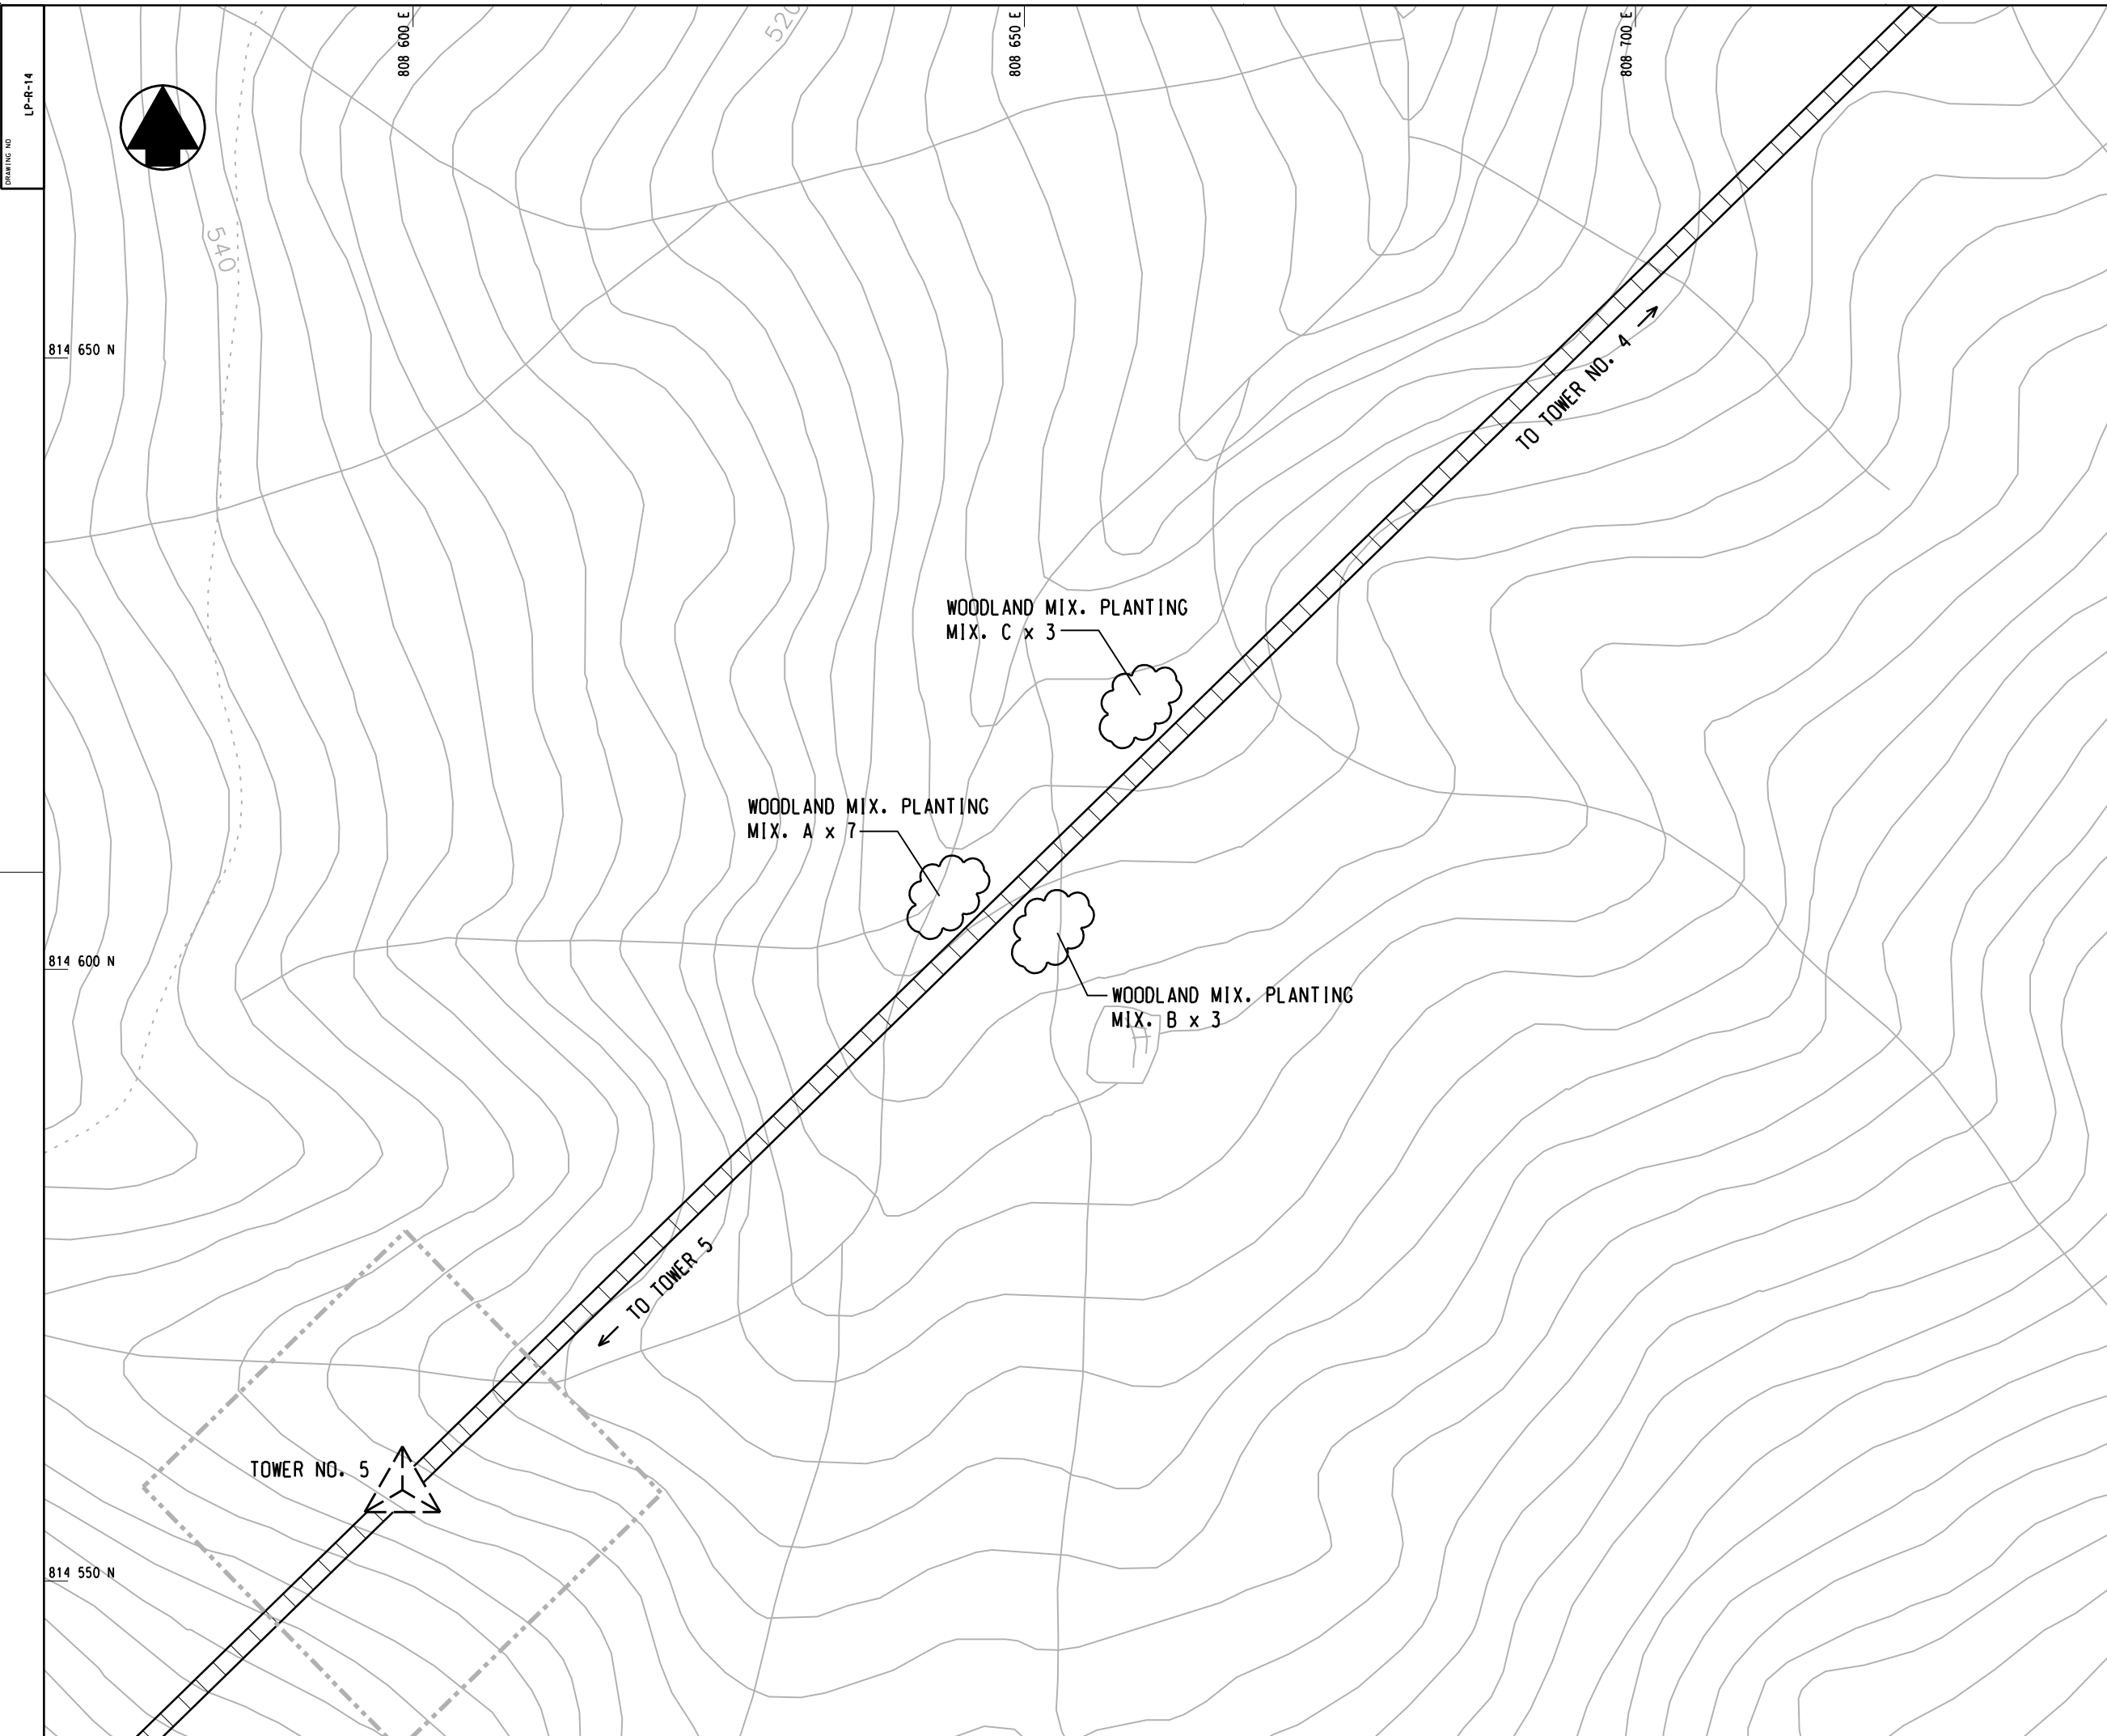

DRAWING NO
LP-R-14

NO PART OF THIS DRAWING, WHOLE OR IN PART, IS TO BE REPRODUCED OR TRANSMITTED IN ANY FORM OR BY ANY MEANS, ELECTRONIC OR MECHANICAL, INCLUDING PHOTOCOPYING, RECORDING, OR BY ANY INFORMATION STORAGE AND RETRIEVAL SYSTEM, WITHOUT THE WRITTEN CONSENT OF THE MTR DESIGN SERVICES COMPANY.

- LEGENDS:**
- WORKS SITE
 - NEW TREE PLANTING
 - RETAINED TREE
 - TRANSPLANTED TREE
 - PLANTING AREA
 - RETAINED WOODLAND

NOTES:

ALL AREAS TO BE HYDROSEEDING PRIOR TO PLANTING WORKS TO ASSIST EROSION CONTROL. HYDROSEED MIX TO CONSIST OF CYNODON DACTYLON + PASPALUM NOTATUM. (THERE IS TO BE NO GREEN DYE OR TERRAM COVER TO BE USED WITHIN COUNTRY PARK TO AVOID ANY POLLUTANTS TO PARK)

PLANT SCHEDULE:

Woodland mix 'A'

Shrubs	Botanical Name	Size(mm)HT.
Ga	Gordonia axillaris	1000mm
Scs	Schima Superba	1000mm
Rt	Rhodomyrtus tomentosa	1000mm
Ms	Melastoma sanguineum	1000mm
Bf	Baeckea frutescens	1000mm
Dp	Dicranopteris pedata	1000mm

Woodland mix 'B'

Shrubs	Botanical Name	Size(mm)HT.
Sd	Sapium discolor	1000mm
Rc	Rhus chinensis	1000mm
Ls	Litsea rotundifolia	1000mm
Mch	Machilus chinensis	1000mm

Woodland mix 'C'

Shrubs	Botanical Name	Size(mm)HT.
Mc	Melastoma candidum	1000mm
Mpan	Micracos paniculata	1000mm
Ri	Rhaphiolepis indica	1000mm
Ss	Sapium sebiferum	1000mm
Sh	Schefflera heptaphylla	1000mm
Mp	Mallotus paniculatus	1000mm

REVISION	DESCRIPTION	BY	DATE	APPROVED

前田建設工業株式会社
Maeda Corporation
1901-5 NEW EAST OCEAN CENTRE
9 SCIENCE MUSEUM ROAD
T.S.T. EAST, KOWLOON, HONG KONG
TEL.: 2599 6267 FAX.: 2724 4084

地鐵公司
MTR Corporation
MTR TOWER
TELFORD PLAZA - KOWLOON BAY
HONG KONG
TEL.: 2988 2111 FAX.: 2798 9822



PROJECT
東涌吊車
TUNG CHUNG CABLE CAR

ORIGINATOR
凱達柏濶有限公司
Aedas Limited

TITLE
RESCUE TRAIL FROM TOWER 4 TO TOWER 5
LANDSCAPE PLANTING PLAN

SCALE	1 : 250 @ A1	CAD REF	AS BUILT
DATE	FEB. 2005	AS BUILT	DWG NO
DRAWN	WL	DESIGNED	JW
CHECKED	JW	APPROVED	SF

DRAWING NO	REV
LP-R-14	A

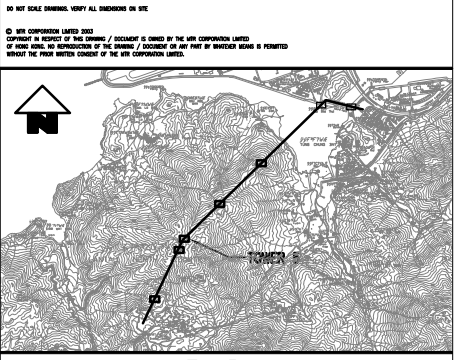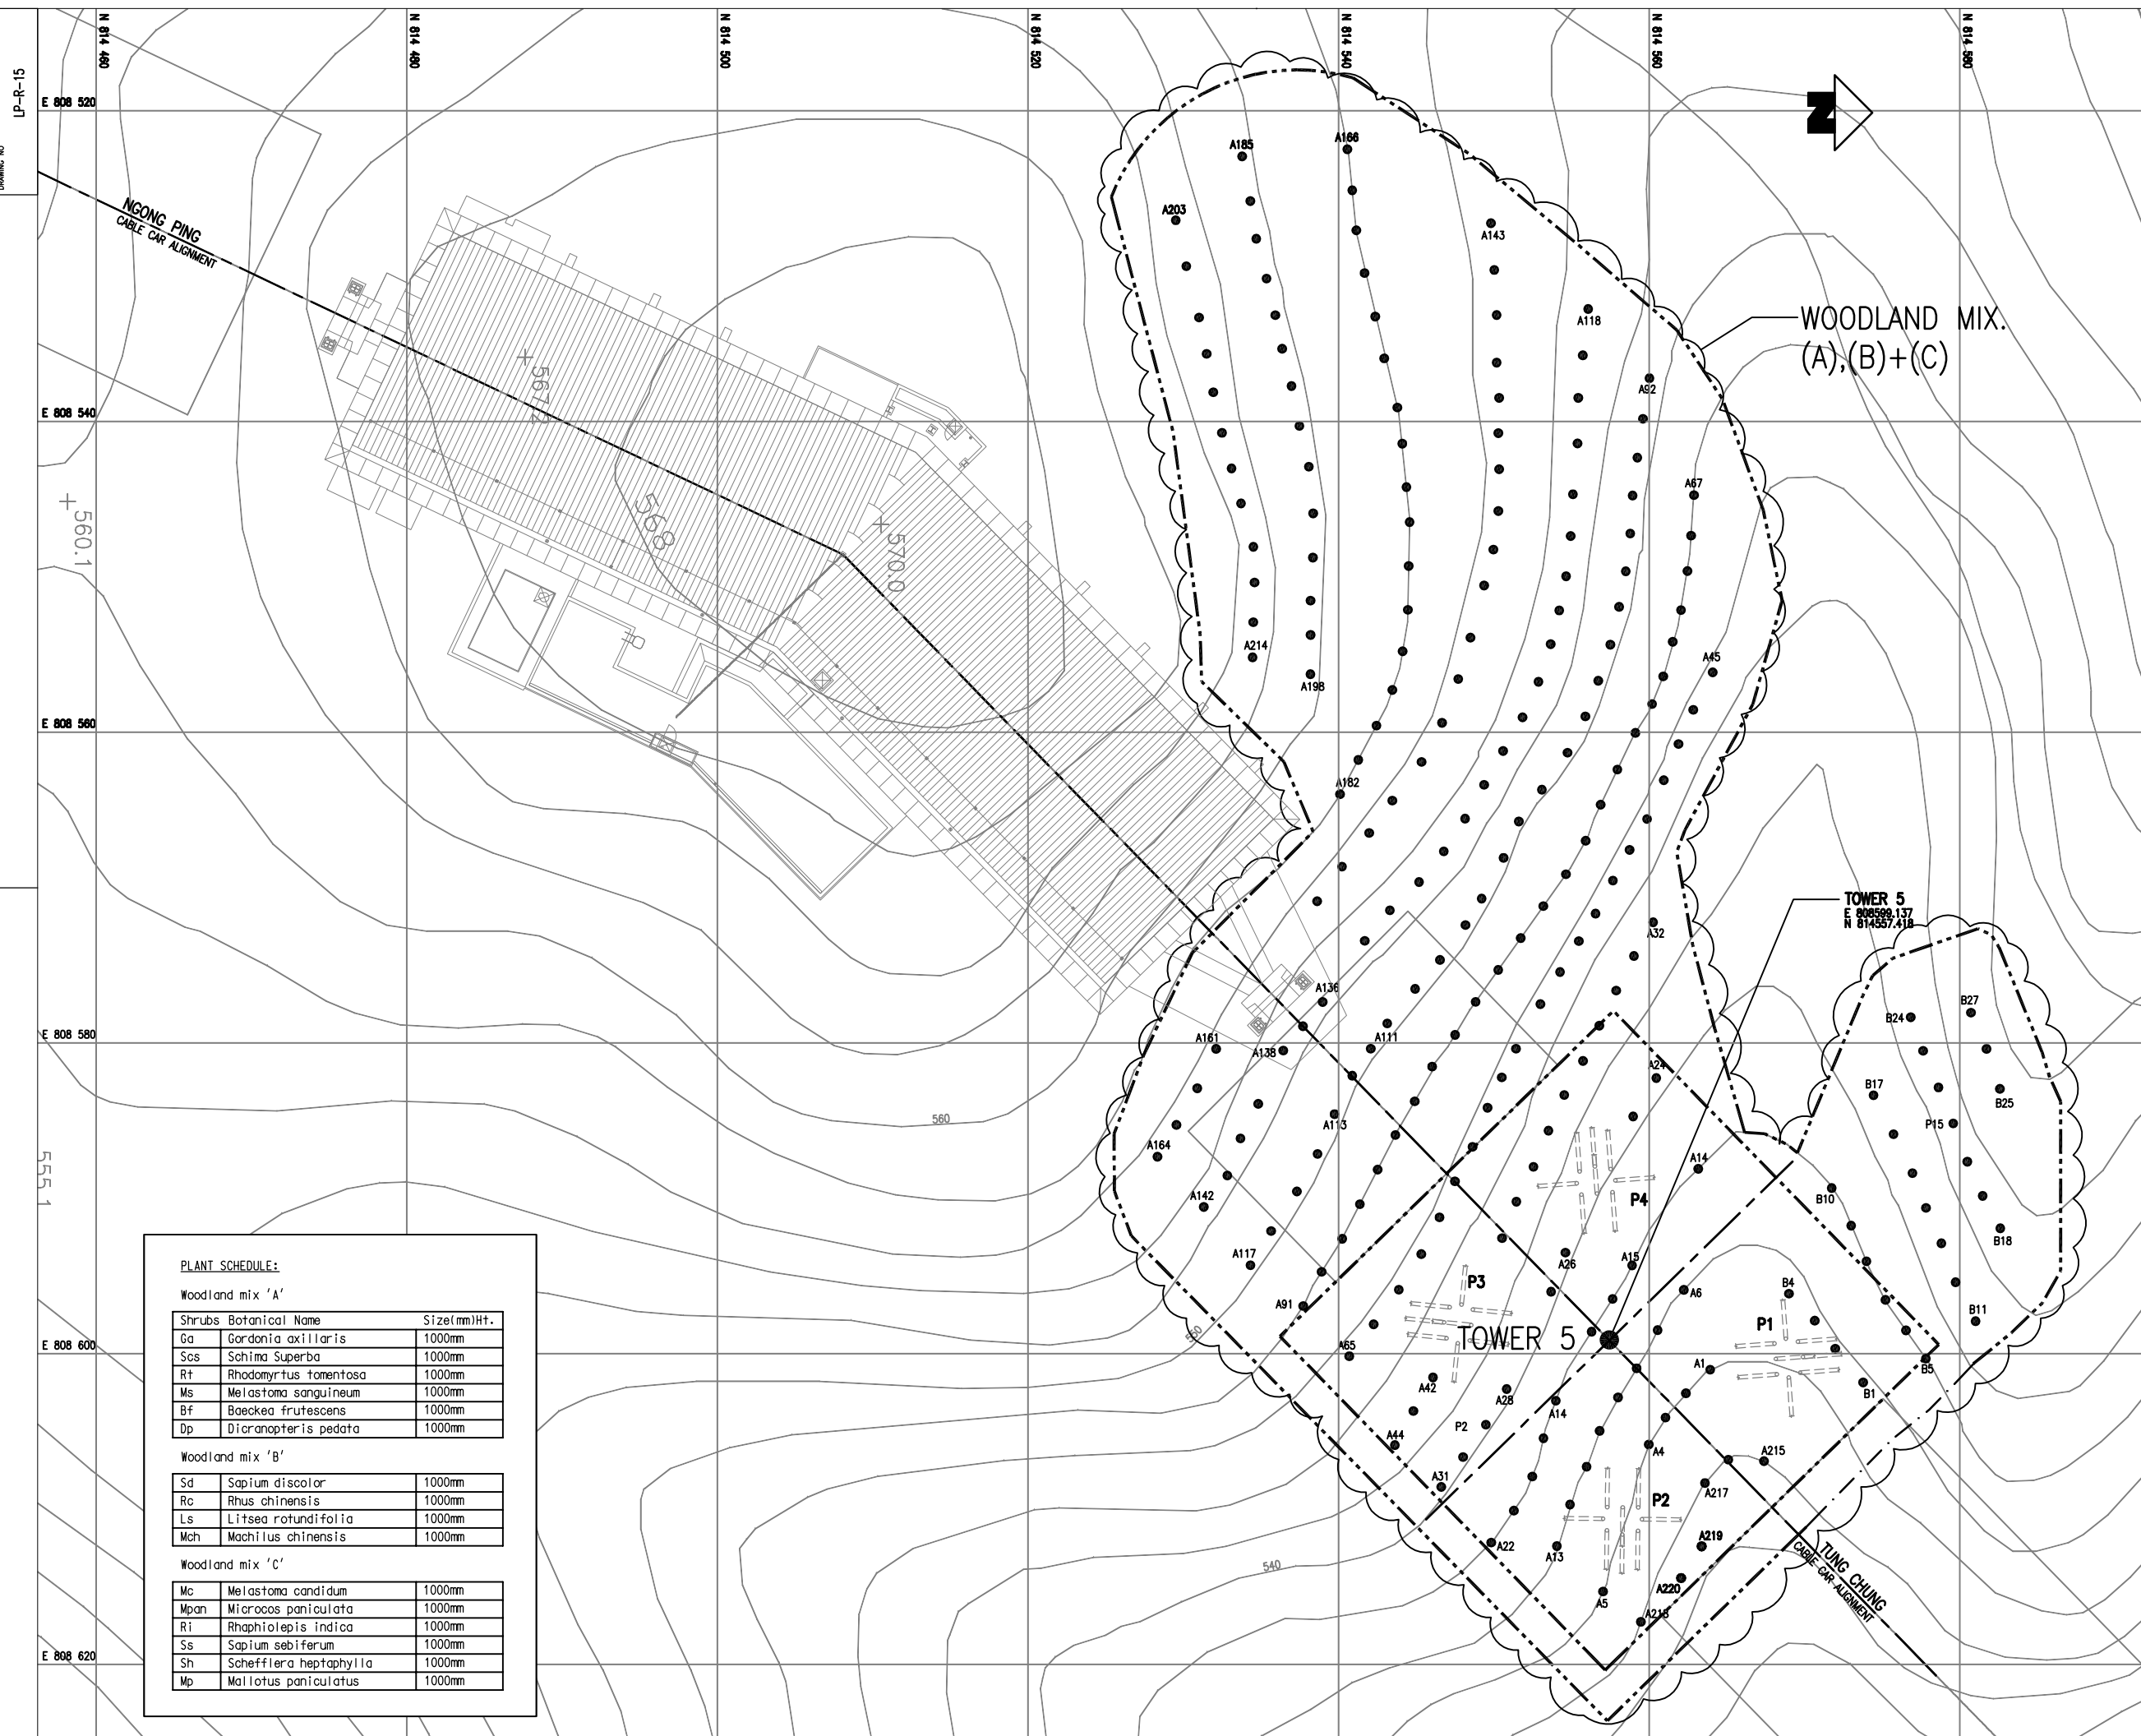

KEY PLAN

LEGEND:

- WORKS SITE
- NEW TREE PLANTING
- ⊗ RETAINED TREE
- ⊗ TRANSPLANTED TREE
- ☁ PLANTING AREA
- ▨ RETAINED WOODLAND
- S1 LOCATION OF SOIL NAIL
- P4 TOWER BASE NO.
- ⊕ A219 PROTECTED TREES

NOTES:

ALL AREAS TO BE HYDROSEED PRIOR TO PLANTING WORKS TO ASSIST EROSION CONTROL. HYDROSEED MIX TO CONSIST OF CYNODON DACTYLON + PASPALUM NOTATUM. (THERE IS TO BE NO GREEN DYE OR TERRAM COVER TO BE USED WITHIN COUNTRY PARK TO AVOID ANY POLLUTANTS TO PARK)

PLANT SCHEDULE:

Shrubs	Botanical Name	Size(mm)Ht.
Ga	Gordonia axillaris	1000mm
Scs	Schima Superba	1000mm
Rt	Rhodomyrtus tomentosa	1000mm
Ms	Melastoma sanguineum	1000mm
Bf	Baeckea frutescens	1000mm
Dp	Dicranopteris pedata	1000mm

Woodland mix 'B'		
Sd	Sapium discolor	1000mm
Rc	Rhus chinensis	1000mm
Ls	Litsea rotundifolia	1000mm
Mch	Machilus chinensis	1000mm

Woodland mix 'C'		
Mc	Melastoma candidum	1000mm
Mpan	Microcos paniculata	1000mm
Ri	Rhaphiolepis indica	1000mm
Ss	Sapium sebiferum	1000mm
Sh	Schefflera heptaphylla	1000mm
Mp	Mallotus paniculatus	1000mm

REVISION	DESCRIPTION	BY	DATE	APPROVED

		MTR TOWER TELFORD PLAZA - KOWLOON BAY HONG KONG TEL : 2993 2111 FAX : 2798 8822	
TUNG CHUNG CABLE CAR			
CONTRACTOR 		MAEDA CORPORATION	
ORIGINATOR			
TITLE <p style="text-align: center;">TOWER 5 LANDSCAPE PLANTING PLAN</p>			
SCALE	1 : 200	CAD REF	AS BUILT APPROVED
DATE	12 MAY 2004	AS BUILT DWG NO	
DRAWN	DESIGNED	DRAWING NO	REV
CHECKED	APPROVED	LP-R-15	A

NO NET SCALE DIMENSIONS. VERIFY ALL DIMENSIONS ON SITE.
 © 2005 MAEDA CONSTRUCTION (HONG KONG) LIMITED. ALL RIGHTS RESERVED.
 THIS DRAWING IS THE PROPERTY OF MAEDA CONSTRUCTION (HONG KONG) LIMITED. IT IS TO BE USED ONLY FOR THE PROJECT AND SITE SPECIFIC TO WHICH IT IS ISSUED.
 WITHOUT THE WRITTEN CONSENT OF MAEDA CONSTRUCTION (HONG KONG) LIMITED.

- LEGENDS:**
- WORKS SITE
 - NEW TREE PLANTING
 - ⊙ RETAINED TREE
 - ⊗ TRANSPLANTED TREE
 - ☁ PLANTING AREA
 - ▨ RETAINED WOODLAND

NOTES:

ALL AREAS TO BE HYDROSEEDING PRIOR TO PLANTING WORKS TO ASSIST EROSION CONTROL. HYDROSEED MIX TO CONSIST OF CYNODON DACTYLON + PASPALUM NOTATUM. (THERE IS TO BE NO GREEN DYE OR TERRAM COVER TO BE USED WITHIN COUNTRY PARK TO AVOID ANY POLLUTANTS TO PARK)

PLANT SCHEDULE:

Woodland mix 'A'

Shrubs	Botanical Name	Size(mm)Ht.
Ga	Gordonia axillaris	1000mm
Scs	Schima Superba	1000mm
Rt	Rhodomyrtus tomentosa	1000mm
Ms	Melastoma sanguineum	1000mm
Bf	Baeckea frutescens	1000mm
Dp	Dicranopteris pedata	1000mm

Woodland mix 'B'

Shrubs	Botanical Name	Size(mm)Ht.
Sd	Sapium discolor	1000mm
Rc	Rhus chinensis	1000mm
Ls	Litsea rotundifolia	1000mm
Mch	Machilus chinensis	1000mm

Woodland mix 'C'

Shrubs	Botanical Name	Size(mm)Ht.
Mc	Melastoma candidum	1000mm
Mpan	Microssos paniculata	1000mm
Ri	Rhaphiolepis indica	1000mm
Ss	Sapium sebiferum	1000mm
Sh	Schefflera heptaphylla	1000mm
Mp	Mallotus paniculatus	1000mm


REVISION	DESCRIPTION	BY	DATE	APPROVED

前田建設工業株式会社
 Maeda Corporation
 1901-5 NEW EAST OCEAN CENTRE
 9 SCIENCE MUSEUM ROAD
 T.S.T. EAST, KOWLOON, HONG KONG
 TEL.: 2599 0287 FAX.: 2724 4084

地鐵公司
 MTR Corporation
 MTR TOWER
 TELFORD PLAZA - KOWLOON BAY
 HONG KONG
 TEL.: 2983 2111 FAX.: 2798 9822

東滿吊車
 TUNG CHUNG CABLE CAR
 凱達柏濶有限公司
 Aedas Limited

SCALE	1 : 250 @ A1	CAD REF	AS BUILT APPROVED
DATE	APR. 2005	AS BUILT DWG NO	
DRAWN	WL	DESIGNED	JW
CHECKED	JW	APPROVED	SF
DRAWING NO	LP-R-16	REV	B

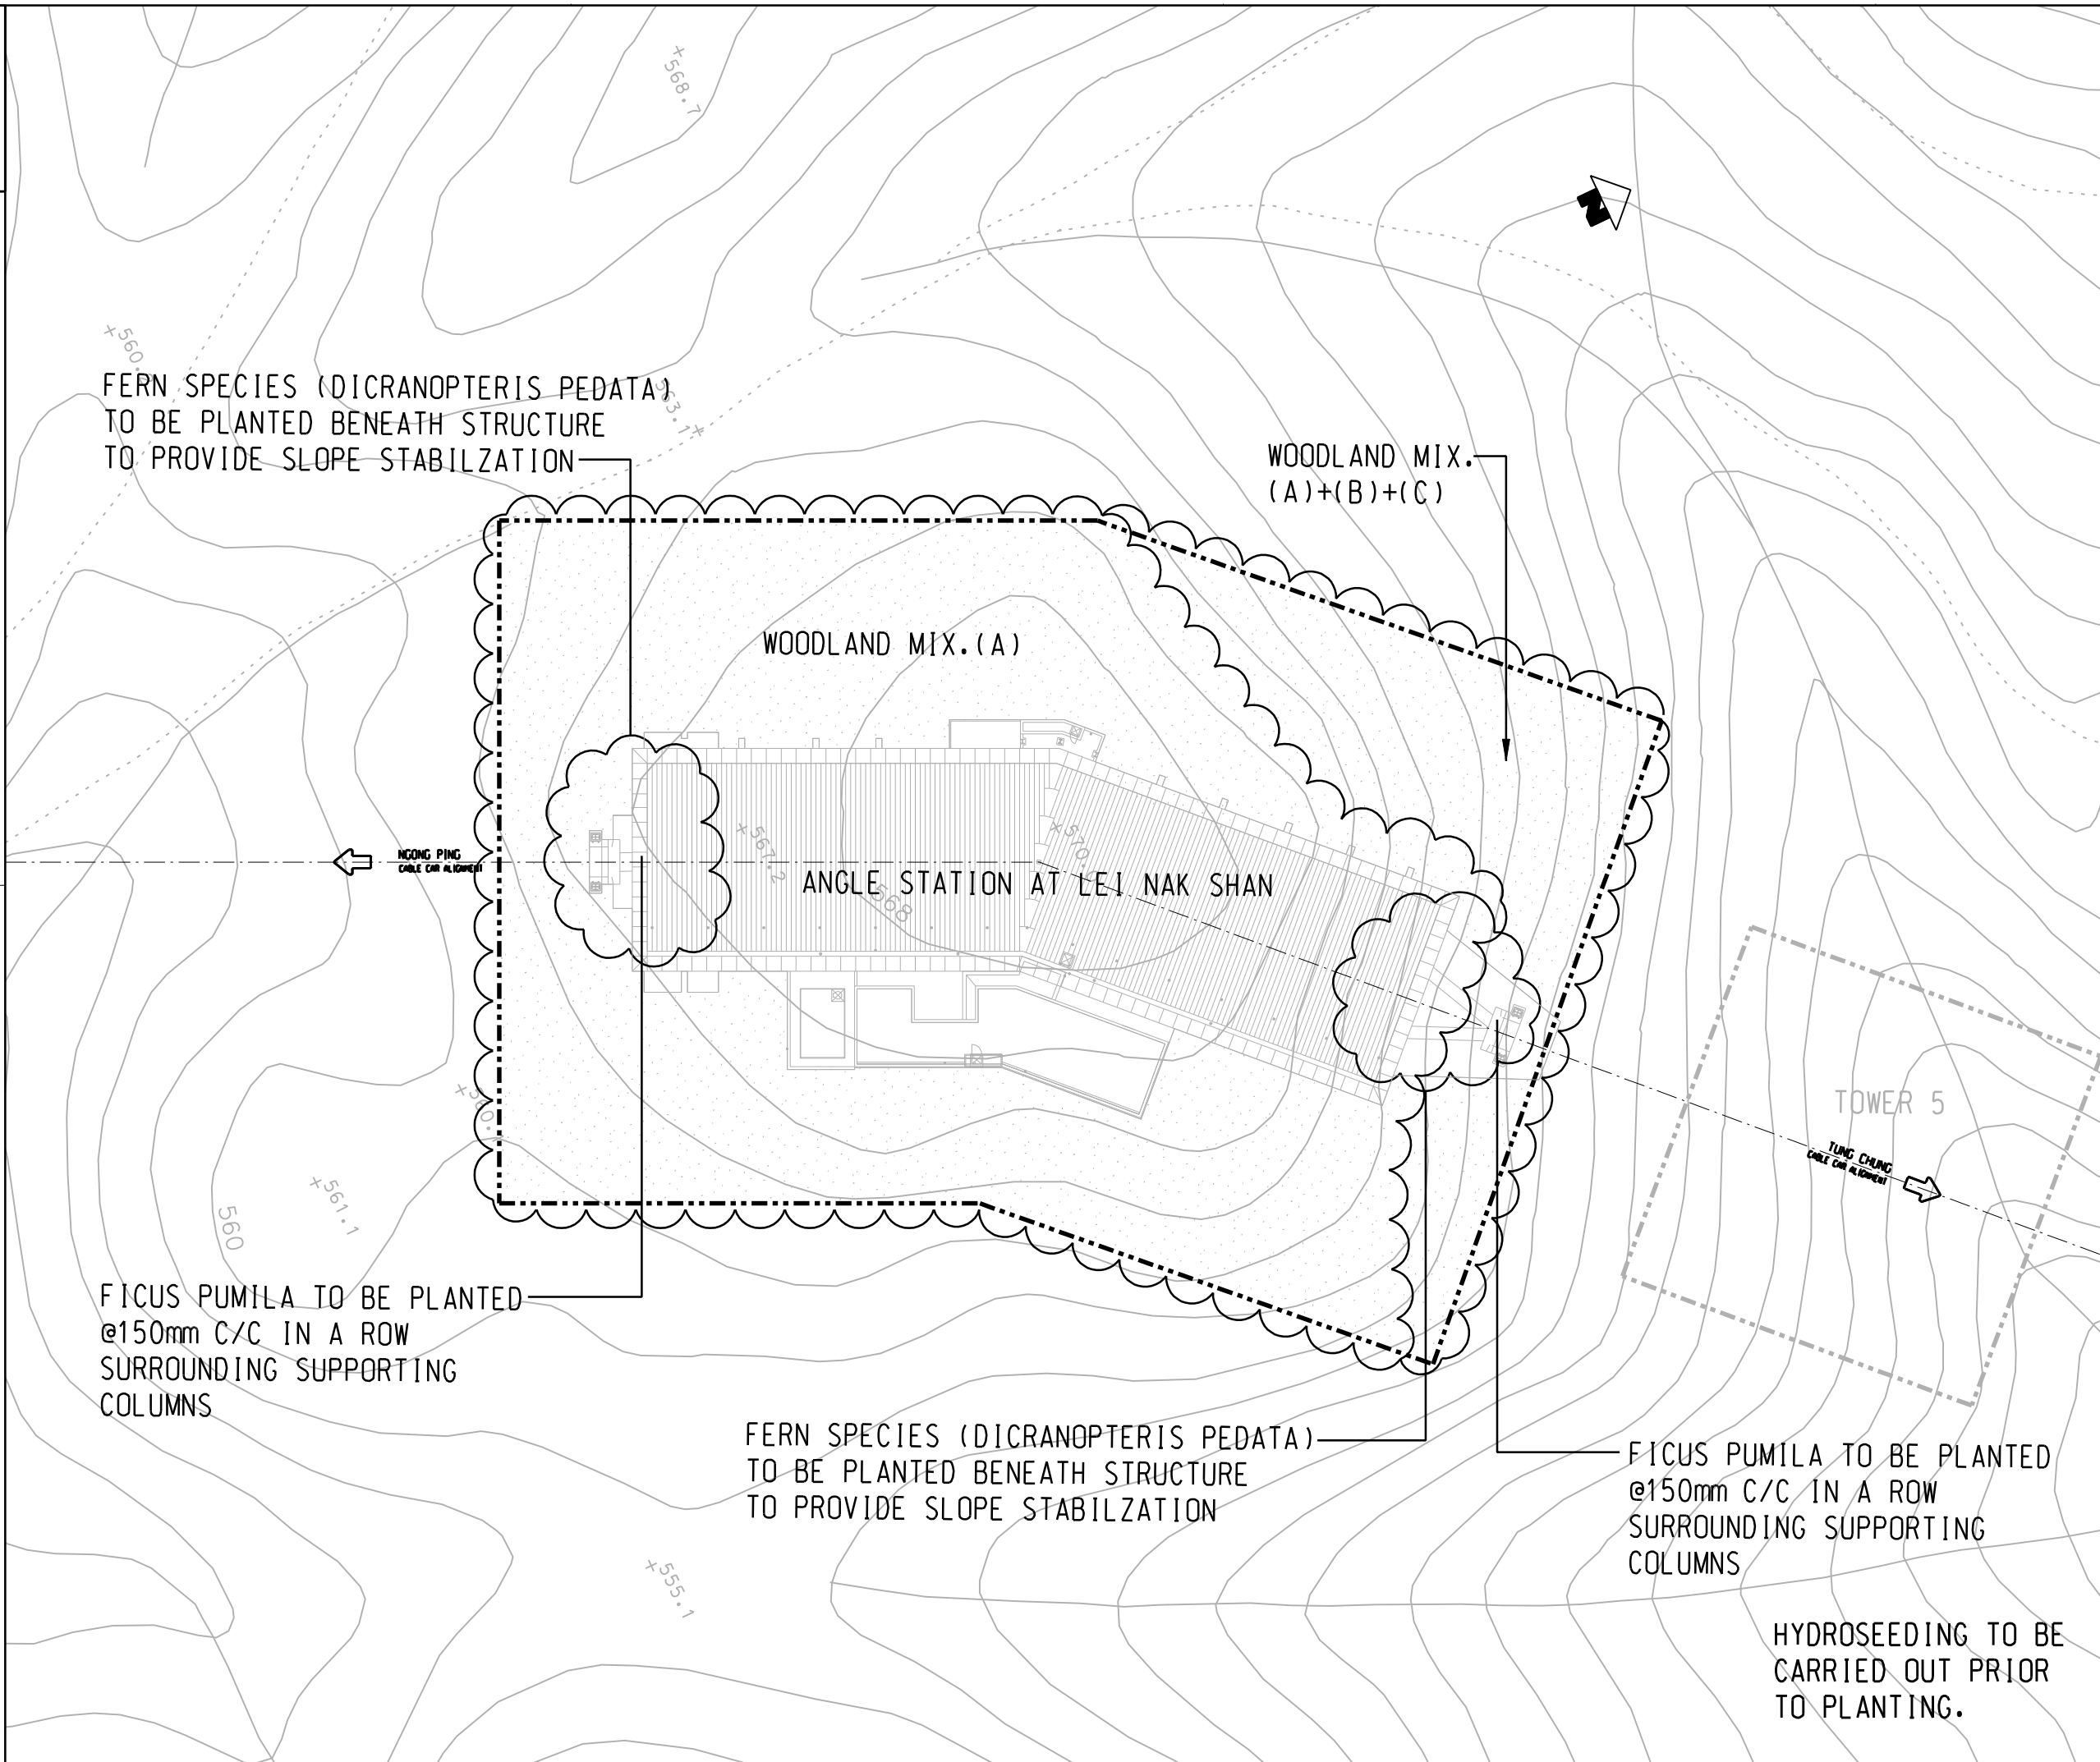

FERN SPECIES (DICRANOPTERIS PEDATA) TO BE PLANTED BENEATH STRUCTURE TO PROVIDE SLOPE STABILIZATION

WOODLAND MIX. (A)+(B)+(C)

WOODLAND MIX. (A)

ANGLE STATION AT LEI NAK SHAN


TOWER 5

FICUS PUMILA TO BE PLANTED @150mm C/C IN A ROW SURROUNDING SUPPORTING COLUMNS

FERN SPECIES (DICRANOPTERIS PEDATA) TO BE PLANTED BENEATH STRUCTURE TO PROVIDE SLOPE STABILIZATION

FICUS PUMILA TO BE PLANTED @150mm C/C IN A ROW SURROUNDING SUPPORTING COLUMNS

HYDROSEEDING TO BE CARRIED OUT PRIOR TO PLANTING.

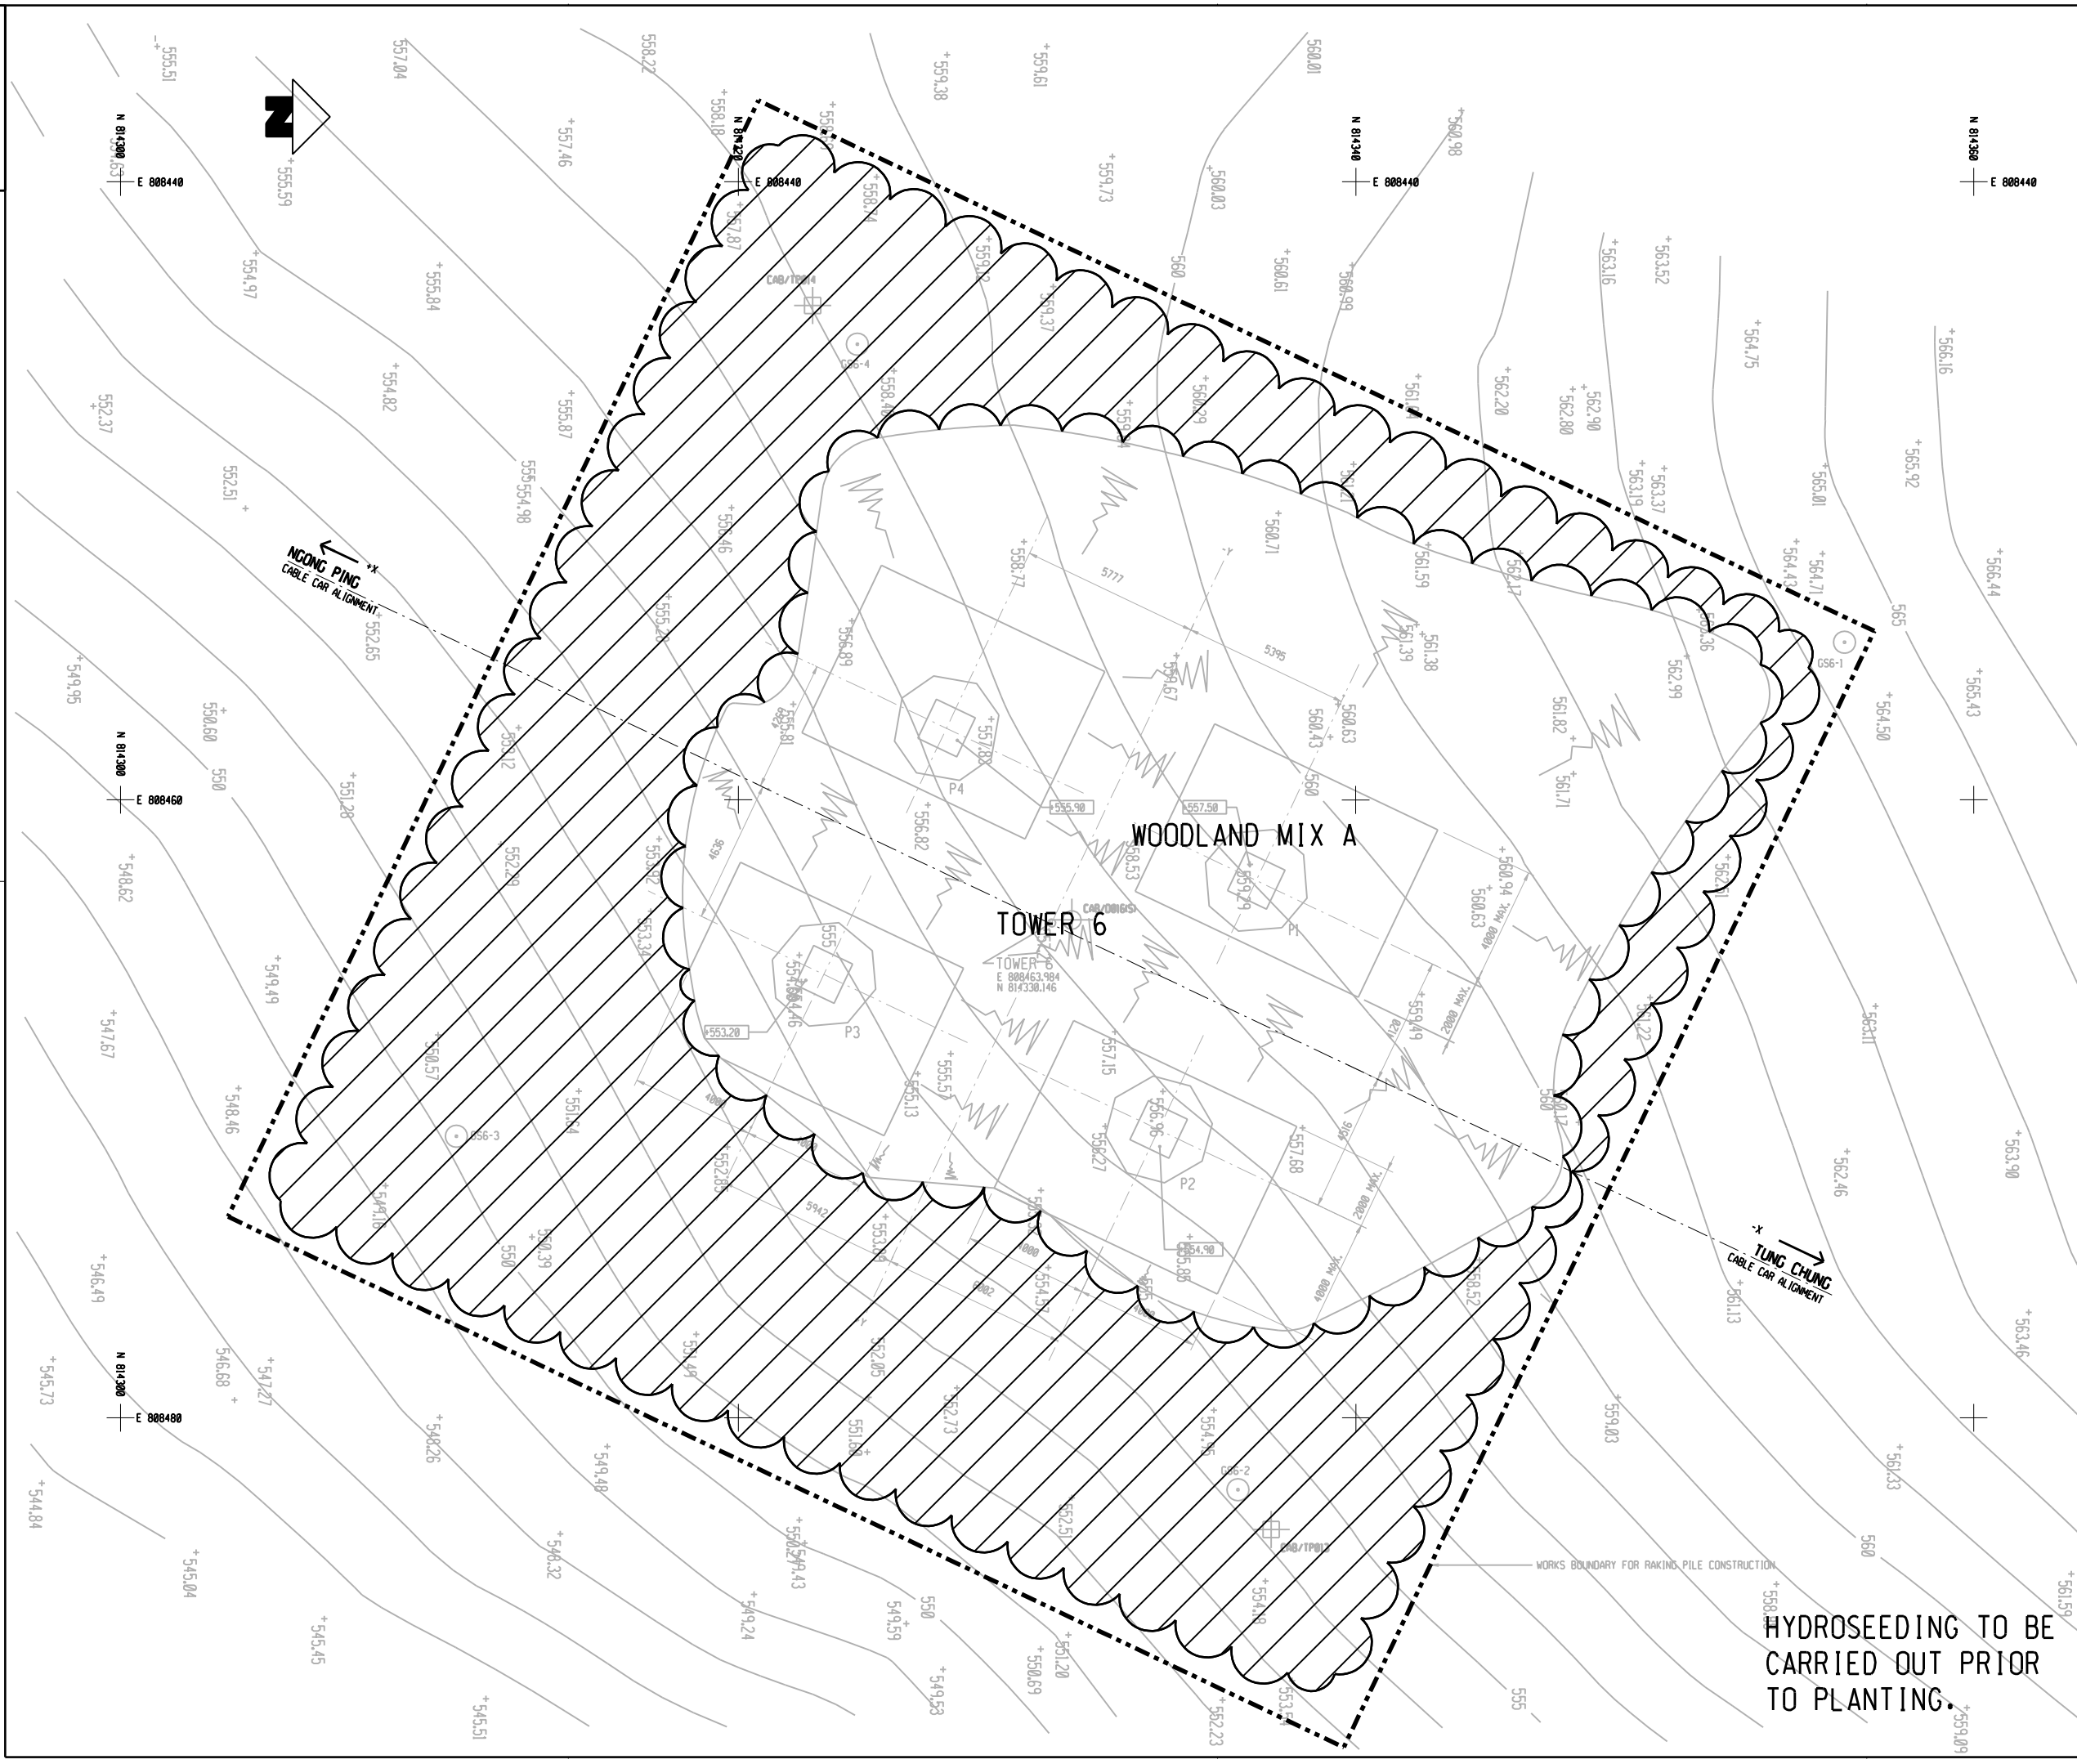

HYDROSEEDING TO BE CARRIED OUT PRIOR TO PLANTING.

NO SP. SCALE DIMENSIONS, VERIFY ALL DIMENSIONS ON SITE.
© 2005 MTR RAILWAY CORPORATION
DESIGNED BY: W.L. WONG / DESIGNED BY: J.W. WONG / AS BUILT BY: J.W. WONG
DRAWN BY: W.L. WONG / CHECKED BY: J.W. WONG / APPROVED BY: S.F. WONG

- LEGENDS:**
- WORKS SITE
 - NEW TREE PLANTING
 - RETAINED TREE
 - TRANSPLANTED TREE
 - PLANTING AREA
 - RETAINED WOODLAND

NOTES:

ALL AREAS TO BE HYDROSEED PRIOR TO PLANTING WORKS TO ASSIST EROSION CONTROL. HYDROSEED MIX TO CONSIST OF CYNODON DACTYLON + PASPALUM NOTATUM. (THERE IS TO BE NO GREEN DYE OR TERRAM COVER TO BE USED WITHIN COUNTRY PARK TO AVOID ANY POLLUTANTS TO PARK)

SELECTED WOODLAND PLANTING MIX TO COVER SOIL NAIL AREA.

PLANT SCHEDULE:
Woodland mix 'A'

Shrubs	Botanical Name	Size(mm)HT.
Ga	Gordonia axillaris	1000mm
Scs	Schima Superba	1000mm
Rt	Rhodomyrtus tomentosa	1000mm
Ms	Melastoma sanguineum	1000mm
Bf	Baeckea frutescens	1000mm
Dp	Dicranopteris pedata	1000mm

Woodland mix 'B'

Sd	Sapium discolor	1000mm
Rc	Rhus chinensis	1000mm
Ls	Litsea rotundifolia	1000mm
Mch	Machilus chinensis	1000mm

Woodland mix 'C'

Mc	Melastoma candidum	1000mm
Mpan	Microcos paniculata	1000mm
Ri	Raphiolepis indica	1000mm
Ss	Sapium sebiferum	1000mm
Sh	Schefflera heptaphylla	1000mm
Mp	Mallotus paniculatus	1000mm

REVISION	DESCRIPTION	BY	DATE	APPROVED


前田建設工業株式会社
Maeda Corporation
 1901-5 NEW EAST OCEAN CENTRE
 9 SCIENCE MUSEUM ROAD
 T.S.T. EAST, KOWLOON, HONG KONG
 TEL : 2269 6267 FAX : 2724 4064

地鐵公司
MTR Corporation
 MTR TOWER
 TELFORD PLAZA - KOWLOON BAY
 HONG KONG
 TEL : 2988 2111 FAX : 2798 8822

東涌吊車
TUNG CHUNG CABLE CAR
凱達柏濤有限公司
Aedas Limited

PROJECT: TOWER 6
ORIGINATOR: Aedas Limited
TITLE: TOWER 6 LANDSCAPE PLANTING PLAN

SCALE	1 : 100 @ A1	CAD REF	AS BUILT APPROVED
DATE	APR. 2005	AS BUILT DWG NO	
DRAWN	WL	DESIGNED JW	DRAWING NO LP-R-17
CHECKED	JW	APPROVED SF	REV A

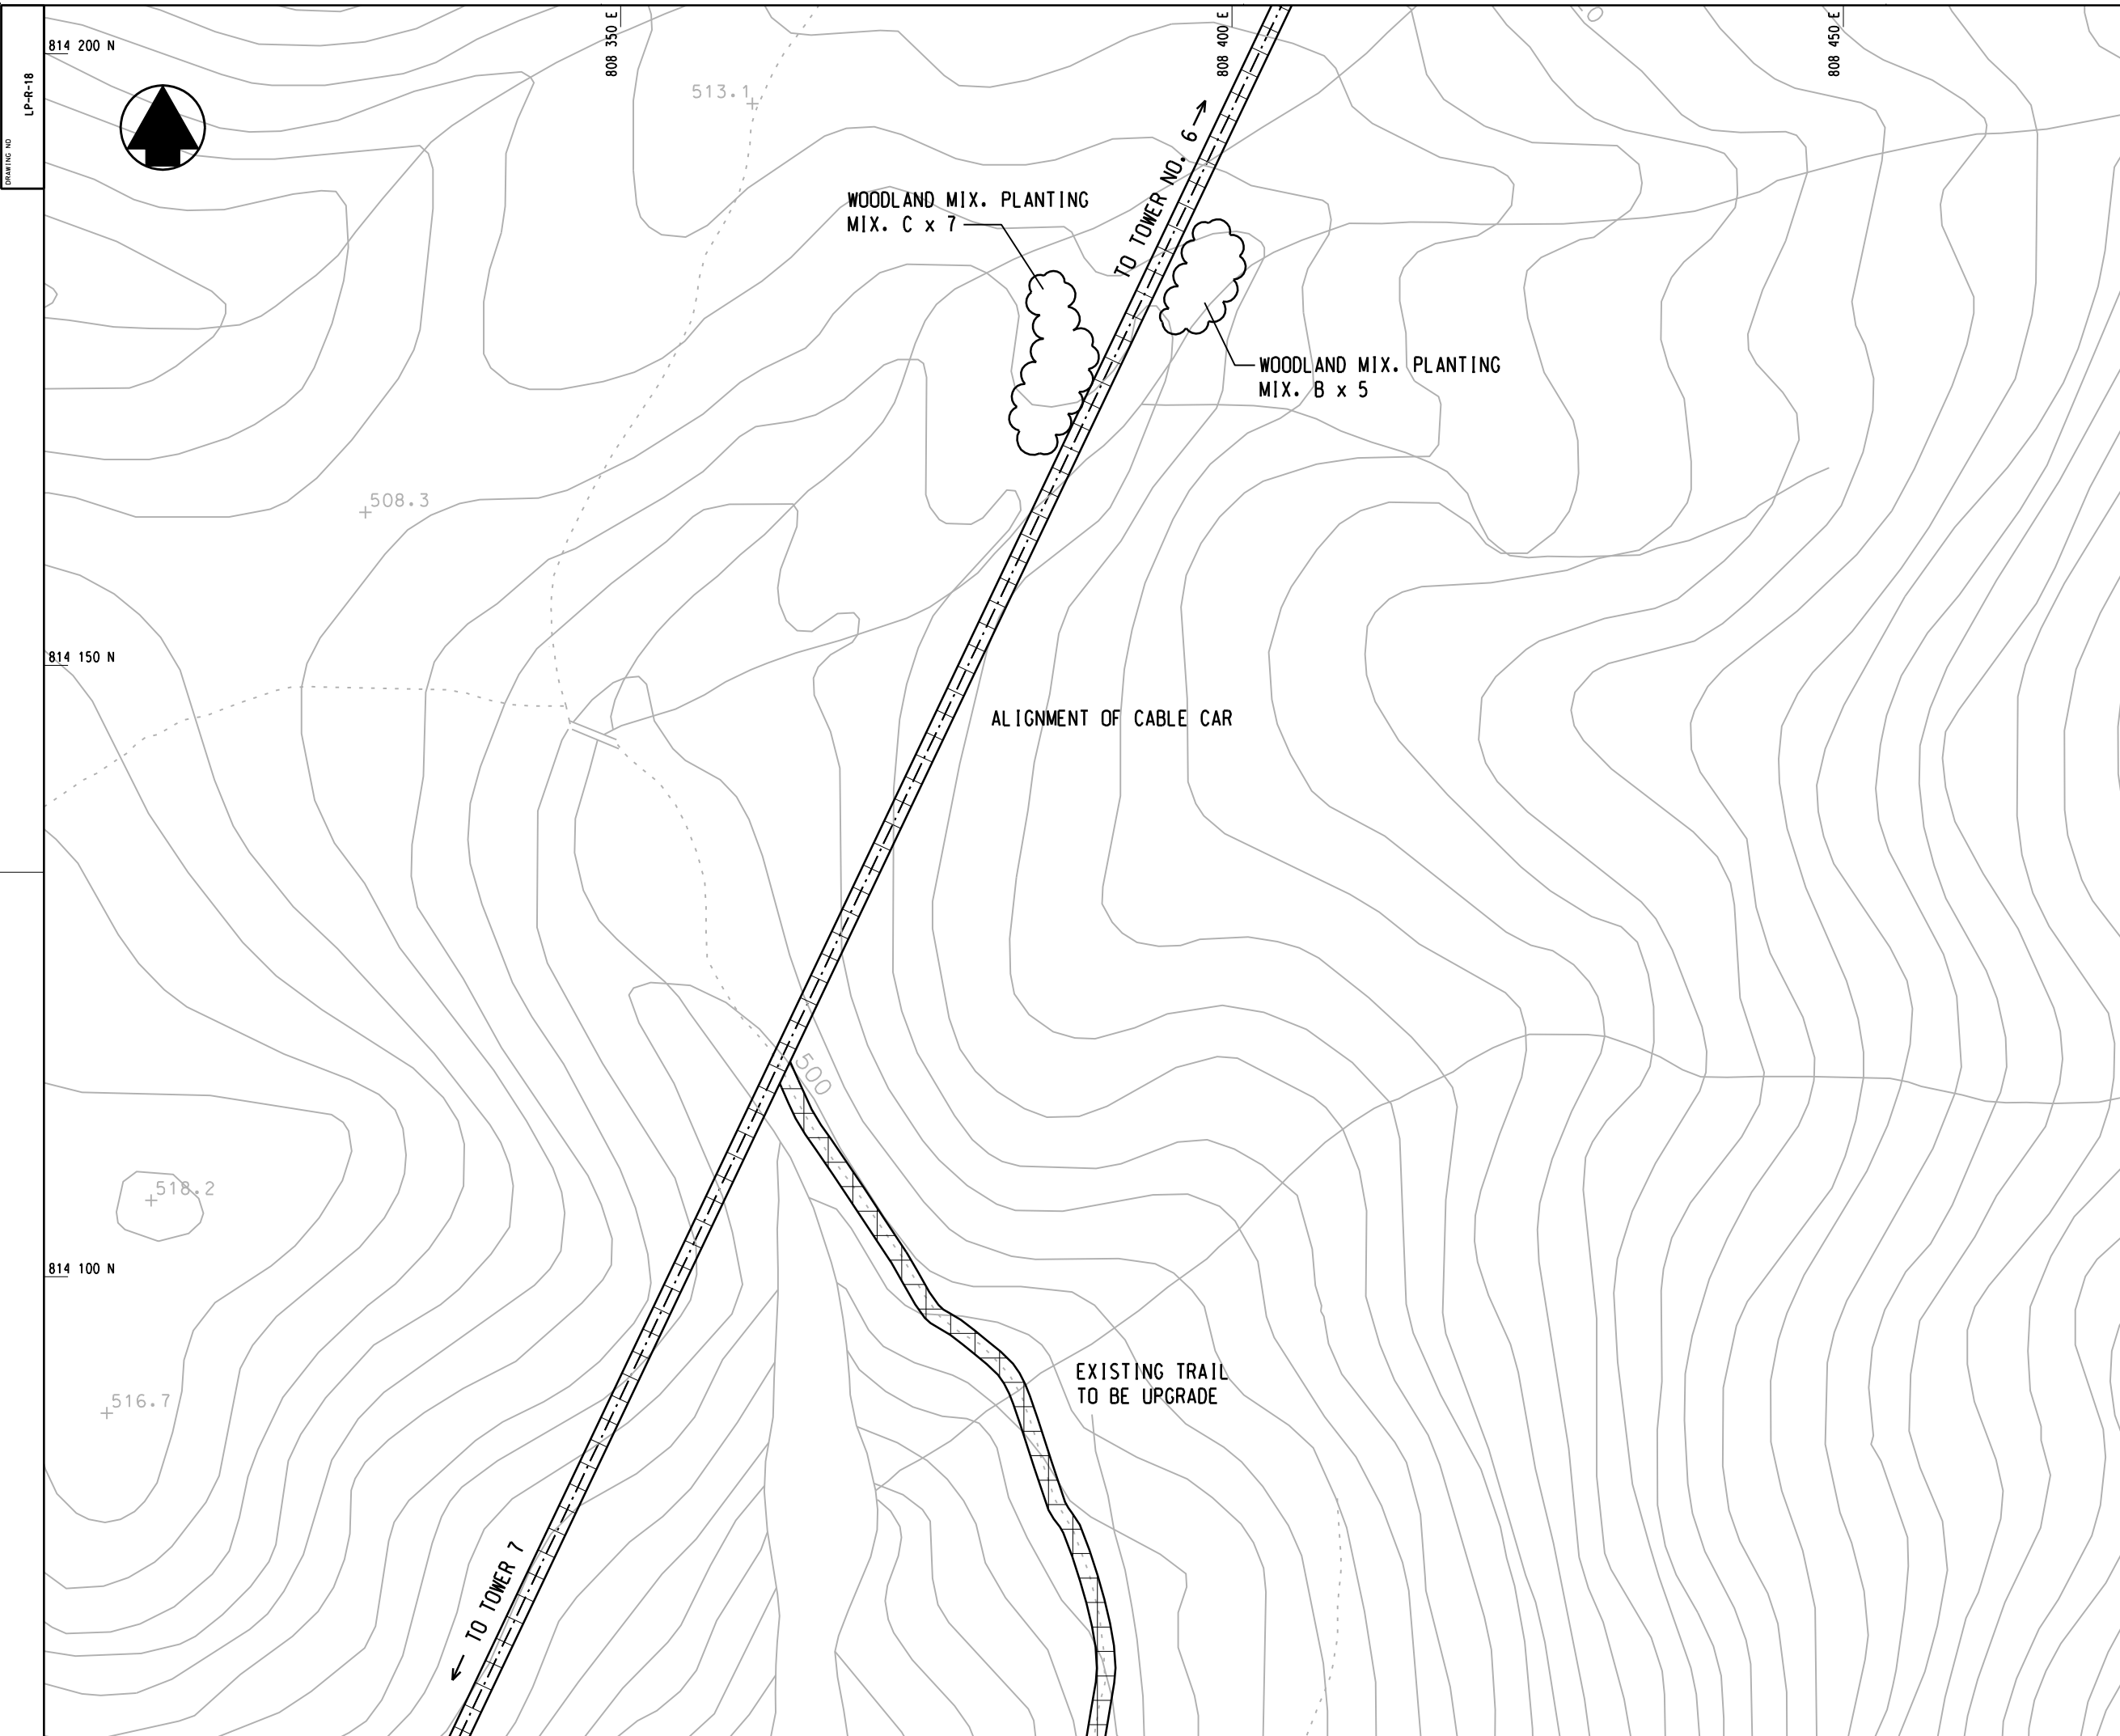

DRAWING NO
LP-R-18



NO PART OF THIS DRAWING, WHOLE OR IN DETAIL, IS TO BE REPRODUCED OR TRANSMITTED IN ANY FORM OR BY ANY MEANS, ELECTRONIC OR MECHANICAL, WITHOUT THE WRITTEN PERMISSION OF THE MTR TRUSTEES COMPANY LIMITED.

- LEGENDS:**
- WORKS SITE
 - NEW TREE PLANTING
 - RETAINED TREE
 - TRANSPLANTED TREE
 - PLANTING AREA
 - RETAINED WOODLAND

NOTES:

ALL AREAS TO BE HYDROSEED PRIOR TO PLANTING WORKS TO ASSIST EROSION CONTROL. HYDROSEED MIX TO CONSIST OF CYNODON DACTYLON + PASPALUM NOTATUM. (THERE IS TO BE NO GREEN DYE OR TERRAM COVER TO BE USED WITHIN COUNTRY PARK TO AVOID ANY POLLUTANTS TO PARK)

PLANT SCHEDULE:

Woodland mix 'A'

Shrubs	Botanical Name	Size(mm)Ht.
Ga	Gordonia axillaris	1000mm
Scs	Schima Superba	1000mm
Rt	Rhodomyrtus tomentosa	1000mm
Ms	Melastoma sanguineum	1000mm
Bf	Baeckea frutescens	1000mm
Dp	Dicranopteris pedata	1000mm

Woodland mix 'B'

Sd	Sapium discolor	1000mm
Rc	Rhus chinensis	1000mm
Ls	Litsea rotundifolia	1000mm
Mch	Machilus chinensis	1000mm

Woodland mix 'C'

Mc	Melastoma candidum	1000mm
Mpan	Microcos paniculata	1000mm
Ri	Rhaphiolepis indica	1000mm
Ss	Sapium sebiferum	1000mm
Sh	Schefflera heptaphylla	1000mm
Mp	Mallotus paniculatus	1000mm

REVISION	DESCRIPTION	BY	DATE	APPROVED

前田建設工業株式会社
 Maeda Corporation
 1001-5 NEW EAST OCEAN CENTRE
 9 SCIENCE MUSEUM ROAD
 T.S.T. EAST, KOWLOON, HONG KONG
 TEL.: 2599 0287 FAX.: 2724 4084

地鐵公司
 MTR Corporation
 MTR TOWER
 TELFORD PLAZA - KOWLOON BAY
 HONG KONG
 TEL.: 2988 2111 FAX.: 2798 9822

東涌吊車
 TUNG CHUNG CABLE CAR


凱達柏濤有限公司
 Aedas Limited

TITLE

RESCUE TRAIL BETWEEN TOWER 6 AND TOWER 7
LANDSCAPE PLANTING PLAN

SCALE	1 : 250 @ A1	CAD REF	AS BUILT APPROVED
DATE	FEB. 2005	AS BUILT DWG NO	
DRAWN	WL	DESIGNED	JW
CHECKED	JW	APPROVED	SF
DRAWING NO	LP-R-18	REV	A

DRAWING NO
LP-R-19

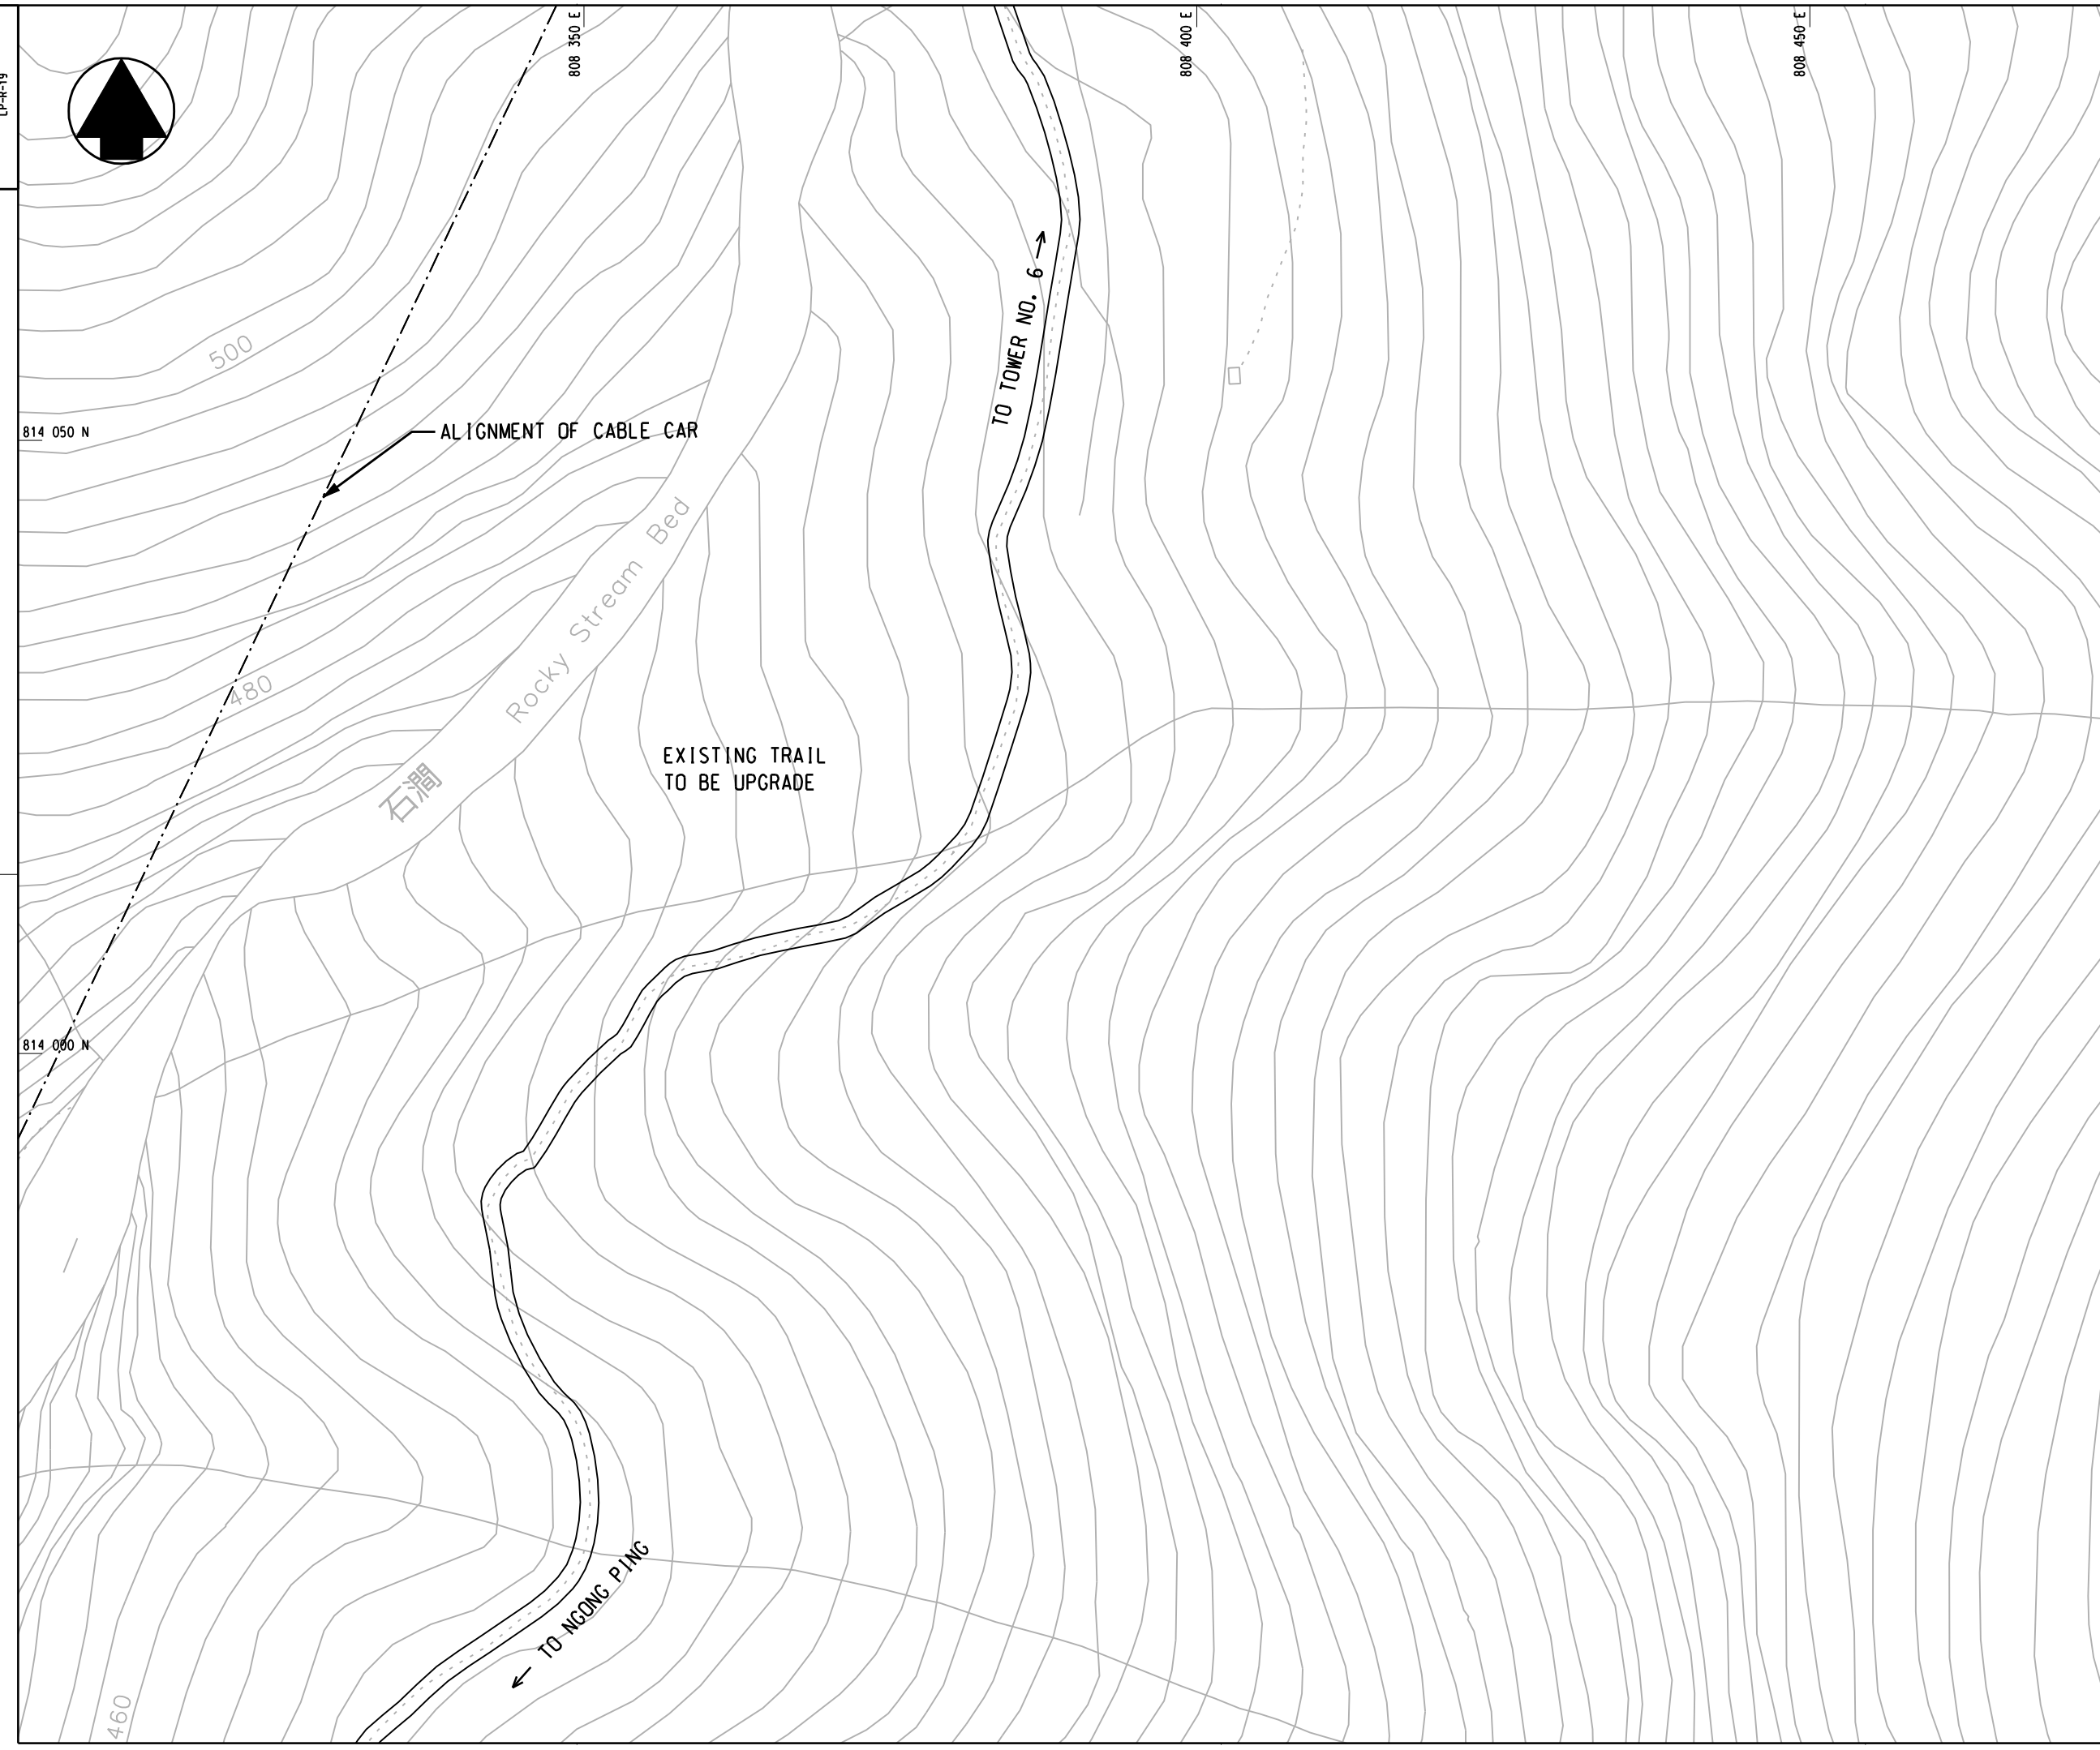

NO NEW SCALE DRAWINGS. VERIFY ALL DIMENSIONS ON SITE.
© 2002 HONG KONG CABLE CAR CORPORATION
DESIGNED BY: J.W. LAM / DRAWN BY: J.W. LAM / CHECKED BY: S.F. CHAN / APPROVED BY: S.F. CHAN
IF ANY PART OF THIS DRAWING IS TO BE REPRODUCED OR TRANSMITTED IN ANY FORM OR BY ANY MEANS, WITHOUT THE WRITTEN PERMISSION OF THE HONG KONG CABLE CAR CORPORATION.

- LEGENDS:**
- WORKS SITE
 - NEW TREE PLANTING
 - RETAINED TREE
 - TRANSPLANTED TREE
 - PLANTING AREA
 - RETAINED WOODLAND

NOTES:

ALL AREAS TO BE HYDROSEED PRIOR TO PLANTING WORKS TO ASSIST EROSION CONTROL. HYDROSEED MIX TO CONSIST OF CYNODON DACTYLON + PASPALUM NOTATUM. (THERE IS TO BE NO GREEN DYE OR TERRAM COVER TO BE USED WITHIN COUNTRY PARK TO AVOID ANY POLLUTANTS TO PARK)

REVISION	DESCRIPTION	BY	DATE	APPROVED

前田建設工業株式会社
Maeda Corporation
1001-5 NEW EAST OCEAN CENTRE
9 SCIENCE MUSEUM ROAD
T.S.T. EAST, KOWLOON, HONG KONG
TEL.: 2589 0287 FAX.: 2724 4084


地鐵公司
MTR Corporation
MTR TOWER
TELFORD PLAZA - KOWLOON BAY
HONG KONG
TEL.: 2988 2111 FAX.: 2798 9822

PROJECT 東涌吊車
TUNG CHUNG CABLE CAR

ORIGINATOR 凱達柏濤有限公司
Aedas Limited

TITLE
RESCUE TRAIL FROM NGONG PING TO TOWER 6
LANDSCAPE PLANTING PLAN

SCALE	1 : 250 @ A1	CAD REF		AS BUILT APPROVED
DATE	08APR2003	AS BUILT DWG NO		
DRAWN	WL	DESIGNED	JW	DRAWING NO LP-R-19
CHECKED	JW	APPROVED	SF	REV A

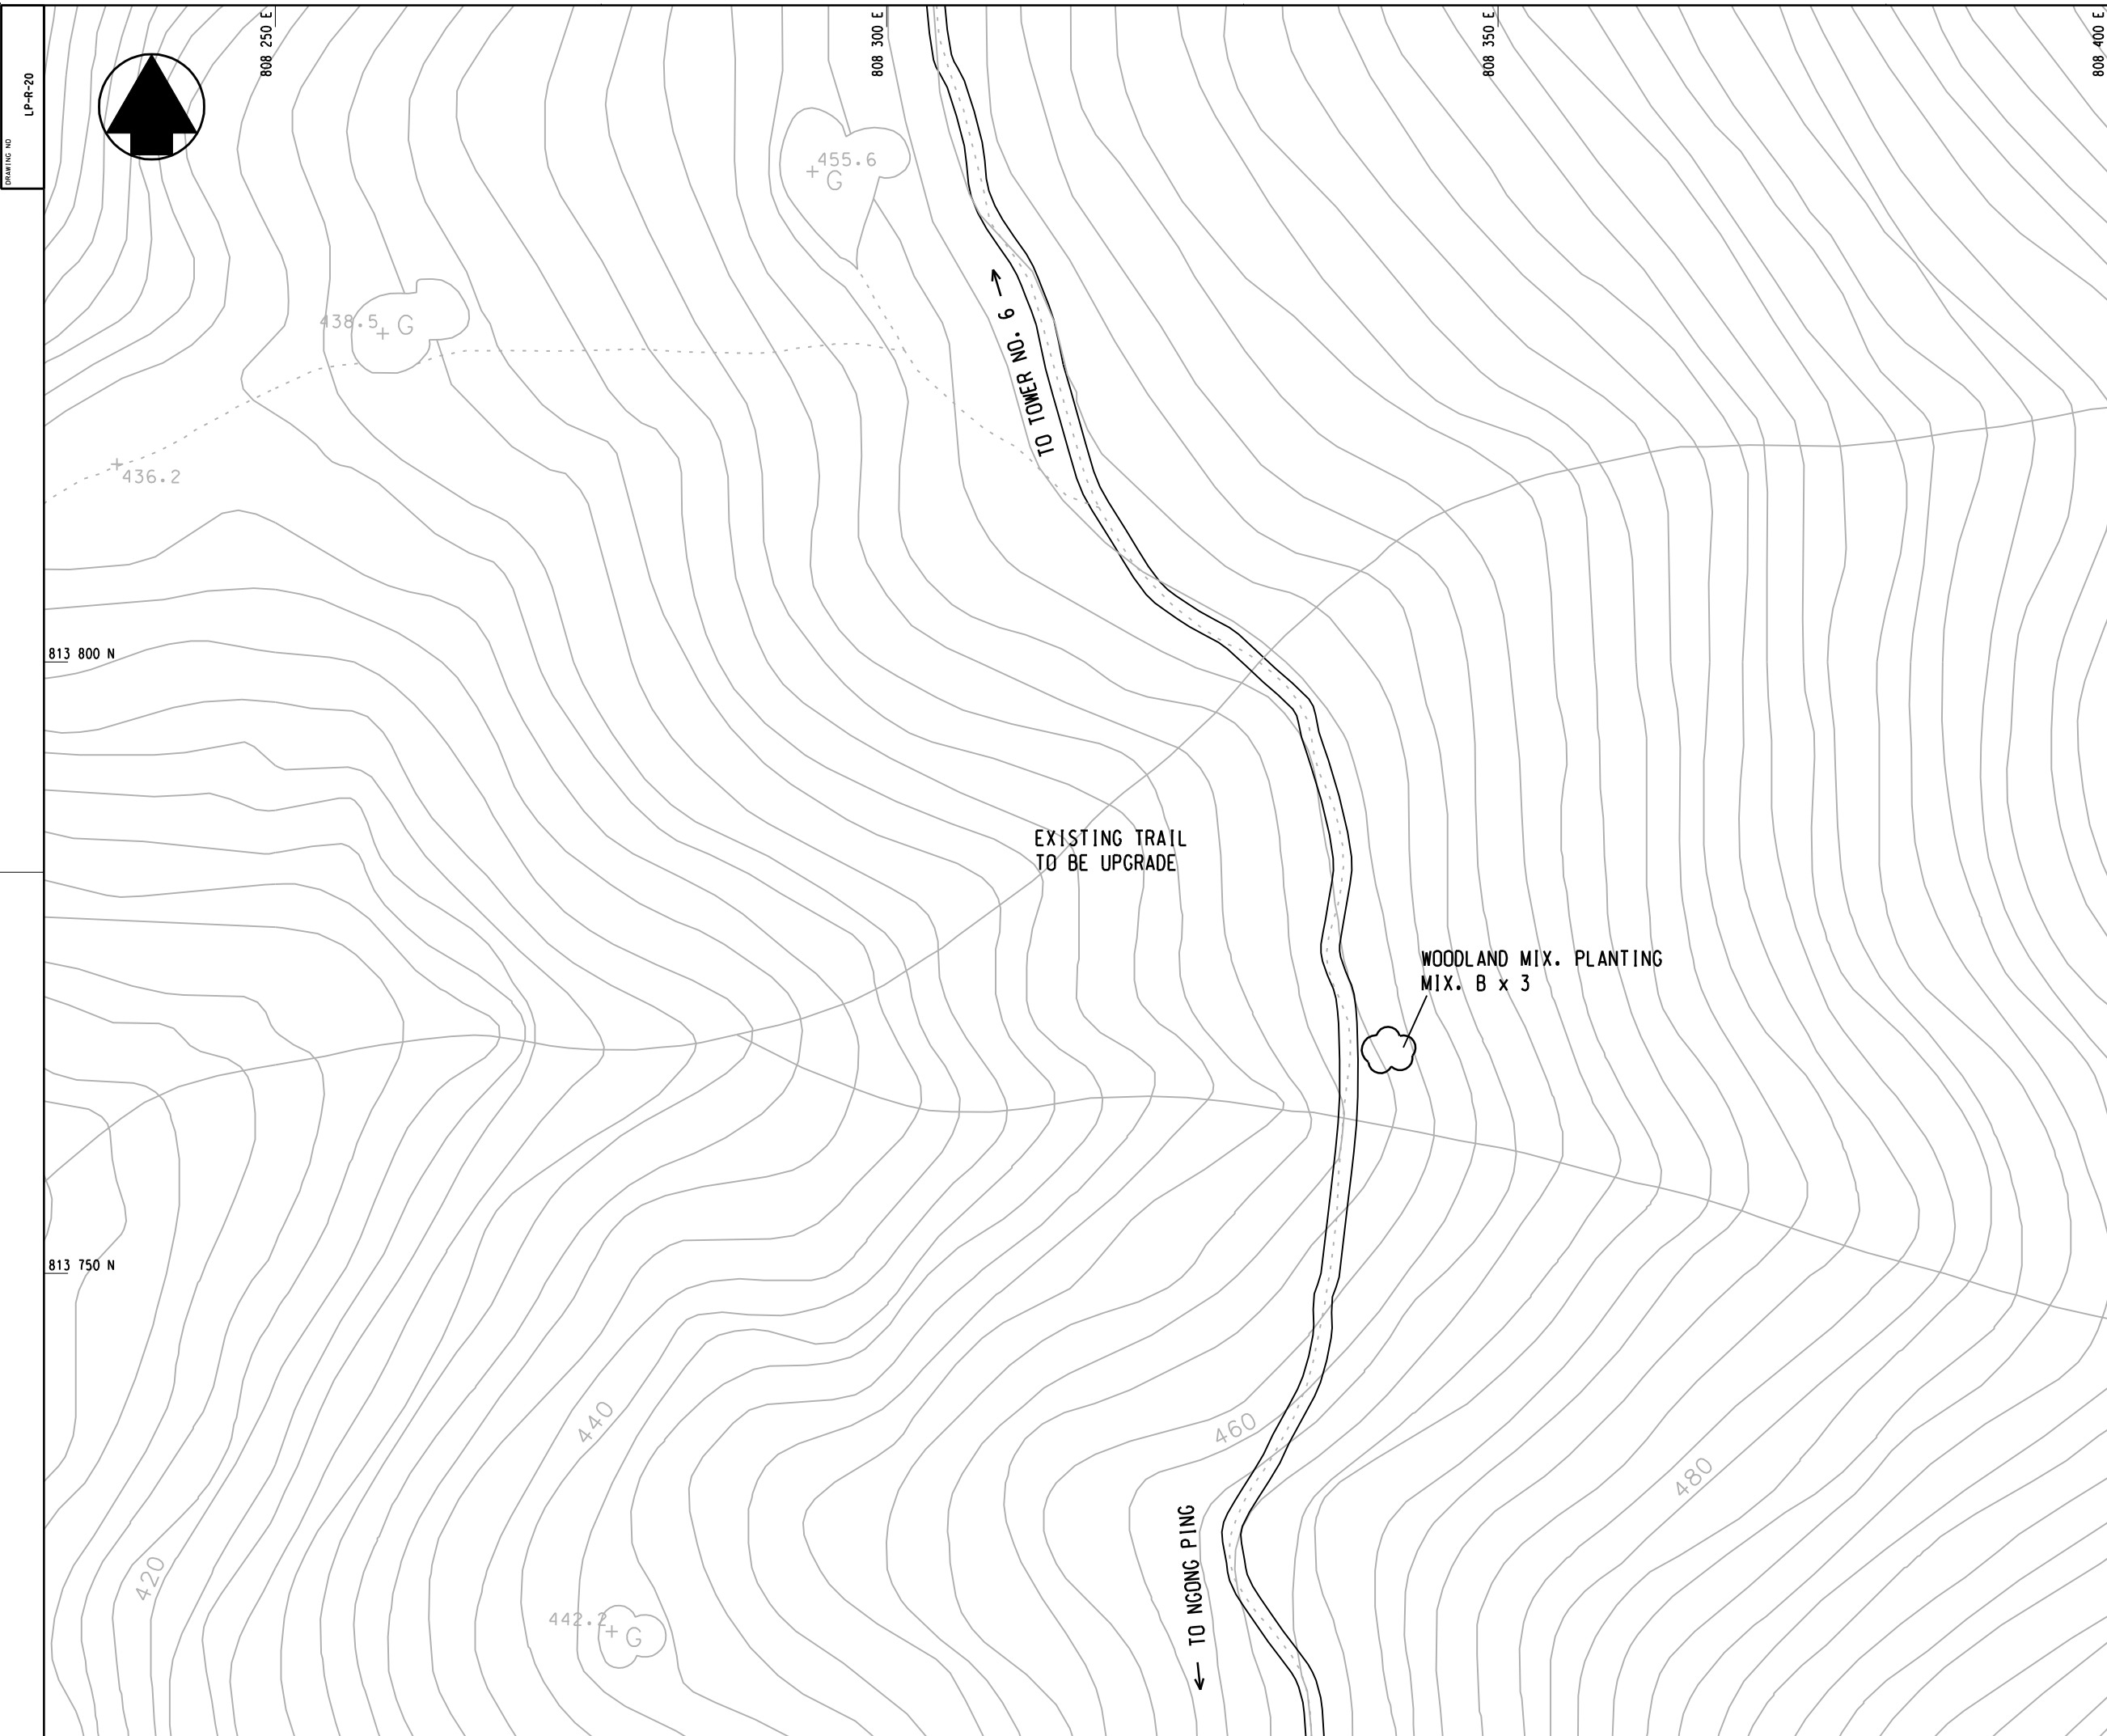

DRAWING NO
LP-R-20

NO PART OF THIS DRAWING, WHATEVER THE SCALE, IS TO BE REPRODUCED OR TRANSMITTED IN ANY FORM OR BY ANY MEANS, ELECTRONIC OR MECHANICAL, INCLUDING PHOTOCOPYING, RECORDING, OR BY ANY INFORMATION STORAGE AND RETRIEVAL SYSTEM, WITHOUT THE WRITTEN CONSENT OF THE HKS HONEYWELL INTERNATIONAL CORPORATION.

- LEGENDS:**
- WORKS SITE
 - NEW TREE PLANTING
 - RETAINED TREE
 - TRANSPLANTED TREE
 - PLANTING AREA
 - RETAINED WOODLAND

NOTES:

ALL AREAS TO BE HYDROSEED PRIOR TO PLANTING WORKS TO ASSIST EROSION CONTROL. HYDROSEED MIX TO CONSIST OF CYNODON DACTYLON + PASPALUM NOTATUM. (THERE IS TO BE NO GREEN DYE OR TERRAM COVER TO BE USED WITHIN COUNTRY PARK TO AVOID ANY POLLUTANTS TO PARK)

PLANT SCHEDULE:

Woodland mix 'A'

Shrubs	Botanical Name	Size(mm)Ht.
Ga	Gordonia axillaris	1000mm
Scs	Schima Superba	1000mm
Rt	Rhodomyrtus tomentosa	1000mm
Ms	Melastoma sanguineum	1000mm
Bf	Baeckea frutescens	1000mm
Dp	Dicranopteris pedata	1000mm

Woodland mix 'B'

Shrubs	Botanical Name	Size(mm)Ht.
Sd	Sapium discolor	1000mm
Rc	Rhus chinensis	1000mm
Ls	Litsea rotundifolia	1000mm
Mch	Machilus chinensis	1000mm

Woodland mix 'C'

Shrubs	Botanical Name	Size(mm)Ht.
Mc	Melastoma candidum	1000mm
Mpan	Microcos paniculata	1000mm
Ri	Rhaphiolepis indica	1000mm
Ss	Sapium sebiferum	1000mm
Sh	Schefflera heptaphylla	1000mm
Mp	Mallotus paniculatus	1000mm

REVISION	DESCRIPTION	BY	DATE	APPROVED

前田建設工業株式会社
Maeda Corporation
 1001-5 NEW EAST OCEAN CENTRE
 9 SCIENCE MUSEUM ROAD
 T.S.T. EAST, KOWLOON, HONG KONG
 TEL.: 2598 0287 FAX.: 2724 4084

地鐵公司
MTR Corporation
 MTR TOWER
 TELFORD PLAZA - KOWLOON BAY
 HONG KONG
 TEL.: 2988 2111 FAX.: 2798 9822


東涌吊車
TUNG CHUNG CABLE CAR

凱達柏濤有限公司
Aedas Limited

TITLE

RESCUE TRAIL FROM NGONG PING TO TOWER 6
LANDSCAPE PLANTING PLAN

SCALE	1:500 (A3)	CAD REF	AS BUILT
DATE	FEB. 2005	AS BUILT DWG NO	
DRAWN	WL	DESIGNED	JW
CHECKED	JW	APPROVED	SF
DRAWING NO	LP-R-20		REV
			A

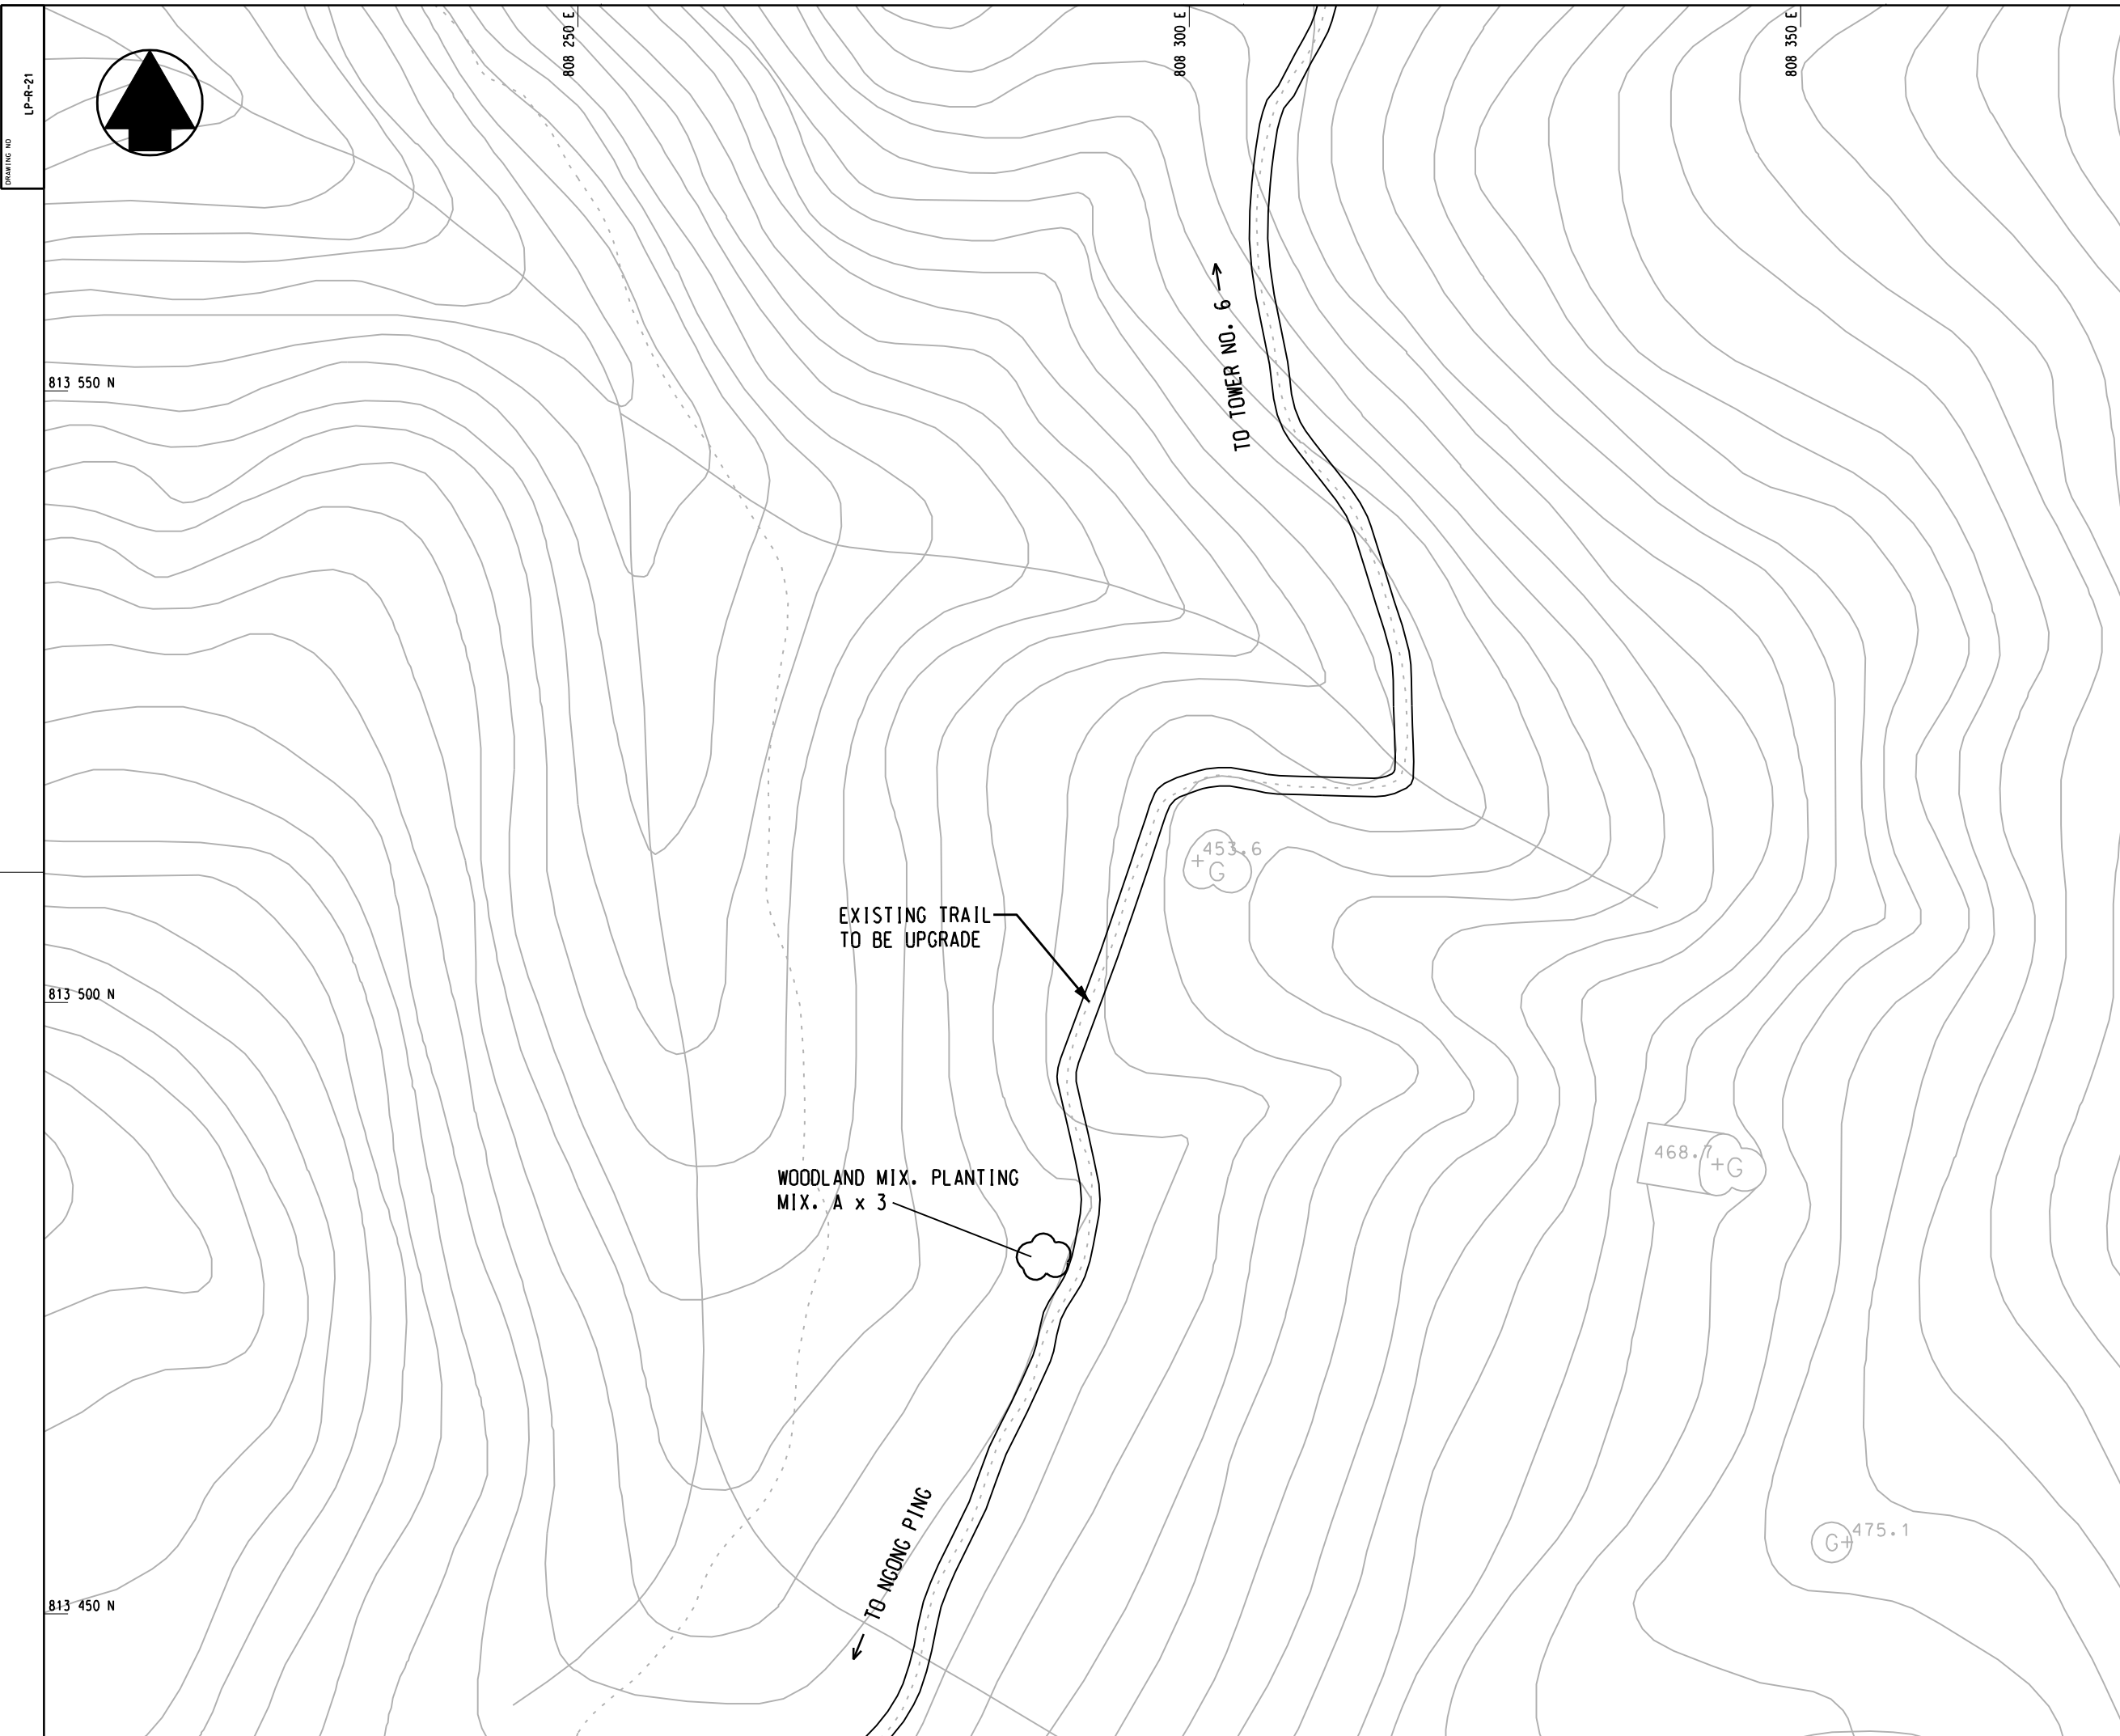

DRAWING NO
LP-R-21



NO PART SHALL BE REPRODUCED OR TRANSMITTED IN ANY FORM OR BY ANY MEANS, ELECTRONIC OR MECHANICAL, WITHOUT THE WRITTEN PERMISSION OF THE DESIGNER.

- LEGENDS:**
- WORKS SITE
 - NEW TREE PLANTING
 - RETAINED TREE
 - TRANSPLANTED TREE
 - PLANTING AREA
 - RETAINED WOODLAND

NOTES:

ALL AREAS TO BE HYDROSEEDED PRIOR TO PLANTING WORKS TO ASSIST EROSION CONTROL. HYDROSEED MIX TO CONSIST OF CYNODON DACTYLON + PASPALUM NOTATUM. (THERE IS TO BE NO GREEN DYE OR TERRAM COVER TO BE USED WITHIN COUNTRY PARK TO AVOID ANY POLLUTANTS TO PARK)

PLANT SCHEDULE:

Woodland mix 'A'

Shrubs	Botanical Name	Size(mm)Ht.
Ga	Gordonia axillaris	1000mm
Scs	Schima Superba	1000mm
Rt	Rhodomyrtus tomentosa	1000mm
Ms	Melastoma sanguineum	1000mm
Bf	Baeckea frutescens	1000mm
Dp	Dicranopteris pedata	1000mm

Woodland mix 'B'

Sd	Sapium discolor	1000mm
Rc	Rhus chinensis	1000mm
Ls	Litsea rotundifolia	1000mm
Mch	Machilus chinensis	1000mm

Woodland mix 'C'


Mc	Melastoma candidum	1000mm
Mpan	Microcos paniculata	1000mm
Ri	Rhaphiolepis indica	1000mm
Ss	Sapium sebiferum	1000mm
Sh	Schefflera heptaphylla	1000mm
Mp	Mallotus paniculatus	1000mm

REVISION	DESCRIPTION	BY	DATE	APPROVED
前田建設工業株式会社 地鐵公司 東涌吊車 凱達柏濤有限公司				
PROJECT: 東涌吊車 TUNG CHUNG CABLE CAR ORIGINATOR: 凱達柏濤有限公司 Aedas Limited				

TITLE

RESCUE TRAIL FROM NGONG PING TO TOWER 6
LANDSCAPE PLANTING PLAN

SCALE	1 : 250 @ A1	CAD REF		AS BUILT APPROVED
DATE	FEB. 2005	AS BUILT DWG NO		
DRAWN	WL	DESIGNED	JW	DRAWING NO LP-R-21
CHECKED	JW	APPROVED	SF	REV A

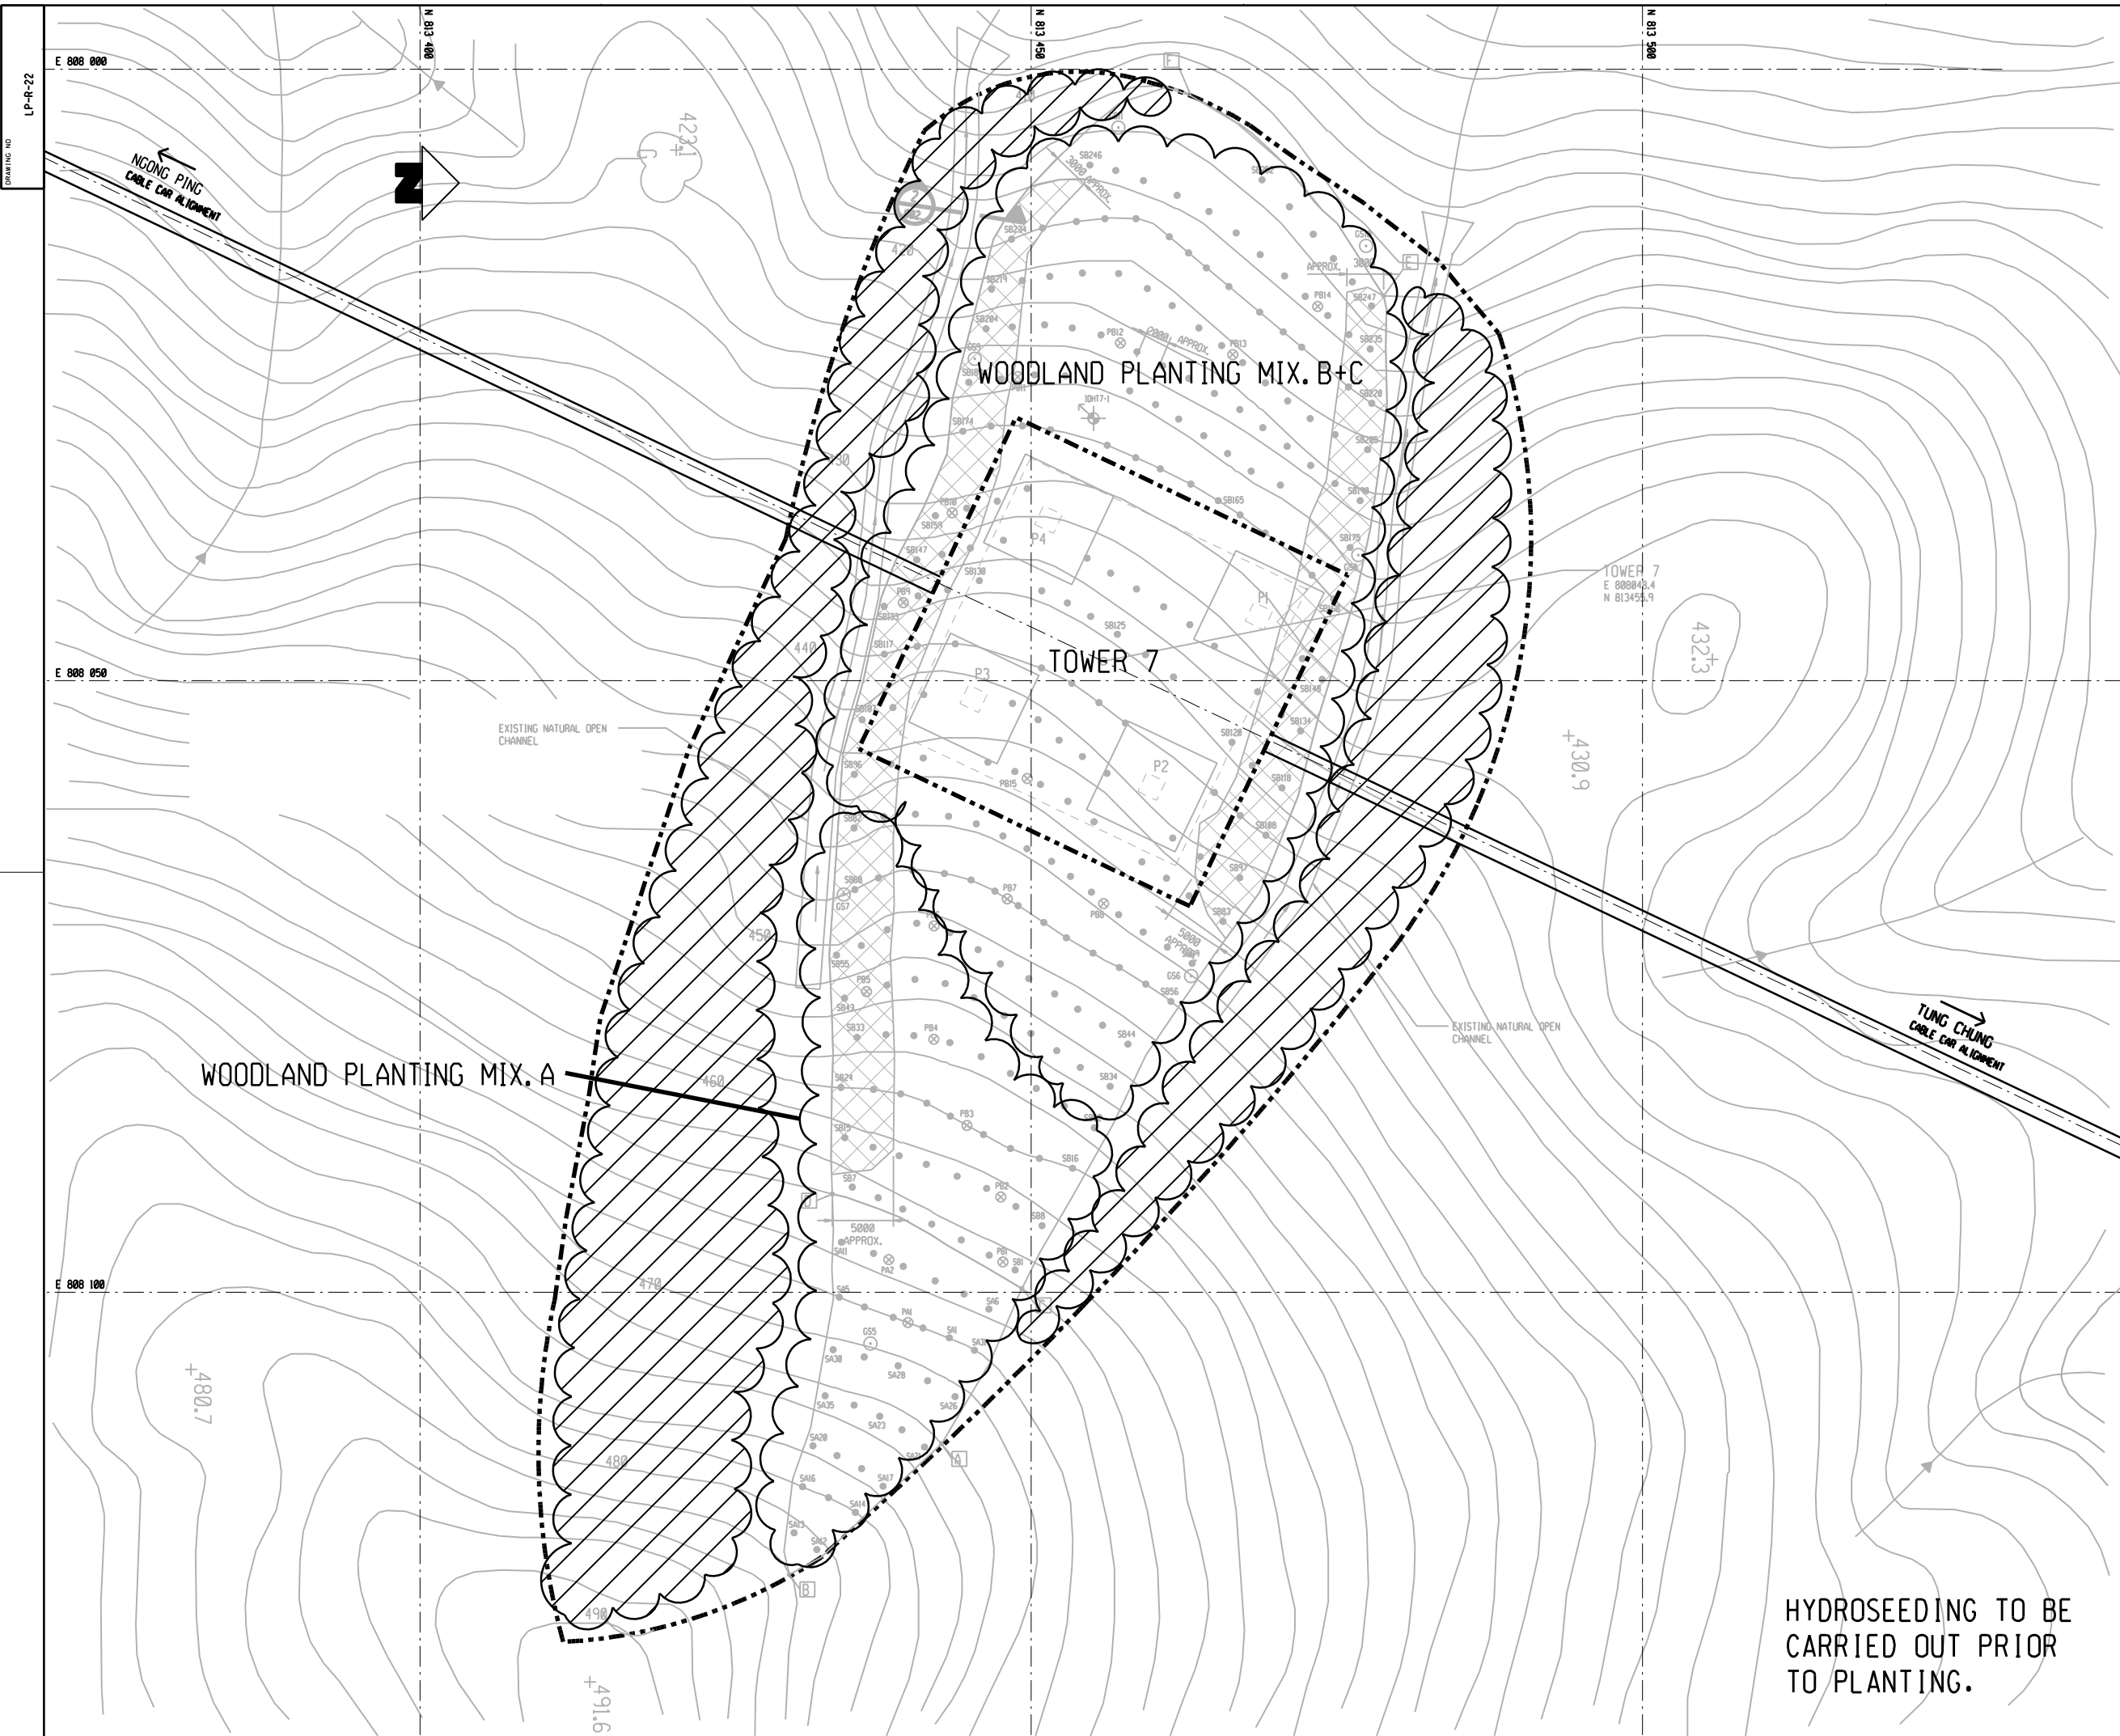

NO WORK SHALL BE UNDERTAKEN WITHOUT THE APPROVAL OF THE AUTHORITIES.
 ALL AREAS TO BE HYDROSEEDED PRIOR TO PLANTING WORKS TO ASSIST EROSION CONTROL. HYDROSEED MIX TO CONSIST OF CYNODON DACTYLON + PASPALUM NOTATUM. (THERE IS TO BE NO GREEN DYE OR TERRAM COVER TO BE USED WITHIN COUNTRY PARK TO AVOID ANY POLLUTANTS TO PARK)
 NATIVE PLANTING TO BLEND WITH EXISTING ENVIRONMENT.
 SELECTED WOODLAND PLANTING MIX TO COVER SOIL NAIL AREA.

- LEGENDS:**
- WORKS SITE
 - NEW TREE PLANTING
 - RETAINED TREE
 - ⊗ TRANSPLANTED TREE
 - ☁ PLANTING AREA
 - ▨ RETAINED WOODLAND

NOTES:

ALL AREAS TO BE HYDROSEEDED PRIOR TO PLANTING WORKS TO ASSIST EROSION CONTROL. HYDROSEED MIX TO CONSIST OF CYNODON DACTYLON + PASPALUM NOTATUM. (THERE IS TO BE NO GREEN DYE OR TERRAM COVER TO BE USED WITHIN COUNTRY PARK TO AVOID ANY POLLUTANTS TO PARK)

NATIVE PLANTING TO BLEND WITH EXISTING ENVIRONMENT.

SELECTED WOODLAND PLANTING MIX TO COVER SOIL NAIL AREA.

PLANT SCHEDULE:

Woodland mix 'A'

Shrubs	Botanical Name	Size(mm)Ht.
Ga	Gordonia axillaris	1000mm
Scs	Schima Superba	1000mm
Rt	Rhodomyrtus tomentosa	1000mm
Ms	Melastoma sanguineum	1000mm
Bf	Baeckea frutescens	1000mm
Dp	Dicranopteris pedata	1000mm

Woodland mix 'B'

Sd	Sapium discolor	1000mm
Rc	Rhus chinensis	1000mm
Ls	Litsea rotundifolia	1000mm
Mch	Machilus chinensis	1000mm

Woodland mix 'C'

Mc	Melastoma candidum	1000mm
Mpan	Microcos paniculata	1000mm
Ri	Raphiolepis indica	1000mm
Ss	Sapium sebiferum	1000mm
Sh	Schefflera heptaphylla	1000mm
Mp	Mallotus paniculatus	1000mm

REVISION	DESCRIPTION	BY	DATE	APPROVED
前田建設工業株式会社 Maeda Corporation 1001-5 NEW EAST OCEAN CENTRE 9 SCIENCE MUSEUM ROAD T.S.T. EAST, KOWLOON, HONG KONG TEL.: 2268 6267 FAX: 2264 4064				
地鐵公司 MTR Corporation MTR TOWER TELFORD PLAZA - KOWLOON BAY HONG KONG TEL.: 2988 2111 FAX: 2798 8822				

PROJECT 東涌吊車
 TUNG CHUNG CABLE CAR


ORIGINATOR 凱達柏濤有限公司
 Aedas Limited

TITLE

TOWER 7
 LANDSCAPE PLANTING PLAN

SCALE	1 : 250 @ A1	CAD REF		AS BUILT APPROVED
DATE	APR. 2005	AS BUILT DWG NO		
DRAWN	WL	DESIGNED	JW	DRAWING NO LP-R-22
CHECKED	JW	APPROVED	SF	REV A

HYDROSEEDING TO BE CARRIED OUT PRIOR TO PLANTING.

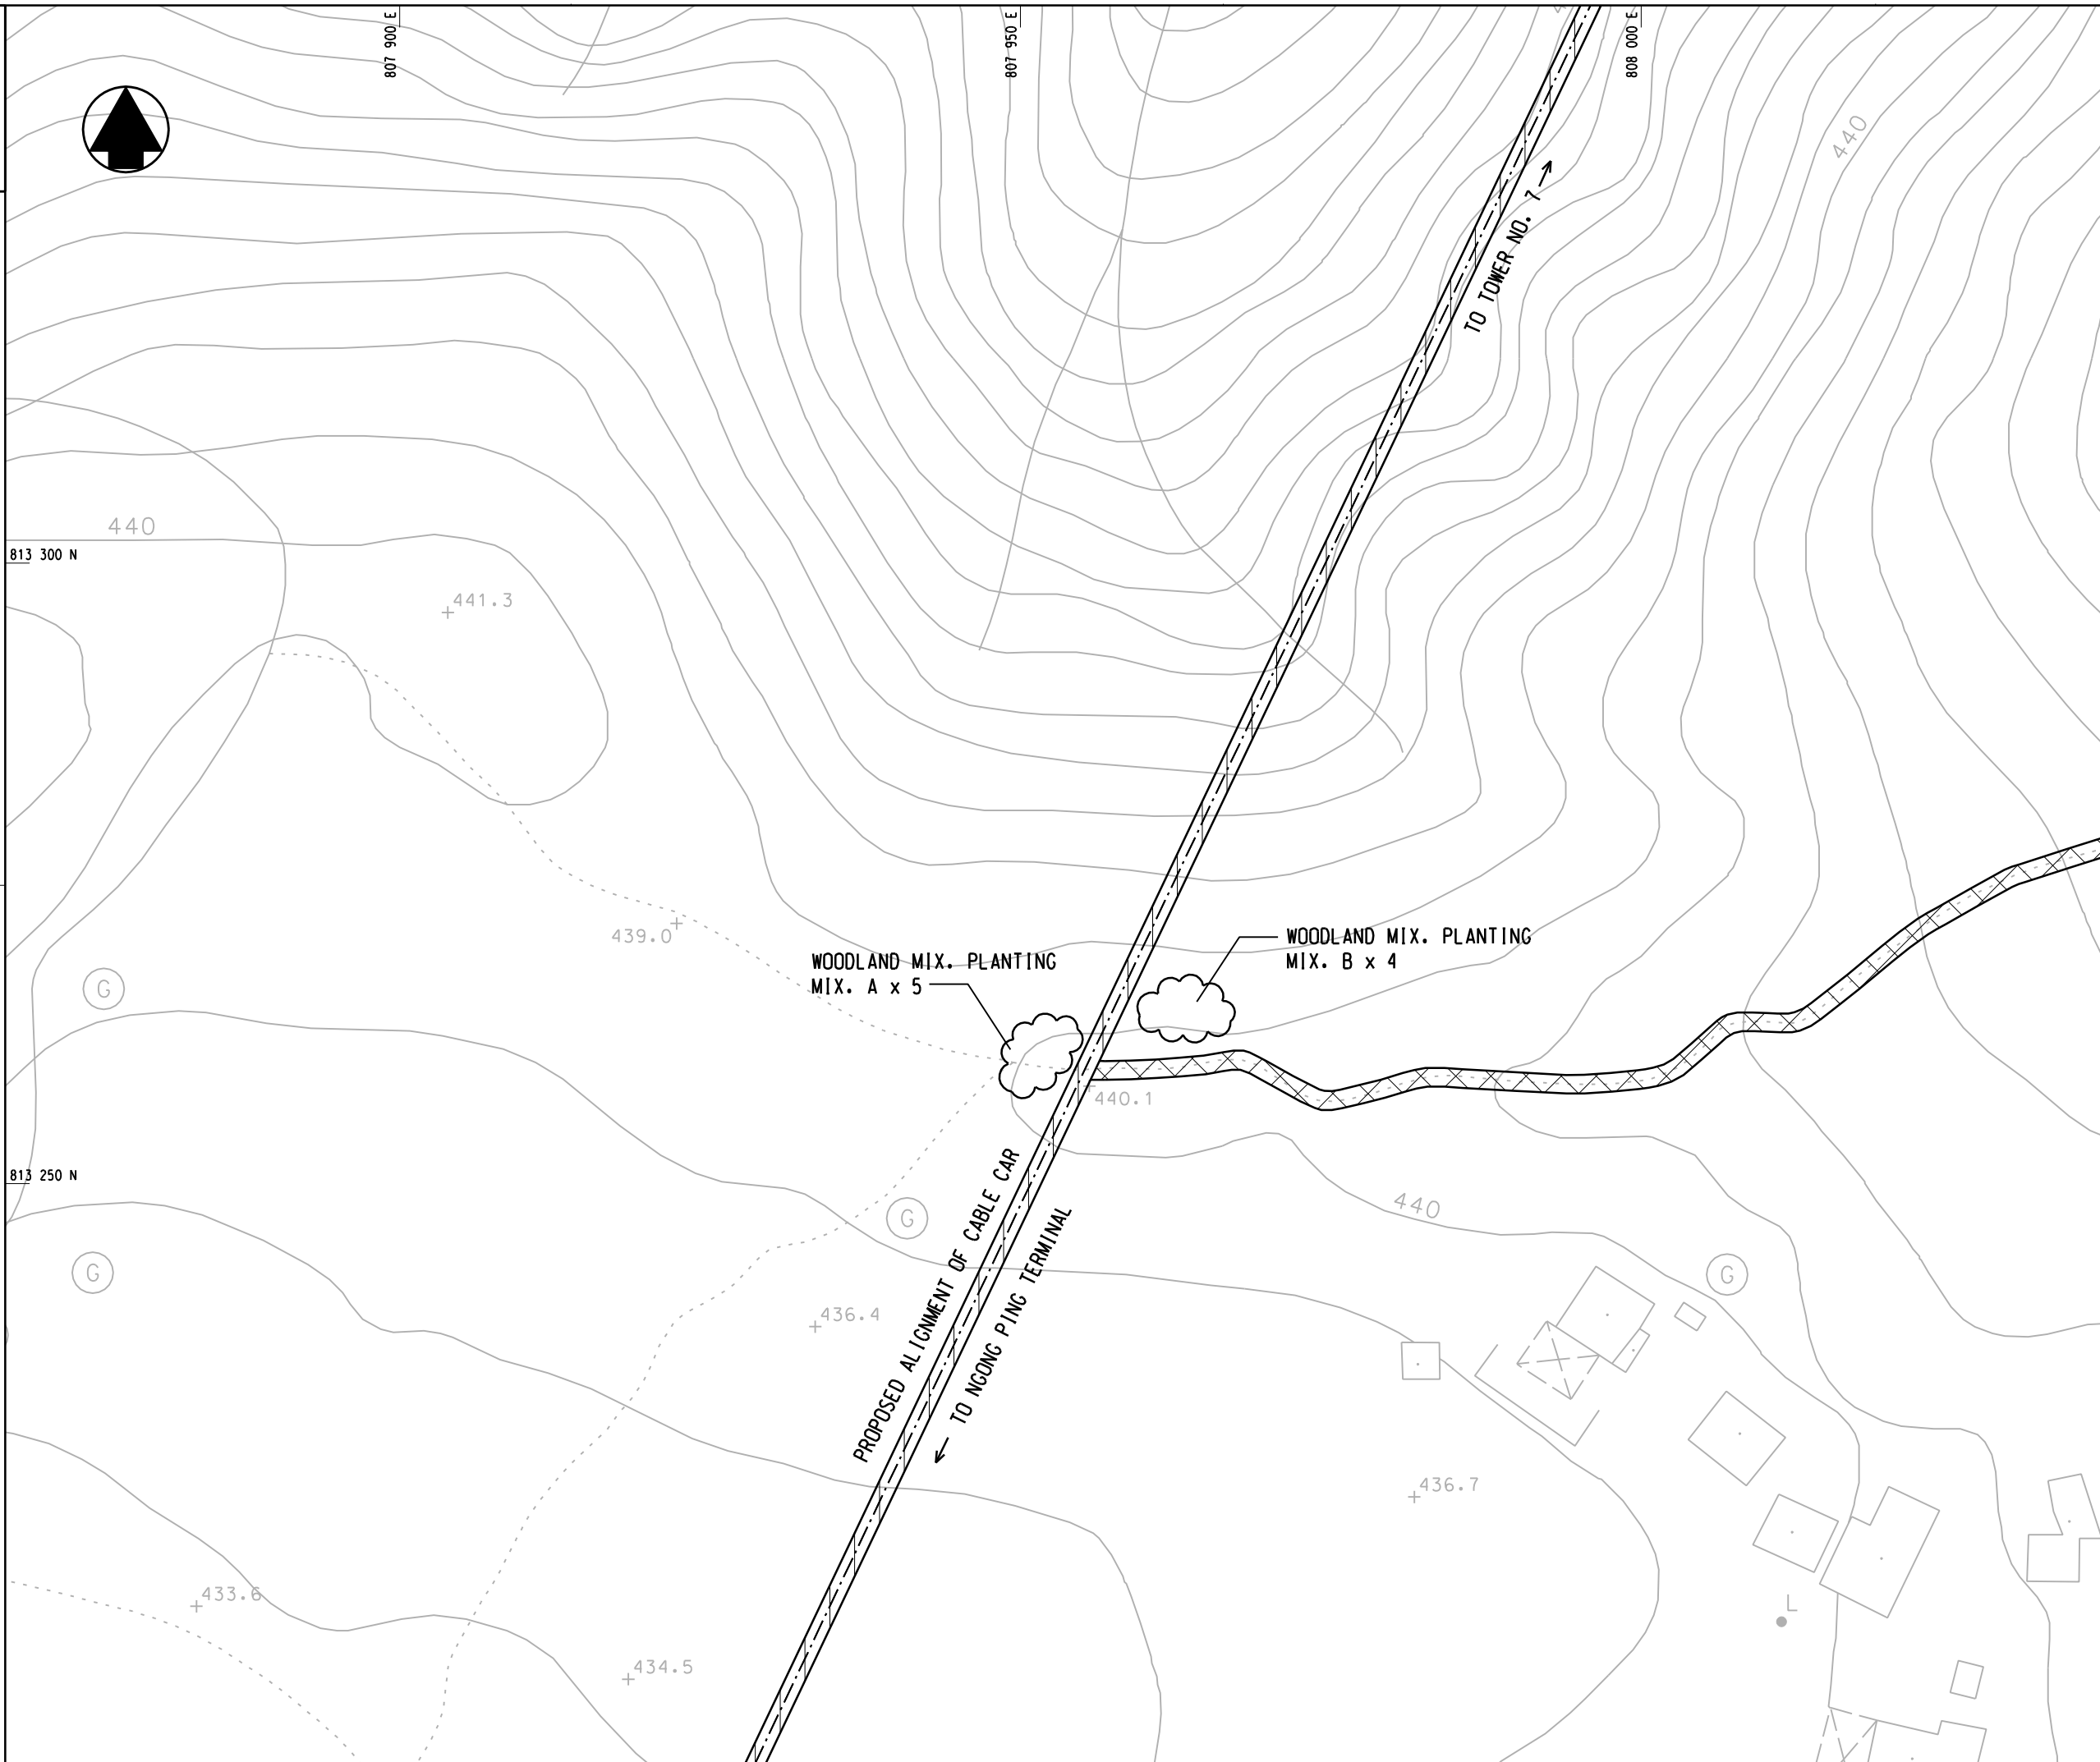

NO PART SHALL BE REPRODUCED OR TRANSMITTED IN ANY FORM OR BY ANY MEANS, ELECTRONIC OR MECHANICAL, INCLUDING PHOTOCOPYING, RECORDING, OR BY ANY INFORMATION STORAGE AND RETRIEVAL SYSTEM, WITHOUT THE WRITTEN CONSENT OF THE MTR CORPORATION.

- LEGENDS:**
- WORKS SITE
 - NEW TREE PLANTING
 - RETAINED TREE
 - TRANSPLANTED TREE
 - PLANTING AREA
 - RETAINED WOODLAND

NOTES:

ALL AREAS TO BE HYDROSEED PRIOR TO PLANTING WORKS TO ASSIST EROSION CONTROL. HYDROSEED MIX TO CONSIST OF CYNODON DACTYLON + PASPALUM NOTATUM. (THERE IS TO BE NO GREEN DYE OR TERRAM COVER TO BE USED WITHIN COUNTRY PARK TO AVOID ANY POLLUTANTS TO PARK)

PLANT SCHEDULE:

Woodland mix 'A'

Shrubs	Botanical Name	Size(mm)HT.
Ga	Gordonia axillaris	1000mm
Scs	Schima Superba	1000mm
Rt	Rhodomyrtus tomentosa	1000mm
Ms	Melastoma sanguineum	1000mm
Bf	Baeckea frutescens	1000mm
Dp	Dicranopteris pedata	1000mm

Woodland mix 'B'

Shrubs	Botanical Name	Size(mm)HT.
Sd	Sapium discolor	1000mm
Rc	Rhus chinensis	1000mm
Ls	Litsea rotundifolia	1000mm
Mch	Machilus chinensis	1000mm

Woodland mix 'C'

Shrubs	Botanical Name	Size(mm)HT.
Mc	Melastoma candidum	1000mm
Mpan	Micracos paniculata	1000mm
Ri	Rhaphiolepis indica	1000mm
Ss	Sapium sebiferum	1000mm
Sh	Schefflera heptaphylla	1000mm
Mp	Mallotus paniculatus	1000mm

REVISION	DESCRIPTION	BY	DATE	APPROVED

前田建設工業株式会社
Maeda Corporation
1001-5 NEW EAST OCEAN CENTRE
9 SCIENCE MUSEUM ROAD
T.S.T. EAST, KOWLOON, HONG KONG
TEL.: 2599 6287 FAX: 2724 4084


地鐵公司
MTR Corporation
MTR TOWER
TELFORD PLAZA - KOWLOON BAY
HONG KONG
TEL.: 2983 2111 FAX: 2798 9822

PROJECT
東涌吊車
TUNG CHUNG CABLE CAR

ORIGINATOR
凱達柏濤有限公司
Aedas Limited

TITLE
RESCUE TRAIL FROM TOWER 7 TO
NGONG PING TERMINAL
LANDSCAPE PLANTING PLAN

SCALE	1 : 250 @ A1	CAD REF	AS BUILT APPROVED
DATE	FEB. 2005	AS BUILT DWG NO	
DRAWN	WL	DESIGNED JW	DRAWING NO LP-R-23
CHECKED	JW	APPROVED SF	REV A

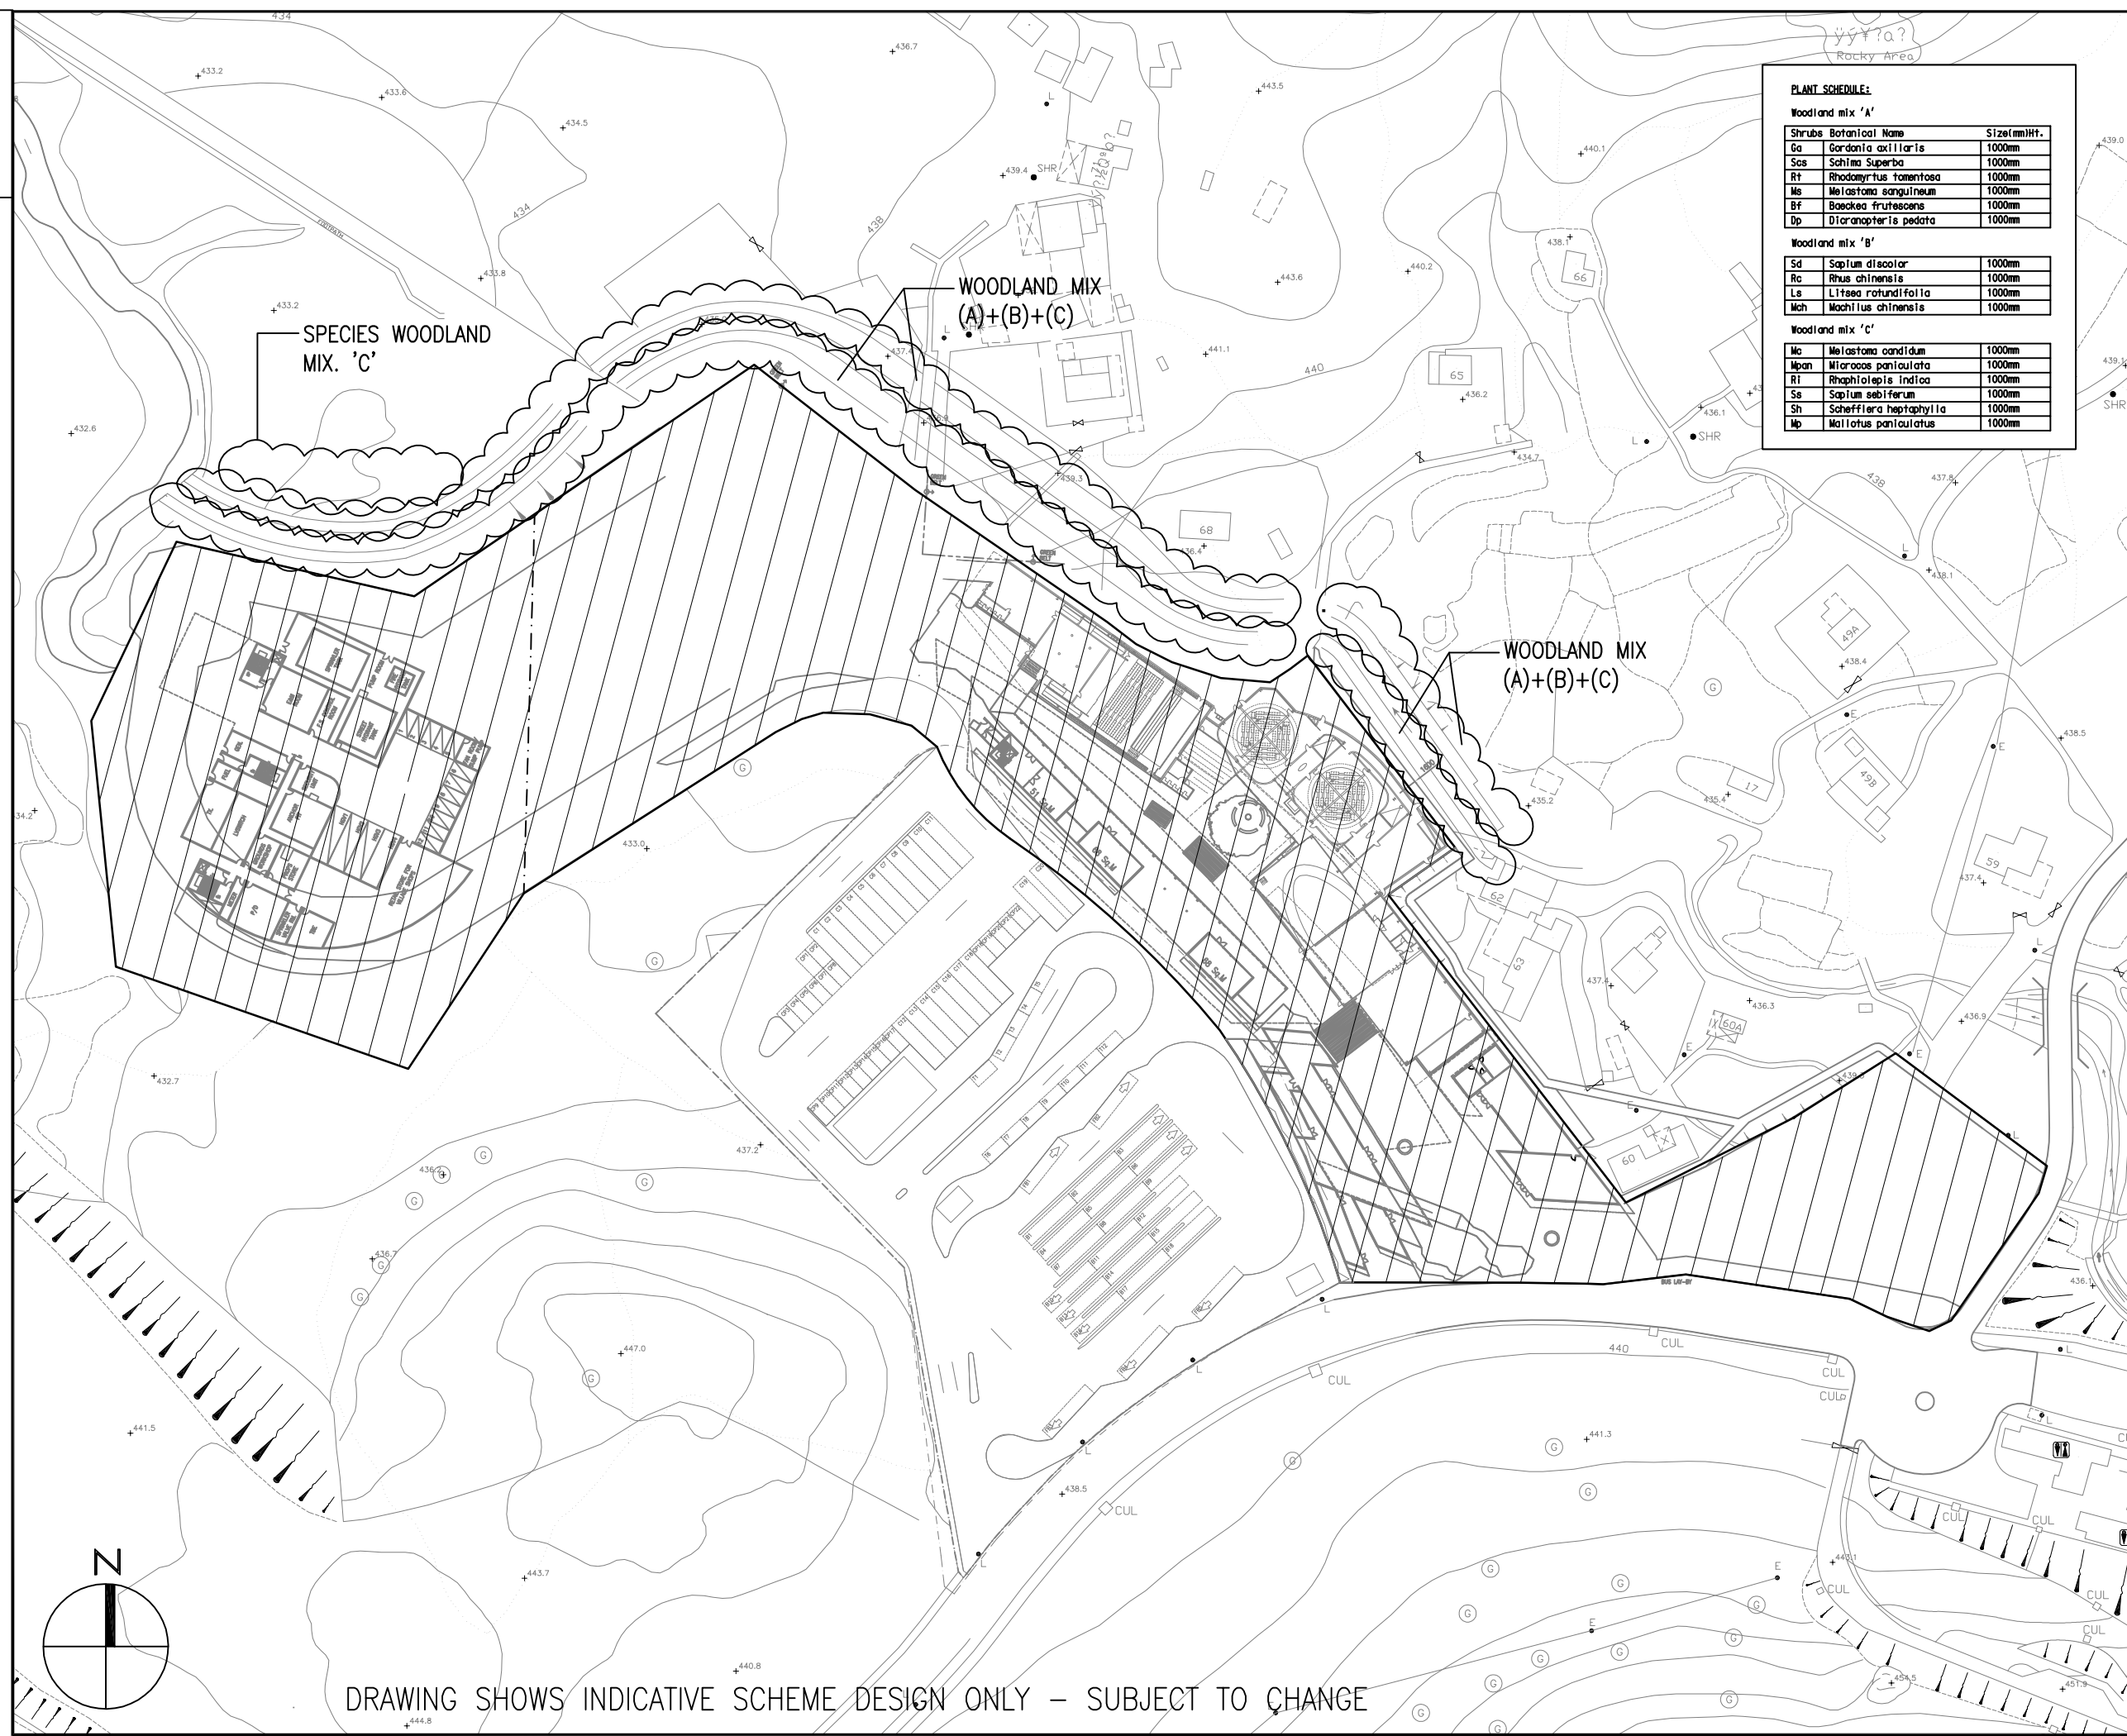

PLANT SCHEDULE:

Shrubs	Botanical Name	Size(mm)HT.
Ga	Gordonia axillaris	1000mm
Scs	Schinus Superba	1000mm
Rt	Rhodomyrtus tomentosa	1000mm
Ms	Melastoma sanguineum	1000mm
Bf	Baeckea frutescens	1000mm
Dp	Dicranopteris pedata	1000mm

Woodland mix 'B'

Sd	Sapinum discolor	1000mm
Rc	Rhus chinensis	1000mm
Ls	Litsea rotundifolia	1000mm
Mah	Machilus chinensis	1000mm

Woodland mix 'C'

Ma	Melastoma candidum	1000mm
Mpan	Micrascos paniculata	1000mm
Ri	Rhaphiopsis indica	1000mm
Ss	Sapinum sebiferum	1000mm
Sh	Schefflera heptaphylla	1000mm
Mp	Mollis paniculatus	1000mm

DO NOT SCALE DRAWING. VERIFY ALL DIMENSIONS ON SITE.
 © AND ALL RIGHTS RESERVED BY THE CONSULTANT. THIS DRAWING IS THE PROPERTY OF THE CONSULTANT AND IS NOT TO BE REPRODUCED OR TRANSMITTED IN ANY FORM OR BY ANY MEANS, ELECTRONIC OR MECHANICAL, WITHOUT THE PRIOR WRITTEN CONSENT OF THE CONSULTANT.

LEGEND:

- WORKS SITE
- NEW TREE PLANTING
- ⊗ RETAINED TREE
- ⊗ TRANSPLANTED TREE
- ☁ PLANTING AREA
- ▨ RETAINED WOODLAND
- S1 LOCATION OF SOIL NAIL
- P4 TOWER BASE NO.
- ⊕ A219 PROTECTED TREES
- ▨ SEE NPT+NPTV LANDSCAPE DRAWING

NOTES:


ALL AREAS TO BE HYDROSEED PRIOR TO PLANTING WORKS TO ASSIST EROSION CONTROL. HYDROSEED MIX TO CONSIST OF CYNODON DACTYLON + PASPALUM NOTIATUM. (THERE IS TO BE NO GREEN DYE OR TERRAZO COVER TO BE USED WITHIN COUNTRY PARK TO AVOID ANY POLLUTANTS TO PARK)

WOODLAND PLANTINGS WILL BE SPACED ACCORDING TO EXISTING CONDITIONS OF SITE + PLANTINGS.(RANGING FROM 2-5 METRES CENTRES)

LAYOUT OF WOODLAND MIX TO BE IN A RANDOM DESIGN.

REVISION	DESCRIPTION	BY	DATE	APPROVED
<p>MTR TOWER TELFORD PLAZA - KOWLOON BAY HONG KONG TEL : 2393 2111 FAX : 2798 8822</p>				
TUNG CHUNG CABLE CAR				
<p>Planning, Urban Design, Landscape, Golf & Environmental Consultant 11/F, 2/F, 3/F, 4/F, 99/F, 100/F</p>				
ORIGINATOR				
TITLE				
STREAM COURSE DIVERSION + EVA WOODLAND PLANTINGS				
SCALE	1:250	CAD REF		AS BUILT APPROVED
DATE	08_JULY_2003	AS BUILT DWG NO		REV
DRAWN	DESIGNED	DRAWING NO	LP-R-24	A
CHECKED	APPROVED			

DRAWING SHOWS INDICATIVE SCHEME DESIGN ONLY - SUBJECT TO CHANGE

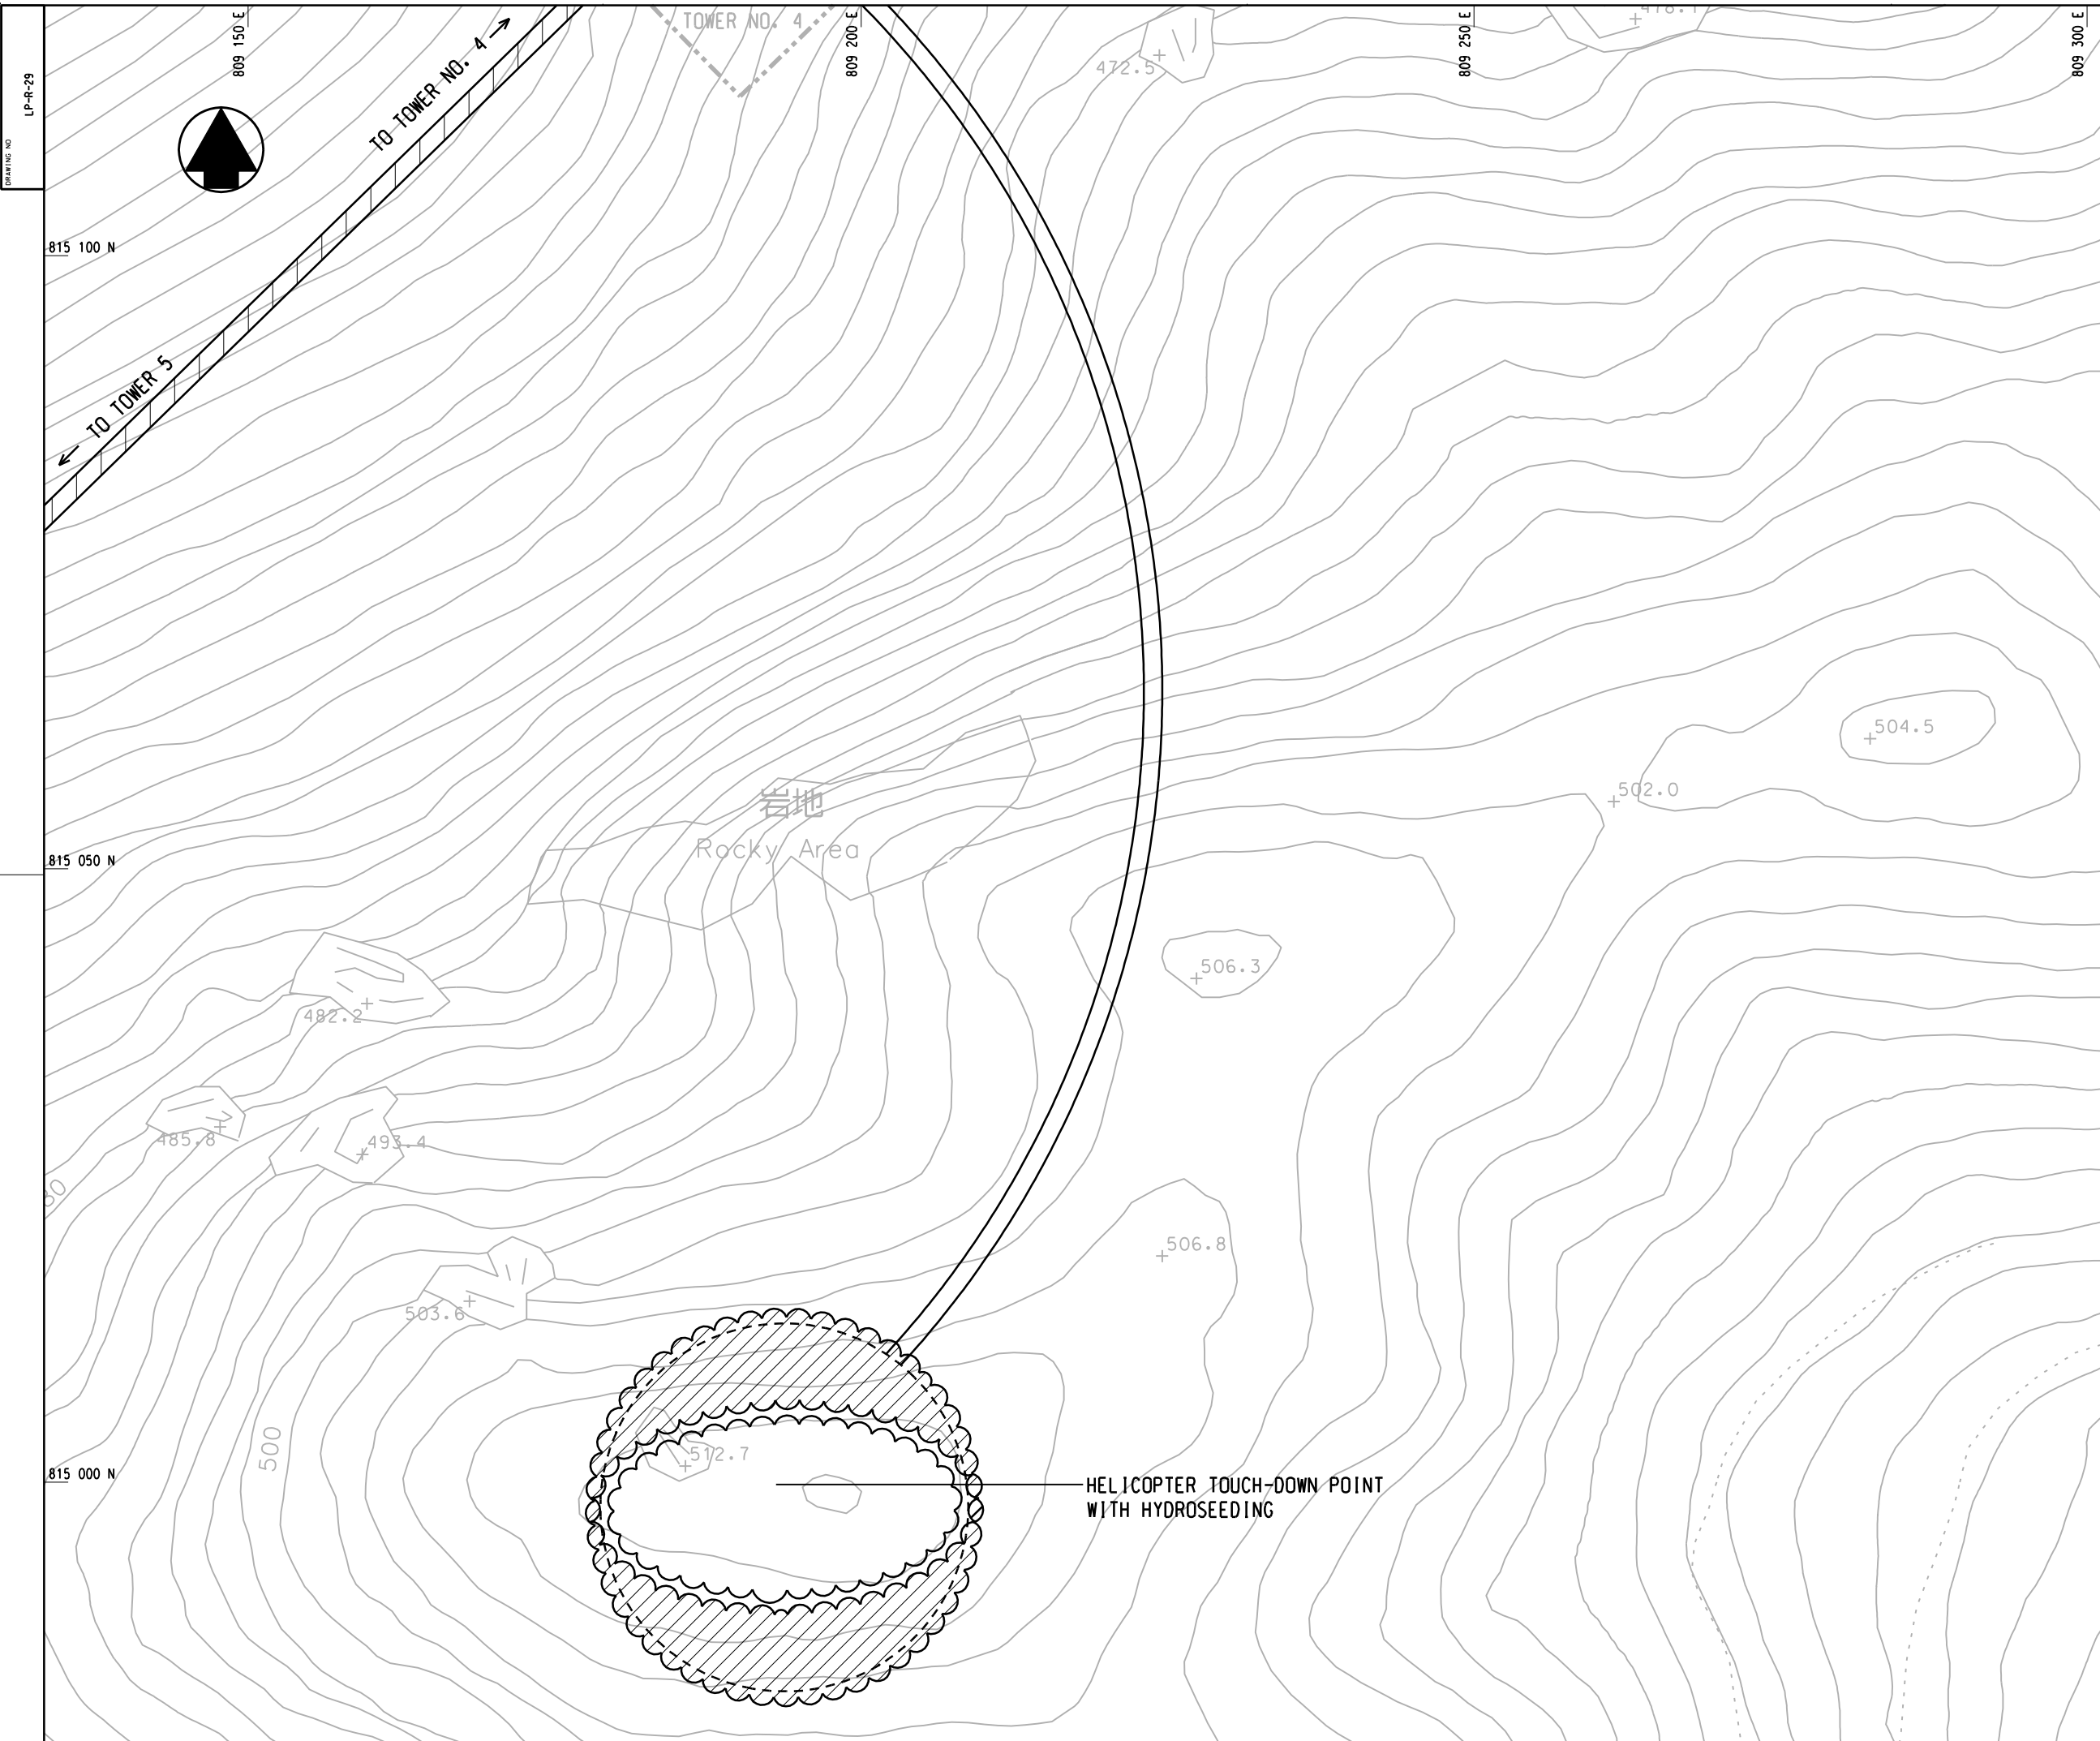

NO. OF SHEET SHOWN, VERIFY AS INDICATED ON SITE
 © 2005 HONG KONG CONSTRUCTION SERVICES
 CONSULTING ENGINEERS LIMITED
 ALL RIGHTS RESERVED. NO PART OF THIS DOCUMENT IS TO BE REPRODUCED OR TRANSMITTED IN ANY FORM OR BY ANY MEANS, ELECTRONIC OR MECHANICAL, WITHOUT THE WRITTEN PERMISSION OF THE CONSULTING ENGINEERS LIMITED.

- LEGENDS:**
- WORKS SITE
 - NEW TREE PLANTING
 - RETAINED TREE
 - TRANSPLANTED TREE
 - PLANTING AREA
 - RETAINED WOODLAND

NOTES:

ALL AREAS TO BE HYDROSEED PRIOR TO PLANTING WORKS TO ASSIST EROSION CONTROL. HYDROSEED MIX TO CONSIST OF CYNODON DACTYLON + PASPALUM NOTATUM. (THERE IS TO BE NO GREEN DYE OR TERRAM COVER TO BE USED WITHIN COUNTRY PARK TO AVOID ANY POLLUTANTS TO PARK)

PLANT SCHEDULE:

Woodland mix 'A'

Shrubs	Botanical Name	Size(mm)Ht.
Ga	Gordonia axillaris	1000mm
Scs	Schima Superba	1000mm
Rt	Rhodomyrtus tomentosa	1000mm
Ms	Melastoma sanguineum	1000mm
Bf	Baeckea frutescens	1000mm
Dp	Dicranopteris pedata	1000mm

Woodland mix 'B'

Sd	Sapium discolor	1000mm
Rc	Rhus chinensis	1000mm
Ls	Litsea rotundifolia	1000mm
Mch	Machilus chinensis	1000mm

Woodland mix 'C'

Mc	Melastoma candidum	1000mm
Mpan	Microcos paniculata	1000mm
Ri	Rhaphiolepis indica	1000mm
Ss	Sapium sebiferum	1000mm
Sh	Schefflera heptaphylla	1000mm
Mp	Mallotus paniculatus	1000mm

REVISION	DESCRIPTION	BY	DATE	APPROVED

前田建設工業株式会社
 Maeda Corporation
 1001-5 NEW EAST OCEAN CENTRE
 9 SCIENCE MUSEUM ROAD
 T.S.T. EAST, KOWLOON, HONG KONG
 TEL.: 2589 6287 FAX.: 2724 4084


地鐵公司
 MTR Corporation
 MTR TOWER
 TELFORD PLAZA - KOWLOON BAY
 HONG KONG
 TEL.: 2983 2111 FAX.: 2798 9822

PROJECT 東涌吊車
 TUNG CHUNG CABLE CAR

ORIGINATOR 凱達柏濟有限公司
 Aedas Limited

TITLE
 HELICOPTER TOUCH-DOWN POINT
 NEAR TOWER 4
 LANDSCAPE PLANTING PLAN

SCALE	1 : 250 @ A1	CAD REF	AS BUILT
DATE	FEB. 2005	AS BUILT DWG NO	
DRAWN	WL	DESIGNED JW	DRAWING NO LP-R-29
CHECKED	JW	APPROVED SF	REV B

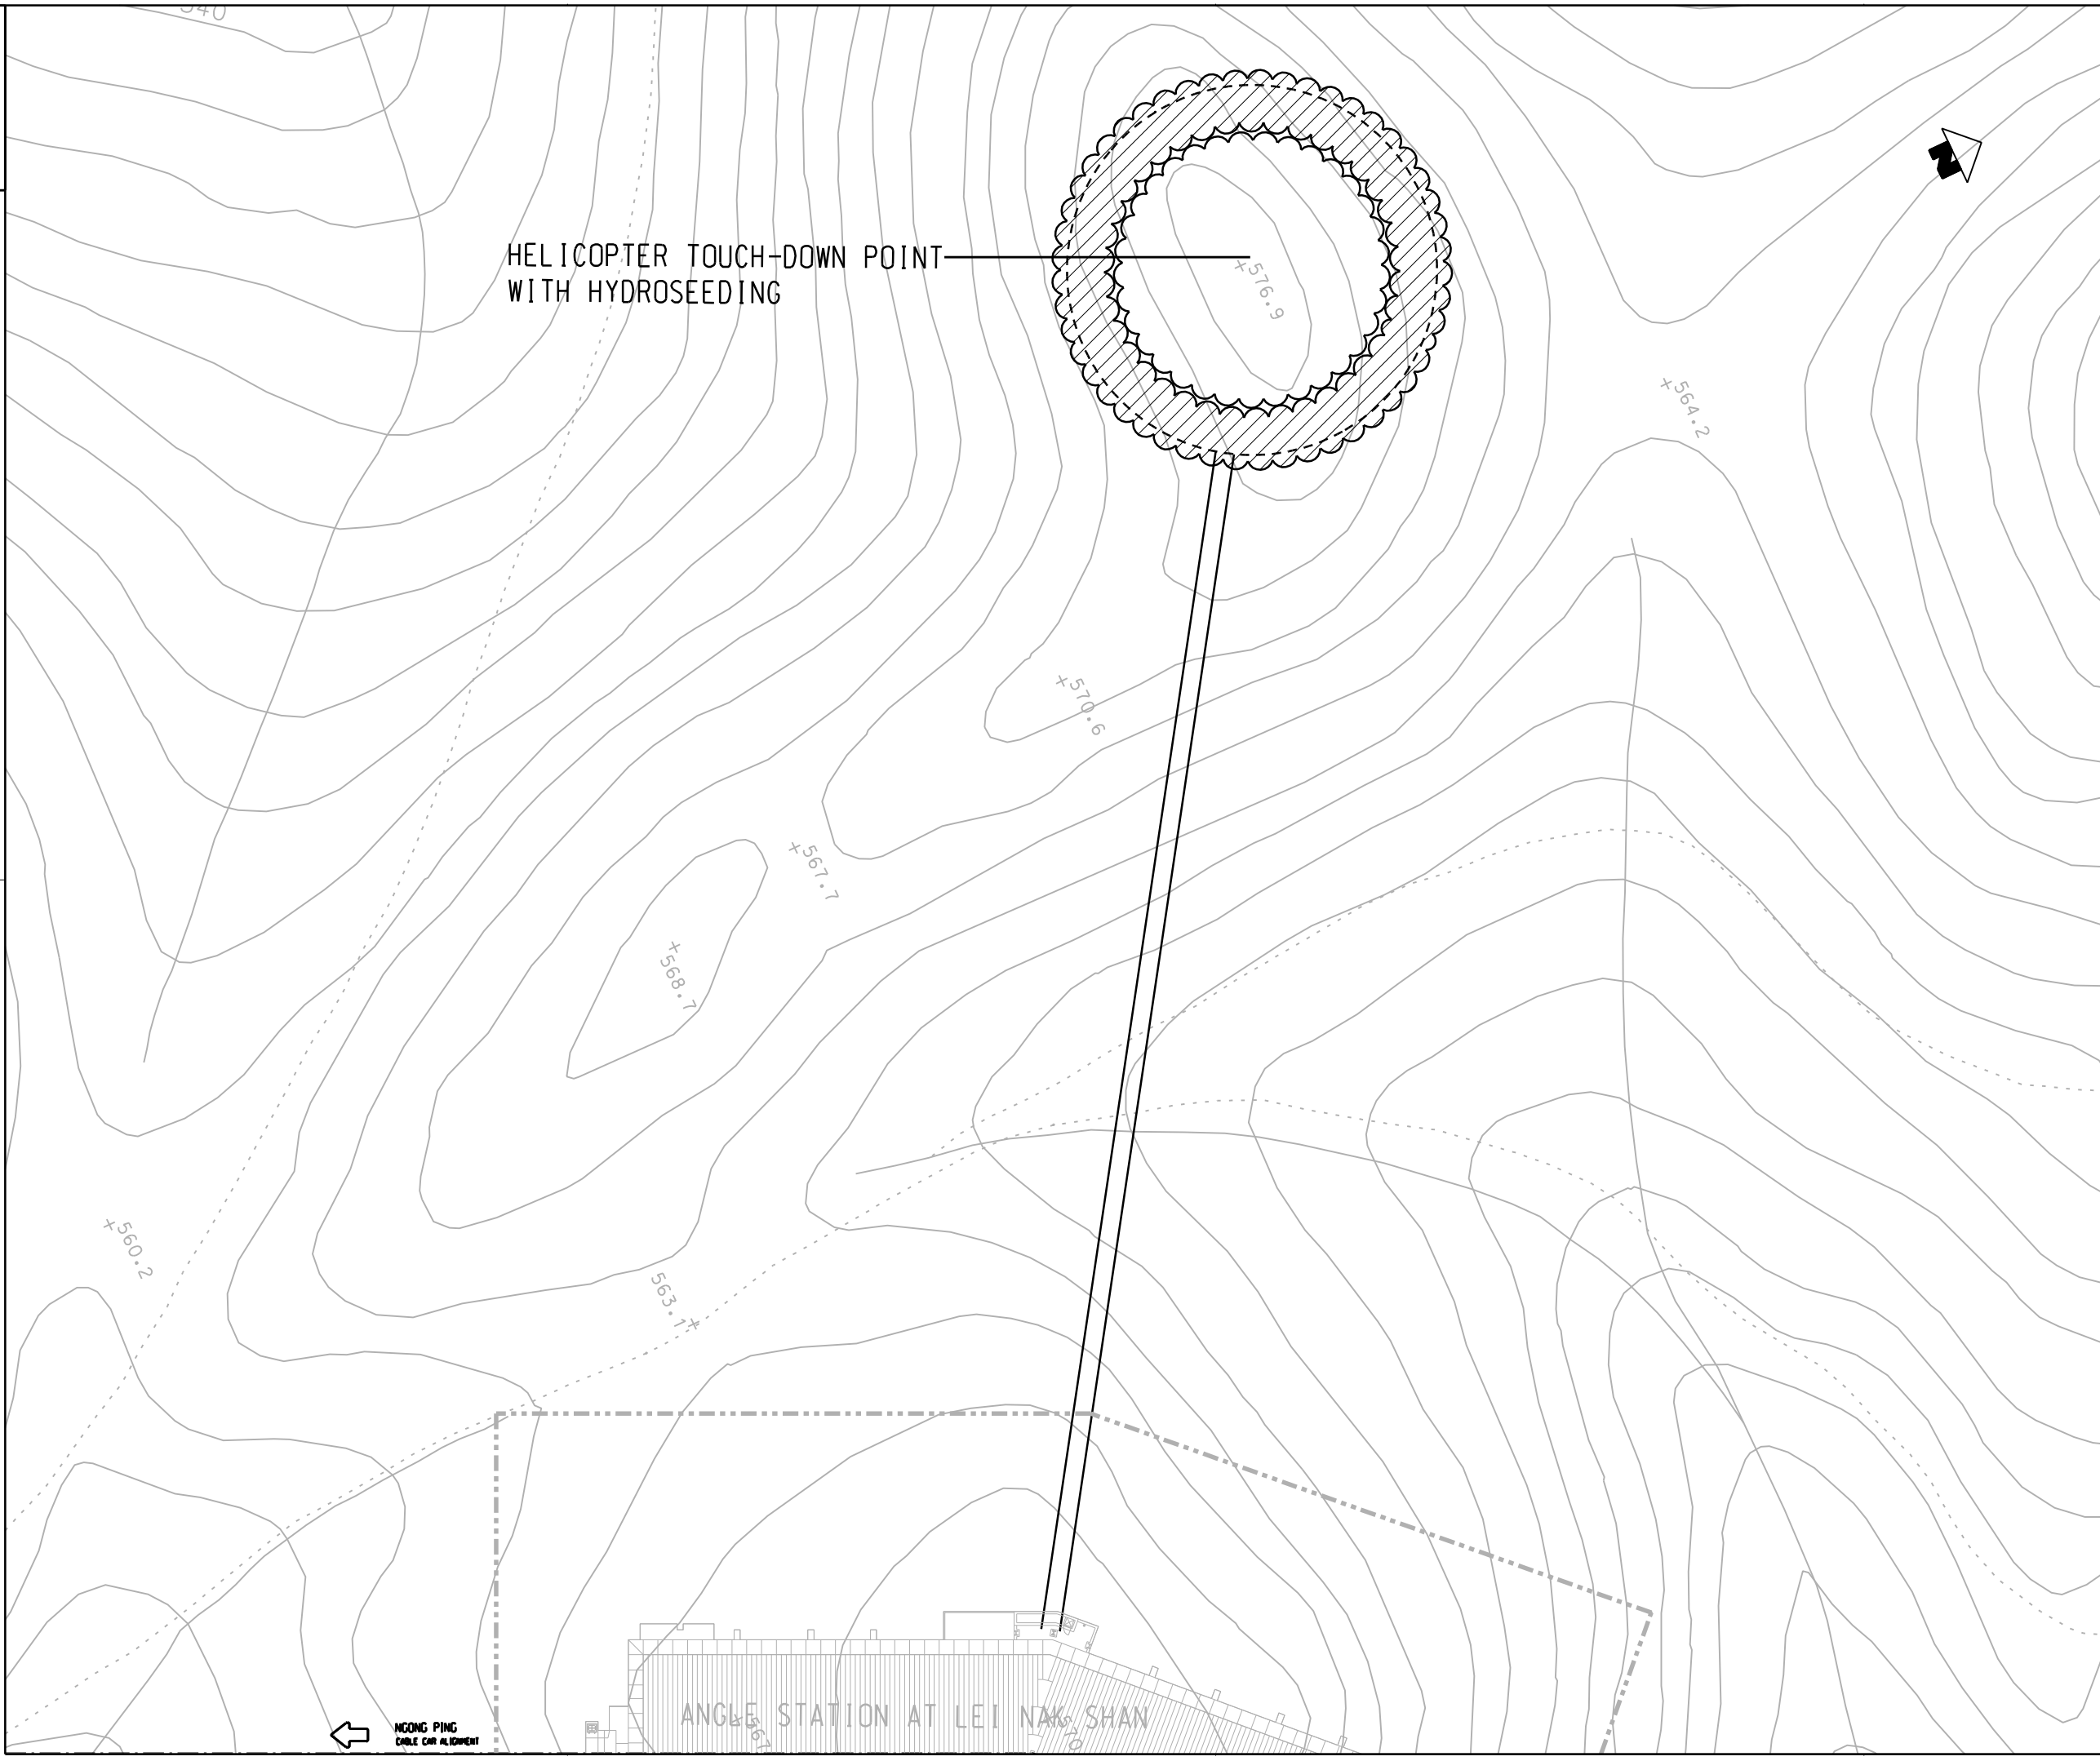

NO NEW SCALE DRAWINGS, VERIFY ALL DIMENSIONS ON SITE
 © 2005 HONG KONG MAEDA CORPORATION LTD
 PREPARED ON BEHALF OF THE CLIENT BY THE HONG KONG MAEDA CORPORATION
 ALL RIGHTS RESERVED. NO PART OF THIS DRAWING IS TO BE REPRODUCED OR TRANSMITTED IN ANY FORM OR BY ANY MEANS, ELECTRONIC OR MECHANICAL, WITHOUT THE WRITTEN PERMISSION OF THE HONG KONG MAEDA CORPORATION.

- LEGENDS:**
- WORKS SITE
 - NEW TREE PLANTING
 - ⊗ RETAINED TREE
 - ⊗ TRANSPLANTED TREE
 - ☁ PLANTING AREA
 - ▨ RETAINED WOODLAND

NOTES:

ALL AREAS TO BE HYDROSEEDING PRIOR TO PLANTING WORKS TO ASSIST EROSION CONTROL. HYDROSEED MIX TO CONSIST OF CYNODON DACTYLON + PASPALUM NOTATUM. (THERE IS TO BE NO GREEN DYE OR TERRAM COVER TO BE USED WITHIN COUNTRY PARK TO AVOID ANY POLLUTANTS TO PARK)

PLANT SCHEDULE:

Woodland mix 'A'

Shrubs	Botanical Name	Size(mm)Ht.
Ga	Gordonia axillaris	1000mm
Scs	Schima Superba	1000mm
Rt	Rhodomyrtus tomentosa	1000mm
Ms	Melastoma sanguineum	1000mm
Bf	Baeckea frutescens	1000mm
Dp	Dicranopteris pedata	1000mm

Woodland mix 'B'

Sd	Sapium discolor	1000mm
Rc	Rhus chinensis	1000mm
Ls	Litsea rotundifolia	1000mm
Mch	Machilus chinensis	1000mm

Woodland mix 'C'

Mc	Melastoma candidum	1000mm
Mpan	Microcos paniculata	1000mm
Ri	Rhaphiolepis indica	1000mm
Ss	Sapium sebiferum	1000mm
Sh	Schefflera heptaphylla	1000mm
Mp	Mallotus paniculatus	1000mm

REVISION	DESCRIPTION	BY	DATE	APPROVED

前田建設工業株式会社
 Maeda Corporation
 1001-5 NEW EAST OCEAN CENTRE
 9 SCIENCE MUSEUM ROAD
 T.S.T. EAST, KOWLOON, HONG KONG
 TEL.: 2589 6287 FAX: 2724 4084

地鐵公司
 MTR Corporation
 MTR TOWER
 TELFORD PLAZA - KOWLOON BAY
 HONG KONG
 TEL.: 2988 2111 FAX: 2798 9822

PROJECT
 東涌吊車
 TUNG CHUNG CABLE CAR


ORIGINATOR
 凱達柏濤有限公司
 Aedas Limited

TITLE
 HELICOPTER TOUCH-DOWN POINT AT
 LEI LAK SHAN
 LANDSCAPE PLANTING PLAN

SCALE	1 : 250 @ A1	CAD REF	AS BUILT APPROVED
DATE	APR. 2005	AS BUILT DWG NO	
DRAWN	WL	DESIGNED	JW
CHECKED	JW	APPROVED	SF
DRAWING NO	LP-R-30	REV	B

NDONG PING
 CABLE CAR ALIGNMENT

ANGEE STATION AT LEI NAK SHAN

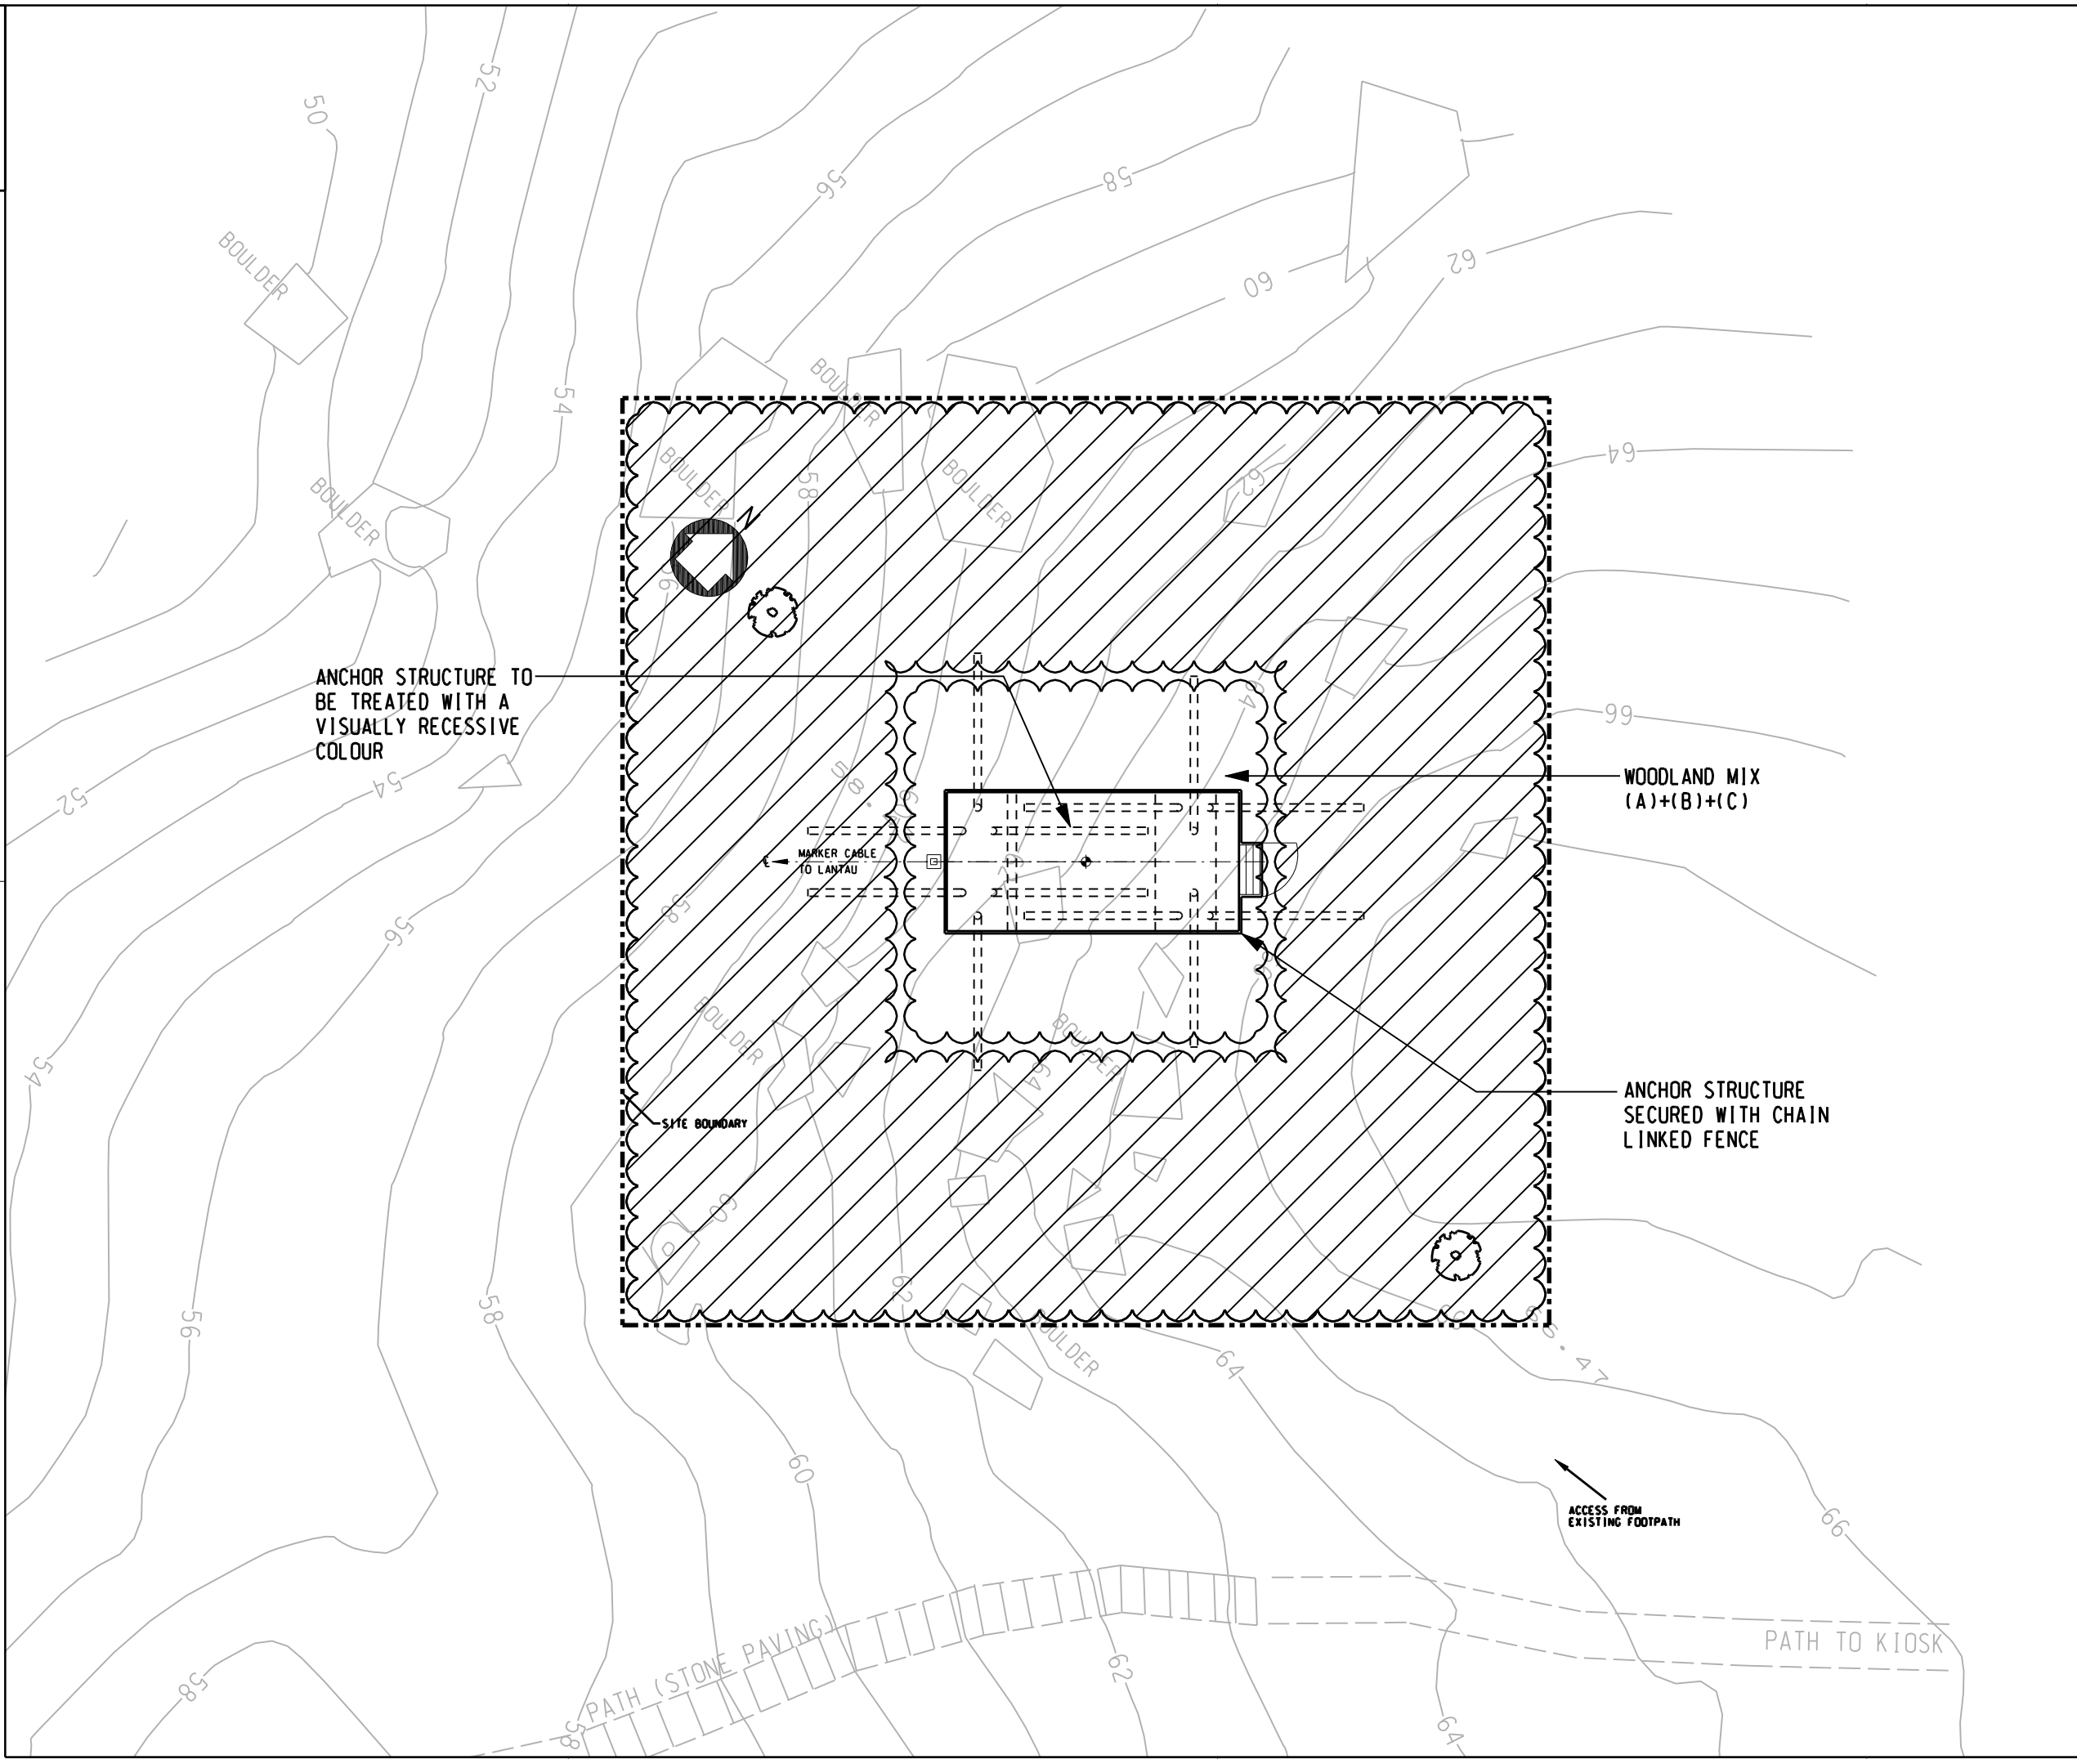

NO NET SCALE DIMENSIONS, VERIFY ALL DIMENSIONS ON SITE
 © 2005 HONGKONG AIRPORT AUTHORITY
 PREPARED ON BEHALF OF THE AIRPORT AUTHORITY BY THE ARCHITECTURAL CONSULTANTS
 OF THE AIRPORT AUTHORITY. ALL RIGHTS RESERVED. NO PART OF THIS DRAWING IS TO BE REPRODUCED OR TRANSMITTED IN ANY FORM OR BY ANY MEANS, ELECTRONIC OR MECHANICAL, WITHOUT THE WRITTEN PERMISSION OF THE ARCHITECTURAL CONSULTANTS.

- LEGENDS:**
- WORKS SITE
 - NEW TREE PLANTING
 - ⊙ RETAINED TREE
 - ⊙ TRANSPLANTED TREE
 - ☁ PLANTING AREA
 - ▨ RETAINED WOODLAND

NOTES:

ALL AREAS TO BE HYDROSEED PRIOR TO PLANTING WORKS TO ASSIST EROSION CONTROL. HYDROSEED MIX TO CONSIST OF CYNODON DACTYLON + PASPALUM NOTATUM. (THERE IS TO BE NO GREEN DYE OR TERRAM COVER TO BE USED WITHIN COUNTRY PARK TO AVOID ANY POLLUTANTS TO PARK)

PLANT SCHEDULE:

Woodland mix 'A'

Shrubs	Botanical Name	Size(mm)Ht.
Ga	Gordonia axillaris	1000mm
Scs	Schima Superba	1000mm
Rt	Rhodomyrtus tomentosa	1000mm
Ms	Melastoma sanguineum	1000mm
Bf	Baeckea frutescens	1000mm
Dp	Dicranopteris pedata	1000mm

Woodland mix 'B'

Shrubs	Botanical Name	Size(mm)Ht.
Sd	Sapium discolor	1000mm
Rc	Rhus chinensis	1000mm
Ls	Litsea rotundifolia	1000mm
Mch	Machilus chinensis	1000mm

Woodland mix 'C'

Shrubs	Botanical Name	Size(mm)Ht.
Mc	Melastoma candidum	1000mm
Mpan	Microcos paniculata	1000mm
Ri	Rhaphiolepis indica	1000mm
Ss	Sapium sebiferum	1000mm
Sh	Schefflera heptaphylla	1000mm
Mp	Mallotus paniculatus	1000mm

REVISION	DESCRIPTION	BY	DATE	APPROVED

前田建設工業株式会社
Maeda Corporation
 1001-5 NEW EAST OCEAN CENTRE
 9 SCIENCE MUSEUM ROAD
 T.S.T. EAST, KOWLOON, HONG KONG
 TEL : 2599 6287 FAX : 2724 4084

地鐵公司
MTR Corporation
 MTR TOWER
 TELFORD PLAZA - KOWLOON BAY
 HONG KONG
 TEL : 2988 2111 FAX : 2798 9822

東涌吊車
TUNG CHUNG CABLE CAR

凱達柏濤有限公司
Aedas Limited

TITLE

CABLE MARKER (b) AT
 AIRPORT ISLAND
 LANDSCAPE PLAN

SCALE	1:100	CAD REF	AS BUILT APPROVED
DATE	JUNE, 2005	AS BUILT DWG NO	
DRAWN	DESIGNED	DRAWING NO	
CHECKED	APPROVED	LP-T-04	REV A