# THE LYRIC THEATRE + P32 – ARTIST HOSTEL/ RESIDENCE

## LANDSCAPE MITIGATION PLAN

(Revision 04)

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Project							
Lyric Theatre in West Kowloon Cultural District							
P32 – Artist Hostel/ Residence							
Client	Consultant						
WKCDA	UAJV Consultancy						
Element							
Submission of Landscape Mitigation Plan							
Discipline							
LAN							

Revi	ew and Approval	<u> </u>					
04	26 Jul 2021	LWK	Plan D			Submission of Landscape Mitigation Plan	For review
03	28 May 2021	LWK	<u>Plan D</u>			Submission of Landscape Mitigation Plan	For review
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04	19 Jul 2021	LWK	<u>UAJV</u>			Submission of Landscape Mitigation Plan	For review
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#### **OBJECT AND PURPOSE OF THIS REPORT** 1.0

Pursuant to the Condition 2.5 of the Environmental Permit No. EP-453/2013/B (Condition 2.5 please refer to Table 1 of this report), the Permit Holder shall, no later than one month before the commencement of construction of the project, deposit with the Director of EPD four hard copies and one electronic copy of a Landscape Mitigation Plan to demonstrate the compliance of Landscape Mitigation Plan with Landscape and Visual Mitigation Measure as recommended in the Approved EIA Report (Register No.: AEIAR-178/2013). Part of the West Kowloon Cultural District (named "WKCD" hereafter) is within the project boundary, thus, this landscape mitigation plan report will only cover the area for the Lyric Theatre Area and P32-Artist Hostel/ Residence. (see Figure 1, Figure 2 and Figure 3) The landscape mitigation plan for other remaining areas will be provided separately by the West Kowloon Cultural District Authority (named "WKCDA" hereafter).

#### INSTRUCTION 2.0

#### 2.1. Project Background

2.1.1. The West Kowloon Cultural District Authority is invested by the Government of the Hong Kong Special Administrative Region to meet the long-term infrastructure needs of the arts and cultural sector, which is a vital part of any world-class city's economic and social fabric. WKCDA was established under the West Kowloon Cultural District Authority Ordinance ("WKCDA Ordinance"), Cap. 601, to develop the WKCD.

#### The WKCD include:

- Planning, design and construction of 17 core arts and cultural facilities (CACF) (comprising 15 performing arts venues, a cultural institution with museum function (M+) together with its off-site conservatory laboratory and storage facilities, and as exhibition centre), other arts and cultural facilities (OACF), Retail, Dining and Entertainment (RDE) facilities, transport facilities and 23 ha public open space (which collectively constitute the "Capital Projects");
- Planning of the WKCD and project management which include consultancies, technical studies and public (ii) consultations for the preparation of a development plan for the whole WKCD site, and project management during the planning and construction stage;
- (iii) Major repair and renovation of the facilities; and
- Collection, exhibition development, conservation laboratory equipment, and library setup for the M+.

CACF are tentatively planned to be commissioned in 2 Batches, The Lyric Theatre Area and P32-Artist Hostel/ Residence are two of the venues included in the Batch TWO CACF.

- UN Studio & AD+RG (UAJV) was appointed as the consultant for the Design and the Construction of the Proposed Lyric Theatre and P32 - Artist Hostel/ Residence for the West Kowloon Cultural District Authority.
- The Environmental Permit (EP) No EP-453/2013/B was granted to WKCDA for the construction and operation of the "Underpass Road and Austin Road Flyover Serving the West Kowloon Cultural District" based on the approved Environmental Impact Assessment (EIA) Report for the West Kowloon Cultural District (WKCD) (Register No. AEIAR-178/2013). The Underpass Road forms part of the infrastructure works for the WKCD development, and shall be implemented in phases. The Landscape Mitigation Plan for this submission will cover the area only for the Lyric Theatre Area and P32 - Artist Hostel/ Residence & work area within project boundary, while the landscape mitigation plan for the remaining area will be provided under the WKCD project.



### The Lyric Theatre & P32- Artist Hostel / Residence Consultancy JV - Submission of Landscape Mitigation Plan

#### LANDSCAPE DESIGN CONCEPT 3.0

#### 3.1. The Lyric Theatre Area

The WKCD site is bounded by Canton Road and Austin Road at the eastern and northern sides respectively. The project in this report takes approx. 27,850 m<sup>2</sup> as shown in Figure 1 and Figure3. Within the project boundary, there are Lyric Theatre Area (which including Lyric Theatre Complex, Artist Square, Austin Road West, Pocket Square and Promenade) and P32 -Artist Hostel/ Residence.

The Lyric Theatre Area is located in the south of Austin Road West driveway and in east of the new museum of visual culture, M+, as shown in Figure 1 and Figure 2. The north side of the Area will directly face the Austin Road West. The south of the Area faces the unique and spectacular views of Victoria Harbour and Hong Kong Island skyline. The east and west side of the Area will form pedestrian way connecting the Avenue to the waterfront promenade.

The Lyric Theatre Are will make use of the whole WKCD which involves the design, construction and commissioning of a new multi-story theatre with 2 levels of basement. Resident company facilities and RDE facilities will be included in the adjacent P32, to promote the vibrancy and diversity of functions and activities. The Area would occupy the primary frontage towards the Austin Road West. The Area also involves the design, construction and commission of the associated Common Basement and Public Infrastructure Works (PIW) interfacing with the Lyric Theatre.

The Site is on reclaimed land and various infrastructure and underground utilities are located within the Area, including: waterworks reserve; drainage outlet; access roads and utilities facilities; MTRCL's Airport Express Line (AEL) & Tung Chung Line (TCL) tunnel and associated ventilation buildings; temporary barging point Express Rail Link; underground sea water pumping station for Kowloon Government Office and the "Elements" shopping mall; cooling main for "Elements"; associated seawater intake and outlet culverts.

3.1.1. According to the Lyric Theatre Development Master Programme, the expected completion of Main Contract construction works to be in the 3rd quarter of 2023.



Figure 1 Project Location and Boundary

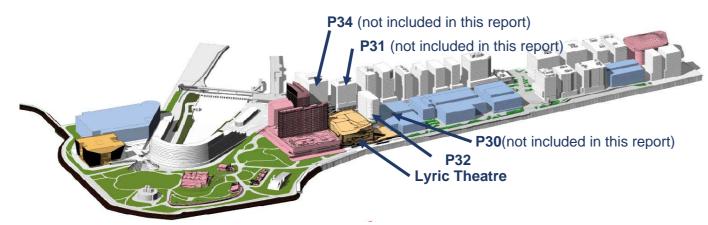


Figure 2 Project Location – 3D View

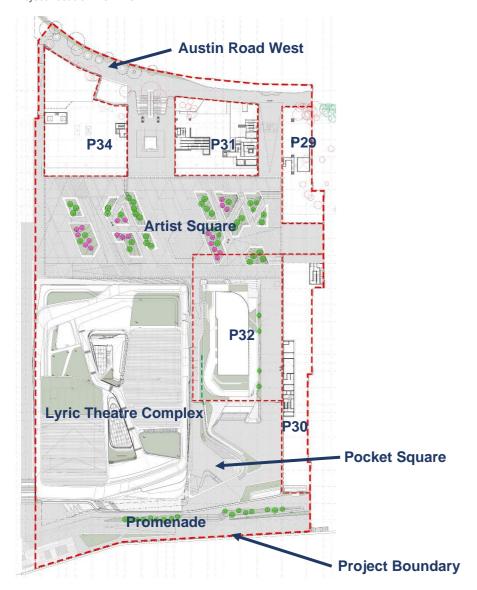


Figure 3 Project Boundary – Blow up (P34, P31, P29 and P30 not included in this report)



The Lyric Theatre & P32- Artist Hostel / Residence Consultancy JV

#### **Landscape Design Principles**

The landscape design for the Lyric Theatre aims to meet the following objectives:

- (i) Facilitate a relaxing environment for all public users;
- (ii) Manage security in terms of regulating access and increasing visibility in the design;
- Enhance accessibility for all users (especially wheel-chair users) and staff to create a barrier-free (iii) environment;
- Take into account the safety of public users, particularly in areas of different (iv)
- (v) Reduce maintenance requirements to a practical minimum without compromising the function or aesthetics of the design.;
- Choose hard landscape materials that promote sustainability, recyclability and durability; (vi)
- Provide planting that is vibrant and diverse in types, while endeavouring to be sustainable and not (vii) unduly maintenance-intensive;
- Maximise greening opportunities that provide visual masks to built structures and to blend them into (viii) the surroundings:
- (ix) Provide ample greening to improve thermal comfort within the site;
- Practice tree preservation in accordance with regulations and sustainability principles. (x)

#### **Landscape Design Concept** 3.1.3.

Corresponding with the aim of the WKCD as the cultural centre of Hong Kong, the Lyric Theatre landscape shall extend and enhance the expression of both identity and public services. Therefore, the concept of landscape design encompasses feature that encourage public recreation, socialisation, and interaction. Natural elements such as stones, planting, sunlight and fresh air shall be incorporated to maximise the sense of comfort and leisure. Trees and shrubs of diversity will be placed at focal points to enhance visual effects of the landscape. The landscape design for the Lyric Theatre will strive to create landscape areas that respond to the needs of public users. The landscape shall aim to achieve the following, especially in the areas dedicated to the uses of public users:

- Opportunities for movement and exercise;
- Setting which encourage people to gather and experience social support; (ii)
- (iii) Promote the sense of nature; and
- Visibility, Accessibility, Familiarity, Quiet and Comfort. (iv)

#### 3.2. The Artist Square

#### 3.2.1. **Design Intent**

The Artist Square is a unique part of the Lyric Theatre Area, which offer a direct connection to public open space and provide a public entrance plaza to the Area. The WKCD is a collection of exceptional cultural and commercial buildings, some very sculptural, some very modest in architecture. In between all these buildings the function of urban space design is to create a clear and unifying structure with several special highlight at the plazas, which are also included in the Artist Square function.

#### **Design Concept** 3.2.2.

As a canvas that unifies M+ and Lyric Theatre Complex (LTC), the Artist Square sits at the heart of the cultural district. Due to its unique qualities, the square will undoubtedly become an emblem for the district. The coming together of forces, people and elements sets a dynamic tone and vitality to the square. The design embodies the energy and artistic spirit of the district.

#### 3.3. P32- Artist Hostel/ Residence

#### 3.3.1. **Landscape Design Concept**

The Concept Design of the P32- Artist Hostel/ Residence grounds itself in several key points that react to various site, contextual, programmatic and functional parameters.

- (i) The landscape flows though the building connecting the Artist Square and Pocket Square;
- (ii) P32- Artist Hostel/ Residence will house artist from Lyric Theatre Complex, this drives the seamless connection through Lyric Theatre Complex central spine to P32 Artist residence both though the bridge and also though pocket square and artist square respectively;
- The project concept allows maximum flexibility for future operation, so that its both investor friendly and also (iii) responsive to its unique position among iconic and cultural projects;
- The tower acts as a floating prism that allows for maximum flexibility for room layouts and sizes; (iv)
- The shifting landscape podium allows the building respond to the surrounding context and also retains its iconic (v) characteristics along the precious waterfront;
- The building allows maximum interaction with the Artist Square and Pocket Square by allowing amphitheatre style (vi) staircases. This also enhances the character of the square by allowing public performances.
- Transparency of the podium has been created to maximize the view of the podium and also to create the lightness (vii) for the building:
- The sweeping soffits carry the landscape up the podium creating a strong architectural relationship with landscape below.

#### 4.0 LANDSCAPE MITIGATION PLAN


To integrate the aim of the West Kowloon Cultural District (WKCD) the cultural centre of Hong Kong, landscape design of Lyric Theatre Area and P32- Artist Hostel/ Residence shall react to the site context and enhance the expression of both identity and public service. The concept of landscape design encompasses feature that encourage public recreation, socialisation, and interaction. Natural elements such as stones, planting, sunlight and fresh air shall be incorporated to maximise the sense of comfort and leisure. Trees and shrubs of diversity will be placed at focal points to enhance visual effects of the landscape.

#### 4.1. Landscape and Visual Mitigation Measures in Approved EIA Report

Further to approved EIA Report (Register No.: AEIAR-178/2013), it has recommended landscape & visual mitigation measures in approved EIA Report as shown in Table 2 & Appendix B - Landscape Mitigation Plan. Proposed Landscape and Visual Mitigation measures comply with recommendation in approved EIA report, details of proposed mitigation measures is shown in the section 4.2 to section 4.4.

#### 4.2. Tree Work Recommendation in Approved Tree Removal Application

According to approved Tree Removal Application under DLO letter (ref.: (13) in DLOKW KX 2844) dated 28 May 2015, there are 19 nos. of retained trees (in Leucaena leucocephala) located away from the construction site area which will be retained in situ without affection; no trees to be transplanted and 42 nos. of trees unavoidably required to be felled. To compensate for the loss of trees, 85 nos. of new compensatory trees (in 100mm DBH) to be planted in Artist Square, Waterfront Park Promenade and WKCD park/ public areas within the project boundary & WKCD area, refers to Appendix C - Compensatory Tree Planting Plan.

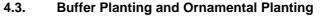

#### 4.3.1. **Planting Design Concept of Lyric Theatre Area**

Tall and structural form of trees are proposed near the super structure of Lyric Theatre Complex and soften the architectural and engineering structure facilities, refer to Appendix D - Planting Plans.

Tree planting includes exotic species such as Taxodium species, Terminalia species and native species such as Sapium species. They are planted to provide shade and amenities for the users at the open area and along the water promenade. Salt tolerant turf Zoysia japonica will be incorporated to maximise greening opportunity.

The tightly planted tree clusters along the waterfront promenade control and enhance view- sheds from the Lyric Theatre Complex to waterfront. The groups are formed of Terminalia evergreen trees which provide shade & screen winds and also unifies the design of the adjacent promenade. These trees could reach to a potential height of 10-15m, and it has erect stem and conspicuously layered branches with smooth leaves with wavy margins that are bright green in youth, held in terminal rosettes.

Details of planting design refer to Appendix D- Planting Plan & Schedule of Lyric Theatre.

#### 4.3.2. Planting Design Concept of P32- Artist Hostel/ Residence

Selected native feature tree, in species of Liquidambar formosana, with beautiful form of lateral spread branching layers to be planted along the stripped planter to highlight the entrance. There is brilliant pendant in species of Muhlenbergia filipes to create visual interest along the entrance path.

Drought and wind tolerant ornamental plantings is selected in podium level, a variety mix of different types, color and foliage of plants create an attractive visual interest of natural planting environment and recreation open space for the public. Proposed planting species are Abelia Chinensis R. Br, Acorus gramieus, Liriope spicata, Pennisetum alopecuroides in consideration of long term sustainability with low maintenance.

Details of planting design refer to Appendix E - Planting Plan & Schedule of P32- Artist Hostel/ Residence Area.

#### 4.4. Landscape, Architectural and Chromatic Treatment of the Hard Architectural and Engineering Structures and Facilities

#### 4.4.1. Seating and Greenery

Seating area is incorporated in planter to avoid obstruction of the passageway of barrier free/ universal design, which provide for public relaxation, employment and improvement of quality of environment in function and aesthetic design.

Planter design maximize greening opportunities & blend with building design structures; adequate outdoor seating area are provided in different layers of balconies, from ground floor to roof floor, extending from the building. Green roofs and recreational open space provided with seating allow flexibility for public outdoor activities and events.



#### 4.4.2. Visibility & Sustainability

At ground level, landscape design flows through the building of Lyric Theatre. P32- Hostel/ Residence grounds connecting to Artist Square and Pocket Square and Promenade. Paving pattern and planter layout are designed to match the dynamic form of building and site context, creates a subtle and harmonized landscape environment with a sense of hospitality and identity.

At podium level, various extending shifting landscape podiums/ balconies allows the building respond to surrounding context and maximise the transparency view of the podium for visibility. It also enhances thermal comfort of natural ventilation and sunlight penetration throughout the outdoor recreational open space, so as create a cohesive relationship with iconic building and character along precious waterfront landscape area.

#### 4.4.3. **Material Section/ Chromatic Treatment**

Hard landscape materials considered to promote sustainability, recyclability and durability. Durable and ecological natural stone pavement blocks are proposed to match adjacent surrounding site environment; Tactile pavement in natural stone with stainless steel studs and accessories to comply with barrier free requirements; Granite stone of planters are proposed to match surrounding building design and site environment; Stainless steel handrails to steps are designed as per statutory requirements with inlaid braille markings

Planting species are considered sustainable and require low maintenance. Species with substantial leaf fail or problematic wind-borne seed or pollen will be avoided. Adequate soil depth, irrigation and drainage provision are proposed for proper maintenance operation, details refer to Appendix F - Post Planting Care Plan.

Details of landscape, architectural and chromatic treatment of the hard architectural and engineering structures and facilities refer to Appendix G. Detail of planting design refers to Appendix D & E.



#### CONCLUSION 5.0

### Table 1 Required Information of Condition 2.5 in Environmental Permit No. EP-453/2013/B

Required	Information	Section in LMP Submission to include the information
(i)	summary of the landscape mitigation proposal and demonstration of the proposal in conforming to the information and recommendations in	Please refer to Table 2 in Section 5.0
	the EIA Report (Register No.: AEIAR-178/2013);	
(ii)	locations of the landscape and visual mitigation measures as recommended in the EIA Report (Register No.: AEIAR-178/2013);	Please refer to Appendix B – Landscape Mitigation Plan
(iii)	locations, size, number and plant species of trees to be retained;	Please refer to approved Tree Removal Application under DLO letter (ref.: (13) in DLOKW KX 2844) dated 28 May 2015 in Appendix C
(iv)	locations, size, number and plant species of trees to be transplanted and their final transplanting locations;	No tree to be transplanted, refer to the Tree Removal Application stated in above row
(v)	locations, size, number and plant species of compensatory planting, buffer planting and ornamental planting; and	Please refer to Appendix D – Planting Plan & Planting Schedule of Lyric Theatre Area, and Appendix E – Planting Plan & Planting Schedule of P32- Artist Hostel
(vi)	landscape, architectural and chromatic treatment of the hard architectural and engineering structures and facilities.	Please refer to Section 4.4.

Table 2 Landscape and Visual Mitigation Measures in Approved EIA Report

Propo	sed Mitiga	ation Measures pursuant to the Condition 2.5 of the EP-453	/2013/B							
Lands	cape and	Visual Impact (Construction & Operation)								
EIA Ref.	EM&A Ref.	Environmental Protection Measures	Location/ Duration of measures/ Timing of completion of measures	Implementation Agents	Des	Con	Op	Dec Dec	Relevant Legislation & Guideline	Mitigation Measures Adopted in LMP Submission
Lands	cape Imp	act (Construction)	•							
CM1	CM1	Trees to be retained in situ on site as far as possible. Should tree removal be unavoidable due to construction impacts, trees will be transplanted or felled with reference to the stated criteria in the Tree Removal Applications to be submitted to relevant government departments for approval in accordance to ETWB TCW No. 29/2004 and 10/2013.	WKCD construction site/ Throughout construction stage/ Until completion of all construction activities	Contractor appointed by WKCDA	У	у			ETWB TCW 29/2004 & 3/2006 (ETWB TCW 29/2004 superseded by DEVB TC 5/2020 & ETWB TCW 3/2006 superseded by DEVB TC 4/2020)	Refers to Landscape Mitigation Plan in Appendix B; & Approved TPRA Submission in Appendix C.
CM2	CM2	Compensatory tree planting shall be incorporated to the proposed project and maximize the new tree, shrubs and other vegetation planting to compensate tree felled and vegetation removed. Also, implementation of compensatory planting should be of a ratio not less than 1:1 terms of quality and quantity within the site.	WKCD Park and public areas/ After completion of site formation/ Prior to operation stage	Contractor appointed by WKCDA	у	У			ETWB TCW No. 3/2006 (superseded by DEVB TC 4/2020)	Refers to Landscape Mitigation Plan in Appendix B; Compensatory Tree Planting Plan of Lyric Theatre_Dwg. no. CP-01 to CP-05 in Appendix D; & Landscape Planting Plan of P32- Artist Hostel _ Dwg. Title: Plan L000-P32 Landscape Planting Plan in Appendix E.
СМЗ	CM3	Buffer trees for screening purposes to soften the hard architectural and engineering structures and facilities.	Alongside superstructures within WKCD/ After completion of superstructure construction/ Prior to operation stage	Contractor appointed by WKCDA	у	У			EIAO-TM	Refers to Landscape Mitigation Plan in Appendix B; Compensatory Tree Planting Plan of Lyric Theatre_ Dwg. no. CP-01 in Appendix D; & Landscape Planting Plan of P32- Artist Hostel. Dwg Title: Plan L000-P32 Landscape Planting Plan in Appendix E.
CM4	CM4	Softscape treatments such as vertical green wall panel/ planting of climbing and/or weeping plants, etc, to maximize the green coverage and soften the hard architectural and engineering structures and facilities.	Alongside superstructures within WKCD/ After completion of road and street construction/ Prior to operation stage	Detailed Design Consultant/ Contractor appointed by WKCDA	у	У			EIAO-TM	Refers to Landscape Mitigation Plan in Appendix B; Landscape Planting Plan of P32- Artist Hostel _ Dwg. no: 3A32X-LWK-LAN-DWG-1020-P00-L000-WS3-XD & Planting Schedule in Appendix E.
CM5	CM5	Roof greening by means of intensive and extensive green roof to maximize the green coverage and improve aesthetic appeal and visual quality of the building/ structure.	WKCD structures/ After completion of superstructure construction/ Prior to operation stage	Detailed Design Consultant/ Contractor appointed by WKCDA	у	у			EIAO-TM	Refers to Landscape Mitigation Plan in Appendix B; Landscape Planting Plan of Lyric Theatre_ Dwg. no. 3A35X-LWK-LAN-DWG-1502-P00-L005-WS4-01 to 3A35X-LWK-LAN-DWG-1504-P00-L005-WS4-01 in Appendix D; & Landscape Planting Plan of P32- Artist Hostel _ Dwg. no: Plan L002, L003, L004, L006 L018-P32 Landscape Planting Plan & Planting Schedule in Appendix E.
CM6	CM6	Sensitive streetscape design should be incorporated along all new roads and streets.	Alongside roads and streets within WKCD/ After completion of structure construction/ Prior to operation stage	Alongside roads and streets within WKCD/ After completion of structure construction/ Prior to operation stage	у	у			EIAO-TM	Refers to Landscape Mitigation Plan in Appendix B; & Landscape, Architectural and Chromatic Treatment of the Hard Architectural and Engineering Structures and Facilities. In Appendix G.
CM7	CM7	Structure, ornamental planting shall be provided along amenity strips to enhance the landscape quality.	Alongside superstructures within WKCD/ After completion of superstructure construction/ Prior to operation stage	Contractor appointed by WKCDA	у	У			EIAO-TM	Refers to Landscape Mitigation Plan in Appendix B; Landscape Planting Plan of Lyric Theatre_ Dwg. no.3A35X-LWK-LAN-DWG-1500-P00-L00L-WS4-01 in Appendix D; Landscape Planting Plan of P32- Artist Hostel _ Dwg. no: 3A32X-LWK-LAN-DWG-1020-P00-L000-WS3 & Planting Schedule in Appendix E.
CM8	CM8	Landscape design shall be incorporated to architectural and engineering structures in order to provide aesthetically pleasing designs.	WKCD structures/ After completion of structure construction/ Prior to operation stage	Detailed Design Consultant/ Contractor appointed by WKCDA	у	у			EIAO-TM	Refers to Landscape Mitigation Plan in Appendix B; & Landscape, Architectural and Chromatic Treatment of the Hard Architectural and Engineering Structures and Facilities. In Appendix G.
CM9	CM9	Minimize the structure of marine facilities to be built on the seabed and foreshore in order to minimize the affected extent to the waterbody.	-	-					EIAO-TM	There is no marine facilities in south promenade within the site boundary.



EIA	EM&A	Environmental Protection Measures	rotection Measures Location/ Duration of Implementation Agents Implementation St		plementation Stage Relevant			Relevant	Mitigation Measures Adopted in LMP Submission	
Ref.	Ref.	Environmental Protestion measures	measures/ Timing of completion of measures	Implementation Agents	Des		Ор	Dec	Legislation & Guideline	Willigation Weasares Adopted in Livii Cabinission
Visual	Impact (C	onstruction)			•				•	
MCP1	MCP1	Use of decorative screen hoarding/ boards.	WKCD construction site/ Throughout construction stage/ Prior to operation stage	Contractor appointed by WKCDA		у			EIAO-TM	Implemented by contractor
MCP2	MCP2	Early introduction of landscape treatments.	WKCD construction site/ Towards the end of construction stage/ Prior to operation stage	Contractor appointed by WKCDA		у			EIAO-TM	Implemented by contractor
MCP3	MCP3	Adoption of light colour for the temporary ventilation shafts for the basement during the transition period.	WKCD basement construction site/ After completion of ventilation shaft superstructure/ Prior to operation stage	Design Architect/ Contractor appointed by WKCDA	у	у			EIAO-TM	Light concrete color will be adopted
MCP4	MCP4	Control of night time lighting	WKCD construction site/ During night time/ Throughout construction stage	Contractor appointed by WKCDA		у			EIAO-TM	Implemented by contractor
MCP5	MCP5	Use of greenery such as grass cover for the temporary open areas will help achieve the visual balance and soften the hard edges of the structures.	-	-					EIAO-TM	The greenery such as grass cover is not applicable in this site due to the limited space
Landso	rane Imna	ct (Operation)								
OM1	OM1	Provide proper planting maintenance on the new planting areas to enhance the aesthetic design degree.	WKCD open areas/ Throughout operation phase/ As-needed basis	Private Developer (for land sale lots); LCSD (for roadside planting); WKCDA (for all other WKCD areas)			у		EIAO-TM	Refers to Post Planting Care Plan in Appendix F.
OM2	OM2	Provision of open space in various forms and at different levels on or above ground, including park, waterfront promenade, piazzas and terrace garden and associated green connections for public enjoyment.	WKCD open areas/ Throughout operation phase/ As-needed basis	Private Developer (for land sale lots); LCSD (for roadside planting); WKCDA (for all other WKCD areas)	у		у		EIAO-TM	Refers to Landscape Mitigation Plan in Appendix B; & Landscape, Architectural and Chromatic Treatment of the Hard Architectural and Engineering Structures and Facilities. In Appendix G.
Viewel	lmmast (O	n anation)								
MOP1	Impact (O MOP1	Undulating berms and the trees planted in the surroundings	I -		1		1		EIAO-TM	WHC and MTR ventilation buildings are out of the site boundary.
WiGi i	WIOT 1	of the existing WHC and MTR ventilation buildings.							EI/(O TW	Will all a Will voluntation bandings are sat of the site boardary.
MOP2	MOP2	Clusters of shade planting and appropriate landscaping are designed to provide a relaxing waterfront environment, soften the water edge and helps mitigate the visual impacts associated with the existing WHC and MTR ventilation buildings.	WKCD waterfront/ During design stage/ Throughout operation phase	Contractor appointed by WKCDA	у		у		EIAO-TM	Refers to Landscape Mitigation Plan in Appendix B
MOP3	MOP3	The unique designed roof top gardens and green roof are considered as mitigation measures to lessen the visual impacts and provide new visual resources when viewed from the VSRs at higher levels.	WKCD open areas/ During design stage/ Throughout operation phase	Private Developer (for land sale lots); WKCDA (for WKCD facilities)	у		у		EIAO-TM	Refers to Landscape Mitigation Plan in Appendix B; Landscape Planting Plan of Lyric Theatre in Appendix D; & Landscape Planting Plan of P32- Artist Hostel in Appendix E.
MOP4	MOP4	Buffer trees for screening purposes or other softscape treatments such as vertical green wall/ climbers/ green roof/ vertical greening shall be incorporated to soften the hard architectural and engineering structures and facilities.	Alongside superstructures within WKCD/ After completion of superstructure construction/ Throughout operation	Private Developer (for land sale lots); WKCDA (for WKCD facilities)			у		EIAO-TM	Refers to Landscape Mitigation Plan in Appendix B; Compensatory Tree Planting Plan of Lyric Theatre_ Dwg. no. CP-01 & Landscape Planting Plan of Lyric Theatre in Appendix D; & Landscape Planting Plan of P32- Artist Hostel & Planting Schedule in Appendix E.
MOP5	MOP5	Use of natural colour tones (e.g. green color) for wind turbines located along the waterfront, to make them visually more compatible with the surroundings.	-	-					EIAO-TM	There is no wind turbines within the site boundary.
MOP6	MOP6	Appropriate positioning and angling of the solar panels to avoid significant visual impacts on the VSRs located at upper levels in close proximity.	WKCD building rooftops/ During daytime/ Throughout operation stage	Private Developer (for land sale lots); WKCDA (for WKCD facilities)	у		У		EIAO-TM	There is no solar panel within the site boundary.
MOP7	MOP7	Aesthetic design of roads and streetscapes	Alongside WKCD roads and streets/ During design stage/ Throughout operation phase	Design Architect/ Contractor appointed by WKCDA	у		у		EIAO-TM	Refers to Landscape Mitigation Plan in Appendix B; & Landscape, Architectural and Chromatic Treatment of the Hard Architectural and Engineering Structures and Facilities. In Appendix G.
MOP8		Human scale design for the WKT Plaza and Intersection of Canton Road and Austin Road	-	-					EIAO-TM	WKT Plaza and Intersection of Canton Road and Austin Road are outside this project boundary.
MOP9	MOP9	Night time lighting control measures such as the use of sensors and timers could help reduce usage after hours.	WKCD building exterior and open areas/ During night time/ Throughout operation stage	Private Developer (for land sale lots); WKCDA (for WKCD facilities)			у		EIAO-TM	Night time lighting control measures such as the use of sensors and timers will be provided to reduce usage after hours.

Remark: Des – Design Stage, Con – Construction Stage, Op – Operation, Dec – Decommissioning



**Appendix A – Landscape and Visual Mitigation Measures in Approved EIA Report** 

## **Landscape and Visual Mitigation Measure during Construction and Operation Phase** (from Approved EIA Report, Register NO.: AEIAR-178/2013)

CM1 – Trees to be retained in situ on site as far as possible. Should tree removal be unavoidable due to construction impacts, trees will be transplanted or felled with reference to the stated criteria in the Tree Removal Applications to be submitted to relevant government departments for approval in accordance to ETWB TCW No. 29/2004 and 10/2013.

CM2 - Compensatory tree planting shall be incorporated to the proposed project and maximize the new tree, shrubs and other vegetation planting to compensate tree felled and vegetation removed. Also, implementation of compensatory planting should be of a ratio not less than 1:1 terms of quality and quantity within the site.

CM3 - Buffer trees for screening purposes to soften the hard architectural and engineering structures and facilities.

CM4 - Softscape treatments such as vertical green wall panel/ planting of climbing and/or weeping plants, etc, to maximize the green coverage and soften the hard architectural and engineering structures and facilities.

CM5 - Roof greening by means of intensive and extensive green roof to maximize the green coverage and improve aesthetic appeal and visual quality of the building/ structure.

CM6 - Sensitive streetscape design should be incorporated along all new roads and streets.

CM7 - Structure, ornamental planting shall be provided along amenity strips to enhance the landscape quality.

CM8 - Landscape design shall be incorporated to architectural and engineering structures in order to provide aesthetically pleasing designs.

CM9 - Minimize the structure of marine facilities to be built on the seabed and foreshore in order to minimize the affected extent to the waterbody.

MCP1 - Use of decorative screen hoarding/ boards.

MCP2 - Early introduction of landscape treatments.

MCP3 - Adoption of light colour for the temporary ventilation shafts for the basement during the transition period.



MCP4 - Control of night time lighting

MCP5 - Use of greenery such as grass cover for the temporary open areas will help achieve the visual balance and soften the hard edges of the structures.

OM1 - Provide proper planting maintenance on the new planting areas to enhance the aesthetic design degree.

OM2 - Provision of open space in various forms and at different levels on or above ground, including park, waterfront promenade, piazzas and terrace garden and associated green connections for public enjoyment.

MOP1 - Undulating berms and the trees planted in the surroundings of the existing WHC and MTR ventilation buildings.

MOP2 - Clusters of shade planting and appropriate landscaping are designed to provide a relaxing waterfront environment, soften the water edge and helps mitigate the visual impacts associated with the existing WHC and MTR ventilation buildings.

MOP3 - The unique designed roof top gardens and green roof are considered as mitigation measures to lessen the visual impacts and provide new visual resources when viewed from the VSRs at higher levels.

MOP4 - Buffer trees for screening purposes or other softscape treatments such as vertical green wall/ climbers/ green roof/ vertical greening shall be incorporated to soften the hard architectural and engineering structures and facilities.

MOP5 - Use of natural colour tones (e.g. green color) for wind turbines located along the waterfront, to make them visually more compatible with the surroundings.

MOP6 - Appropriate positioning and angling of the solar panels to avoid significant visual impacts on the VSRs located at upper levels in close proximity.

MOP7 - Aesthetic design of roads and streetscapes

MOP8 - Human scale design for the WKT Plaza and Intersection of Canton Road and Austin Road

MOP9 - Night time lighting control measures such as the use of sensors and timers could help reduce usage after hours.

**Appendix B – Landscape Mitigation Plan** 




#### **Landscape and Visual Mitigation Measures:**

CM1 - Trees should be retained in situ on site as far as possible. Should tree removal be unavoidable due to construction impacts, trees will be transplanted or felled with reference to the stated criteria in the Tree Removal Applications to be submitted to relevant government departments for approval in accordance to ETWB TCW No. 29/2004 and 3/2006.

CM2 - Compensatory tree planting shall be incorporated to the proposed project and maximize the new tree, shrubs and other vegetation planting to compensate tree felled and vegetation removed. Also, implementation of compensatory planting should be of a ratio not less than 1:1 in terms of quality and quantity within the site.

- CM3 Buffer trees for screening purposes to soften the hard architectural and engineering structures and facilities.
- CM4 Softscape treatments such as vertical green wall panel/ planting of climbing and/or weeping plants, etc, to maximize the green coverage and soften the hard architectural and engineering structures and facilities.
- CM5 Roof greening by means of intensive and extensive green roof to maximize the green coverage end improve aesthetic appeal and visual quality of the building/structure.
- CM6 Sensitive streetscape design should be incorporated along all new roads and streets.
- CM7 Structure, ornamental planting shall be provided along amenity strips to enhance the landscape quality.
- CM8 Landscape design shall be incorporated to architectural and engineering structures in order to provide aesthetically pleasing designs.
- OM2 Provision of open space in various forms and at different levels on or above ground, including park, waterfront promenade, piazzas and terrace garden and associated green connections for public enjoyment.
- MOP2 Clusters of shade planting and approriate landscaping are designed to provide a relaxing waterfront environment, soften the water edge and helps mitigate the visual impacts associated with the existing WHC and MTR ventilation buildings.
- MOP3 The unique designed roof top gardens and green roof are considered as mitigation measures to lessen the visual impacts and provide new visual resources when viewed from the VSRs at higher levels.
- MOP4 Buffer trees for screening purposes or other softscape treatments such as vertical green wall/ climbers/ green roof/ vertical greening shall be incorporated to soften the hard architectural and engineering structures and facilities.
- **MOP7** Aesthetic design of roads and streetscapes

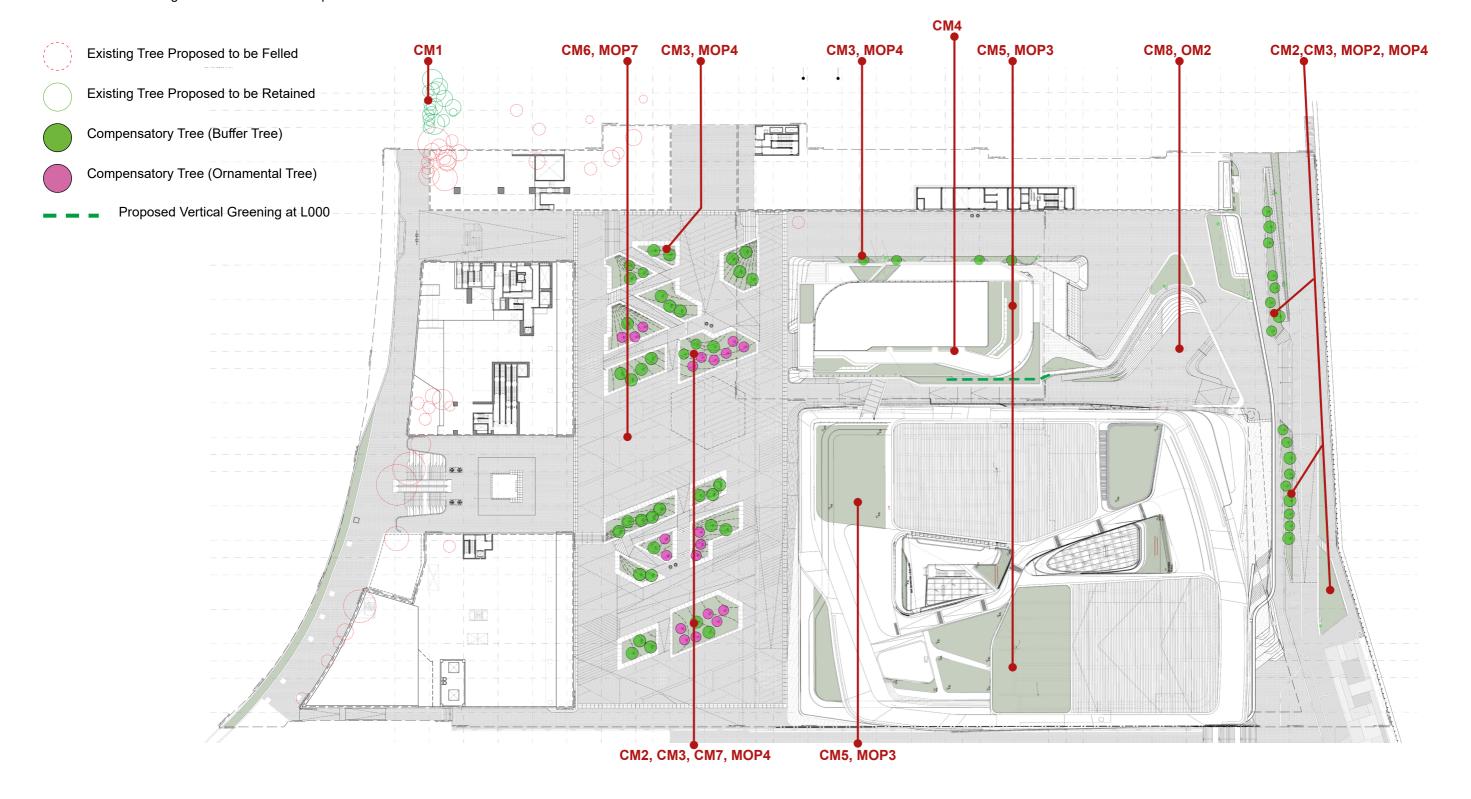

## **Appendix C – Tree Removal Application**

(Tree Removal Application was approved on 28 May 2015 under DLO letter ref.: (13) in DLOKW KX2844 (T) IV)



Tel:

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圖文傳真

2782 5061

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Fax: Email:

eskwhmt@landsd.gov.hk

本署檔號

Our Ref.: (13) in DLOKW KX 2844 (T) IV

來函檔號

Your Ref. LT 15003046

來吶請許明本署檔號

Please quote our reference in your reply



## DISTRICT LANDS OFFICE. KOWLOON WEST LANDS DEPARTMENT

我們矢志努力不懈,提供盡善盡美的土地行政服務。 We strive to achieve excellence in land administration.

九龍上海街二百五十號油麻地停車場大廈十樓 10TH FLOOR, YAUMATEI CARPARK BUILDING, 250 SHANGHAI STREET, KOWLOON.

網址 Web Site: www.info.gov.hk/landsd

28 May 2015

West Kowloon Cultural District Authority c/o LWK & Partners (HK) Ltd. 15/F., North Tower World Finance Centre Harbour City Tsim Sha Tsui Kowloon

(Attn: Mr. Michael Thomas)

By Fax (2572 4908) and By Post

Dear Sir,

Consultancy Services for the Design of the Construction of the Proposed Lyric Theatre for the West Kowloon Cultural District Authority Tree Preservation and Removal Application

I refer to the letter of 15 May 2015 issued by LWK & Partners (HK) Ltd. together with Tree Preservation and Removal Application (1st Submission) (Apr 2015) ("the Application").

Consent is hereby given to the felling of 42 nos. of trees as proposed in the Application pursuant to Special Condition No. 13 of the Tenancy Agreement dated 23 December 2011 as supplemented by the Supplementary Agreement dated 3 June 2013 for Short Term Tenancy No. KX2844 and the subsequent amendments as agreed via your letters of 22 March 2013, 23 May 2014 and 22 July 2014 subject to the following conditions:-

- Your due execution of the attached Undertaking within one month from (i) the date of this letter.
- (ii) To implement the tree compensatory planting proposal as shown on Drawing Nos. CP-01 to CP-05 attached to the Application to replant 85 nos, of trees before end of 2020.
- (iii) To submit a coordinated compensatory planting proposal (3 copies) within one month from the date of this letter.

本信息及任何附件只供收件人使用,而其中可能載有機密及/或屬法律特權的資料。敬請注意,未經許可,不得擅自披露或使用本信息。倘本 信息誤傳給你,請立即通知本署,並刪除或銷毀本信息。本署絕不承擔因使用本信息而引致的任何法律責任。

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Please also note LAO Practice Note No. 7/2007 and upon completion of the proposed compensatory planting proposal to submit the relevant report with photos as required under the said Practice Note for compliance checking.

Yours faithfully,

(KK Ho) for District Lands Officer/Kowloon West

Encl.

c.c. (w/e)

WKCDA (Attn.: Dr. Chan Man-wai) Fax: 2895 1286 HAB (Attn.: Ms. Kathy Chan) Fax: 3102 5997 PM(K), CEDD (Attn.: Ms. Florence Wong) Fax: 2369 4980 AD/V (Tree Unit) (Attn.: Mr. Henry Ng) Fax: 3151 7870

#### UNDERTAKING

IN CONSIDERATION of the approval given by the District Lands Officer, Kowloon West (hereinafter referred to as "the District Lands Officer") for the felling of 42 nos. of trees as shown on the Drawing No. TS-01 and the Tree Assessment Schedule (in Annex C) as attached in the Tree Preservation and Removal Application 1st Submission Apr 2015 ("the Application") as attached to the letter dated 15 May 2015 issued by LWK & Partners (HK) Ltd. ("the Consultant"), WE, West Kowloon Cultural District Authority hereby agree and undertake to implement in all respects to the satisfaction of the District Lands Officer a compensatory planting in accordance with the proposals set out in the Application and shown on Drawing Nos. CP-01, CP-02, CP-03, CP-04 and CP-05 or such other proposals as shall be approved by the District Lands Officer before end of 2020 or within such other extended period or periods as may be approved by the District Lands Officer. In the event of the non-fulfilment of this obligation, the District Lands Officer may carry out the necessary works on our behalf at our expense and we shall pay to the Government on demand a sum equal to the cost thereof, such sum which shall include supervisory and overhead charges, to be determined by the District Lands Officer whose determination shall be final and shall be binding upon us.

IN WITNESS whereof we have caused the Corporate Seal of the West Kowloon Cultural District Authority affixed hereunto

SEALED with the Corporate Seal of

West Kowloon Cultural District Authority

and authenticated by

, 2015.

## CONSULTANCY SERVICES FOR THE DESIGN OF THE CONSTRUCTION OF THE PROPOSED LYRIC THEATRE FOR THE WEST KOWLOON CULTURAL DISTRICT AUTHORITY

## TREE PRESERVATION AND REMOVAL APPLICATION

1st Submission

Apr 2015



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Annex C	Tree Assessment Schedule
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Annex E	Location Plan
Annex F	Compensatory Tree Planting Plan

#### 1. INTRODUCTION

#### 1.1 Background

The West Kowloon Cultural District Authority (named "Authority" hereafter) is invested by the Government of the Hong Kong Special Administrative Region to meet the long-term infrastructure needs of the arts and cultural sector, which is a vital part of any world-class city's economic and social fabric. The West Kowloon Cultural District Authority ("WKCDA") was established under the West Kowloon Cultural District Authority Ordinance ("WKCDA Ordinance"), Cap. 601, to develop the WKCD. The WKCD include:

- Planning, design and construction of 17 core arts and cultural facilities (CACF) (comprising 15 performing arts venues, a cultural institution with museum functions (M+) together with its off-site conservatory laboratory and storage facilities, and as exhibition centre), other arts and cultural facilities (OACF), Retail, Dining and Entertainment (RDE) facilities, transport facilities and 23 ha public open space (which collectively constitute the "Capital Projects");
- Planning of the WKCD and project management which include consultancies, technical studies and public consultation for the preparation of a development plan for the whole WKCD site, and project management during the planning and construction stage;
- Major repair and renovation of the facilities; and
- Collection, exhibition development, conservation laboratory equipment, and library setup for the M+

CACF are tentatively planned to be commissioned in 2 Batches, The Lyric Theatre is one of the venues included in the Batch TWO CACF.

LWK has been commissioned to conduct a tree impact assessment and compensatory planting report (the report) for such development. This report provides detailed information on the existing trees to be affected by the Project, proposed treatments to the affected trees, recommendation of the compensatory planting for the proposed felled trees and related methodologies.

#### 1.2 Description of the Project

The WKCD site is bounded by Canton Road and Austin Road at the eastern and northern sides respectively. The Lyric Theatre ("the Site") is located at the western portion of WKCD; the application area is approx.  $37434.15m^2$  as shown in **Figure 1**, **Figure 2** and **Annex G**. The Site is located in the south of Artist Square and in east of the new museum for visual culture, M+. The north side of the Site will directly face the Artist Square, one of the major focal points along the Avenue, which offer a direct connection to public open space and provide a public entrance plaza to the Site. The south of the Site faces the unique and spectacular views of the Victoria Harbour and Hong Kong Island skyline. The east and west side of the Site will form pedestrian way connecting the Avenue to the waterfront promenade.

The Lyric Theatre project (the "Project") will make use of the whole Project Site which involves the design, construction and commissioning of a new multi-storey theatre with 2 levels of basement tentatively. Resident company facilities and RDE facilities will be included

in this Project to promote the vibrancy and diversity of functions and activities. The Project would occupy the primary frontage towards the Artist Square.

The Project also involves the design, construction and commission of the associated Common Basement and Public infrastructure Works (PIW) interfacing with the Lyric Theatre.

The Site is on reclaimed land and various infrastructure and underground utilities are located within the Site including: drainage reserves; waterworks reserve; drainage outlet; access roads and utilities facilities; MTRCL's Airport Express Link (AEL) & Tung Chung Line (TCL) tunnel and associated ventilation buildings; temporary barging point Express Rail Link; underground sea water pumping station for Kowloon Government Office and the "Elements" shopping mall; cooling main for "Elements"; associated seawater intake and outlet culverts.



Figure 1

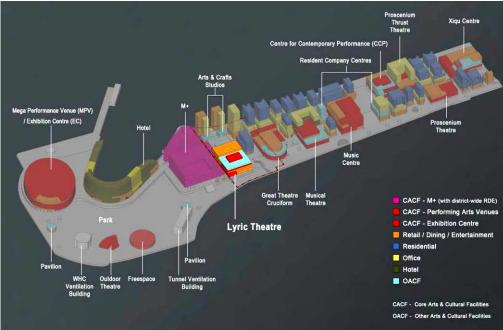


Figure 2

#### 2. TREE SURVEY

The tree survey was carried out on 23 March 2015 within the Site for any tree may affected by this proposed development. The location of each individual tree within the survey boundary is shown in Tree Survey and Recommendation Plan at **Annex B** and a detailed description of each tree such as DBH, crown spread and tree ID numbers is given in the Tree Assessment Schedule at **Annex C**. The photographic record of individual tree is shown in **Annex D**.

#### 2.1 Description of Vegetation

A total of **61** trees (include **3** dead trees) were surveyed within the tree survey boundary and **61** trees of the amount would be affected by the Project.

**8** species were surveyed which included **2** native species and **6** exotic species. **46** nos. of the undesirable invasive species, *Leucaena leucocephala* were recorded. The affected trees species was dominated by mainly exotic species such as *Leucaena leucocephala*.

#### 2.2 Summary of Existing Trees

Species and quantity of existing trees recorded within the tree survey boundary are tabulated below:

Botanical Name	Chinese Name	Qty.
Acacia auriculiformis	耳果相思	1
Acacia confusa	台灣相思	3
Bauhinia x blakeana	洋紫荊	1
Bombax ceiba	木棉	1
Cassia siamea	鐵刀木	1
Celtis sinensis	朴樹	4
Leucaena leucocephala	銀合歡	46
Melia azedarach	苦楝	1
Dead tree	枯死樹木	3
TOTAL		61

NOTE: Species highlighted in **BOLD** text denote native plant species.

#### 2.3 Condition of Existing Trees

The general health and form of the existing trees within tree survey area ranges from poor to fair and majority of them are in poor condition. Since the existing trees are located within the future development zone and many are located on slope and close to each other. Most of them are low amenity value and anticipated survival rate after transplant.

**No** registered or potential "Old and Valuable Trees" (OVTs) or potentially registerable as old and valuable trees (Potentially Registerable Trees) or as protected by law were recorded within the tree survey boundary.

**No** rare or endangered tree species were recorded within the tree survey boundary. All recorded species are commonly found in Hong Kong.

Details of the condition of individual trees are recorded in the Tree Assessment Schedule at **Annex C** and photographic records for individual trees are included in **Annex D**.

#### 3. PROPOSED TREATMENT OF EXISTING TREES

#### 3.1 Impact of the Project on Existing Trees

Unavoidable conflicts between the Project and existing trees are as follows:

- Proposed Site hoardings;
- Proposed piling works;
- Proposed site formation works;
- Proposed roads, underground services and ancillary works; and
- Proposed buildings.

The details of the impacts are shown in the proposed Project layout superimposed on the Tree Survey and Recommendation Plan under **Annex B** (Drawing No. **TS-01**).

#### 3.2 Proposed Treatment of Existing Trees

The species, size, maturity, character, amenity and cultural value of all trees have been carefully considered in the preparation of this proposal. Tree removal has been proposed only once all other options for preservation have been exhausted. All tree works will be carried out in accordance with specification/guidelines/etc.

The proposed treatment for all existing trees within the tree survey boundary is summarised in the table below:

Botanical Name	Chinese Name	Retain	Transplant	Fell	Total
Acacia auriculiformis	耳果相思	-	-	1	1
Acacia confusa	台灣相思	-	-	3	3
Bauhinia x blakeana	洋紫荊	-	-	1	1
Bombax ceiba	木棉	-	-	1	1
Cassia siamea	鐵刀木	-	-	1	1
Celtis sinensis	朴樹	-	-	4	4
Leucaena leucocephala	銀合歡	19	-	27	46
Melia azedarach	苦楝	-	-	1	1
Dead tree	枯死樹木	-	-	3	3
TOTAL		19	-	42	61

#### 3.3 Trees Proposed to be Retained

**19** nos. of *Leucaena leucocephala* are found within the application site. Due to they are located away from the construction area which will not be disturbed therefore they are proposed to be retained.

#### 3.4 Trees Proposed to be Transplanted

The majority of the existing trees within the Site are located on a slope; according to the existing constraints it would be difficult to form healthy and balanced root balls for transplantation, even if it were possible to physically transplant any of the trees, unbalanced growth would result in low amenity value and low survival rate after transplanting.

For the rest of the existing trees, they are also low amenity value and low survival rate after transplanting, therefore none of the existing trees are proposed to be transplanted.

#### 3.5 Trees Proposed to be Felled

**42** existing trees will be unavoidably affected by the permanent and temporary works associated with the Project.

The proposed treatment for existing trees is shown in **Drawing No. TS-01** under **Annex B** and a detailed description of each tree such as DBH, crown spread and tree ID numbers is given in the Tree Assessment Schedule at **Annex C**.

#### 4. COMPENSATORY TREE PLANTING PROPOSAL

#### 4.1 Quantity and Quality of Compensatory Tree Planting

To compensate for the loss of **42** trees of aggregate **8496** DBH, **85** new heavy standard trees will be planted within the Site and The Park of WKCD Area. Planting density is as shown on plan and shall be at a minimum spacing of 5m centres to allow adequate room for future growth. The planting areas for compensatory trees will have a minimum soil depth of 1.2m (excluding drainage layer where applicable) see **Annex GZ** for detail.

The details of the compensatory planting proposal are as follows:

Item	Value
Number of trees proposed to be felled (quantity)	42
Total loss in DBH (mm)	8496
Individual DBH of compensatory trees (mm)	100
number of compensatory trees (quantity)	85
Aggregate DBH of compensatory tree (mm)	8500
Ratio of compensation (quantity)	1:2.02
Ratio of compensation (aggregate DBH)	1:1.000

#### 4.2 Compensatory Tree Planting

The compensatory tree planting proposal is shown on the Compensatory Tree planting Plan (drawing no. **CP-01 - CP-05**). All planting materials and works will be in accordance with the *General Specification for Building* (2012) and the Particular Specification for the Project. A number of considerations were included in the selection of proposed compensatory tree species such as:

- Amenity value;
- Availability in the market.
- Biodiversity;
- Ecological value;
- Native / exotic;
- Suitability for the Site;
- Seasonal colour; and
- Shade and microclimate;

The proposed species and sizes for compensatory tree planting are given below. In accordance with ArchSD's *General Specification for Building* (2012), heavy standard trees with 100mm DBH are proposed. Please note that this is a preliminary and indicative list and will be developed further during detailed planting design in line with the selection criteria given above.

ID	Botanical Name	Chinese Name	DBH (mm)	Qty.
TC	Terminalia catappa	欖仁樹	100	7
PA	Polyspora axillaris	大頭茶	100	13
SH	Schefflera heptaphylla	鴨腳木	100	10
MP	Mallotus paniculatus	白楸	100	6
Cafi2	Castanopsis fissa	黧蒴錐	100	6
CN	Cleistocalyx nervosum	水翁	100	11
EC	Elaeocarpus chinensis	中華杜英	100	9
ES	Elaeocarpus sylvestris	膽八樹	100	6
SSE	Sapium sebiferum	烏桕	100	6
SSU	Schima superba	木荷	100	3
Fm2	Ficus microcarpa	細葉榕	100	2
Tt2	Tipuana tipu	大班木	100	3
Bv2	Bauhinia variegata	宮粉羊蹄甲	100	3
TOTAL				85

NOTE: Species highlighted in **BOLD** text denote Native plant species.

#### 5. CONCLUSION

A tree survey has been carried out within the respective Project Area to record the number of trees, species name, trunk diameters, height, crown spread, tree form, health condition, survival rate after transplantation and amenity value as part of WKCD's application for a Tree Removal permit.

A total of **61** trees were surveyed within the application area, **3** dead trees and **46** undesirable adventitious weed species *Leucaena leucocephala*. Out of the **61** trees surveyed, **19** trees are to be retained; no trees to be transplanted; **42** trees are proposed to be felled. Trees in conflict with the development are dominated by low amenity value individuals.

All trees surveyed were common species. **No** registered "Old and Valuable Trees" were recorded. **No** trees of particular value were specified under the Lease.

**85** trees of heavy standard size in 100mm DBH are proposed to compensate for the loss of **42** existing trees; the ratio of the loss trees and the compensatory trees in terms of quantity is **1:2** and the ratio of the loss trees and the compensatory trees in terms of DBH is **1:1**.

ANNEX A

TREE SURVEY METHODOLOGY

#### TREE SURVEY METHODOLOGY

#### E. Definitions

**Tree:** A woody plant with a stem diameter over 95mm measured at a point 1.3m above the root collar (DBH).

**DBH:** "Diameter at breast height" as defined in AFCD PN No. 2/2006 *Measurement of Diameter at Breast Height (DBH)*.

**Tree Survey:** To survey all "trees" (see definition above) within the tree survey area in accordance with government requirements under Lands Department Practice Note No. 7/2007 *Tree Preservation and Tree removal Application for Building Development in Private Projects*.

#### F. Topographic Survey

Each tree was allocated a tree number and clearly marked on Site with an identity label showing the tree number in accordance with specification.

An accurate topographic survey was carried out by a qualified Surveyor. Measurements of tree dimensions (DBH, height and spread), location and top-of-soil level (in mPD at root zone) were recorded. The survey area covered the Works area for the Project, including temporary and permanent Works.

All trees were identified by species. Where necessary, identification was verified / assisted by AFCD Hong Kong Herbarium or CUHK Herbarium.

#### G. Photographic Record

Individual photographic records were taken of each tree where possible, meeting the following standards as applicable:

- Where practical (within reasonable distance and within a safe location), the whole form of the individual tree was shown;
- Where obstacles were present (e.g. structures, other vegetation, dense covering of climbers, etc.), the main tree trunk(s) from ground level to a height of at least 3m was shown:
- Where special feature(s) at the base of the tree base were present (e.g. exposed roots, special rooting medium, etc.), the photo was taken from the location where said feature as well as the largest possible part of the tree could be seen.

#### H. Tree Assessment Schedule

A tabulated assessment of each tree was produced including the following information:

- Tree identification number;
- Relevant tree survey drawing number;
- Tree species (botanical name and Chinese name);
- Top-of-soil level at root zone (in mPD);
- DBH;
- Overall height;
- Average crown spread;
- Health (good / fair / poor);
- Amenity value (high / medium / low);
- Form (good / fair / poor);
- Survival rate after transplanting (high / medium / low);
- Predicted form after transplanting (good / fair / poor);
- Proposed treatment (retain / transplant / fell);
- Justification for felling; and
- · Other remarks.

#### I. Tree Survey Plan

A tree survey plan in CAD format was prepared including the following information:

- Topographical information (tree identification number, location and levels);
- DBH (to scale);
- Crown spread (to scale);
- Overlay of proposed ground level Project layout and temporary Works; and
- Individual tree recommendations (retain / transplant / fell).

#### J. Assessment of Tree Health

The health of each tree was assessed by examining each portion of the tree as follows:

- **Foliage:** Colour; general appearance; and evidence of insect infestation or fungal infection.
- **Branches:** Damaged, broken, cut, dead or dying back; evidence of insect infestation or fungal infection.
- **Trunk:** Cavities; serious bark damage; wounds; internal or external rot; evidence of insect infestation or fungal infection; sap seeping through the bark.

#### K. Assessment of Tree Form

The form of each tree was assessed by examining overall shape of the tree as follows:

- **Crown:** Balance; shape; typical form; density.
- Branches: Balance; broken or missing; contorted.
- Trunk: Upright, leaning, twin or multiple trunks, expected shape.

#### L. Assessment of Tree Amenity Value

The amenity value of each tree was assessed according to the following criteria:

- Health:
- Form;
- Native or exotic species;
- Size and maturity:
- Function (e.g. screening, shade, wind break, etc.); and
- Character (e.g. theme tree, landmark, feng shui, etc.).

#### M. Assessment of Suitability for Transplanting

In order to be successfully transplanted, a tree must maintain good health throughout preparation and during and after the transplantation process. At no time may it be unstable or present any threat to public or site staff safety. In assessing the suitability of individual trees for transplanting, the following criteria were addressed:

- **Species:** Experience has shown that certain species do not recover well after transplanting, with the risk that they may subsequently die and pose a safety risk. Other species may be undesirable, e.g. *Leucaena leucocephala*.
- **Size:** Larger and older trees are more difficult to transplant successfully and have lower capacity for recovery due to the root and crown pruning required before transplanting.
- **Health:** Trees in poor health are highly unlikely to withstand the stress of transplantation.
- **Form:** Trees of leaning or unbalanced form are at risk of instability during root ball preparation and after transplanting. The form of trees after crown pruning for transplanting may also make them unsuitable for transplanting.
- Amenity: Transplanting of trees with little or no amenity value is not justified.
- Root ball preparation: Site topography, above and below ground utilities, other nearby trees, rocky ground or surrounding hard paving may seriously reduce the feasibility of preparing a sufficiently large root ball for successful transplantation.
- Accessibility: Steep slopes, uneven terrain or lack of space for the large machinery required to lift trees will drastically reduce the feasibility of successful transplantation.
- **Transportation:** Due to the physical limitations of existing roads transporting vehicles, trees to be transplanted off-Site cannot exceed 3m in width or 7m in length, respectively. Limiting pruning to no more than 25% of the existing tree crown, no tree of over 4m spread can be transplanted off-Site.

#### N. Criteria for Recommendation of Transplanting of Existing Trees

The preferred option for all trees is to be retained in situ unless they pose a threat to the public, they are of an invasive or otherwise undesirable species (e.g. *Leucaena leucocephala*), or they unavoidably conflict with the Project. In such cases, trees will first be considered for transplanting.

Transplanting was recommended under the following conditions:

- The tree was assessed as suitable for transplanting.
- Unavoidable proximity of proposed retaining walls, temporary works, roads, buildings or other structures including their foundations, which pose major conflicts with the tree or its branches or root system.
- Proposed major changes to ground levels affecting the ground water table, or large areas of proposed cut and/or fill unavoidably affecting the tree.
- The tree was assessed to possess a justifiable amenity value and replacement with a new nursery grown specimen of the same species and comparable size is deemed less cost effective than transplanting.

#### O. Criteria for Recommendation of Felling of Existing Trees

Felling of existing trees was considered as a last resort and only recommended under the following conditions:

- The tree was assessed as unsuitable for transplanting.
- Unavoidable proximity of proposed retaining walls, temporary works, roads, buildings or other structures including their foundations, which pose major conflicts with the tree or its branches or root system.
- Proposed major changes to ground levels affecting the ground water table, or large areas of proposed cut and/or fill unavoidably affecting the tree.
- The tree is not an OVT under LCSD's Register of Old and Valuable Trees; nor a "Champion Tree" listed in Jim, C.Y. (1994) Champion Trees in Urban Hong Kong, Urban Council, Hong Kong.
- The tree is not irreplaceable, of a rare or protected species or an unusually large or fine example of its species.
- The tree is not a significant landmark tree and does not have special *feng shui* or cultural significance.
- Felling would not cause a serious loss of species diversity in the area.
- Adequate compensatory tree planting can be implemented.
- The tree was found dead, diseased, or otherwise assessed as a risk to public or Site safety.


#### P. References

The following ordinances, practice notes, technical circulars and other references were consulted in the preparation of this Proposal:

- AFCD Conservation PN No. 2 Measurement of Diameter at Breast Height (DBH)
- AFCD Conservation PN No. 3 The Use of Plant Names
- ETWB TCW No. 29/2004 Registration of Old and Valuable Trees, and Guidelines for their Preservation
- ETWB TCW No. 10/2013 Tree Preservation
- HK Ordinance Cap.96 Forest and Countryside
- HK Ordinance Cap.586 Animals and Plants (Protection of Endangered Species)
- HU, Q. et al (2003) *Rare and Precious Plants of Hong Kong*. AFCD, Hong Kong (Website: <a href="http://www.hkherbarium.net/herbarium/html%20text/Rare%20plant">http://www.hkherbarium.net/herbarium/html%20text/Rare%20plant</a> E%20Introduction.htm
- Jim, C.Y. (1994) Champion Trees in Urban Hong Kong. Urban Council, Hong Kong
- LAO PN No. 7/2007 Tree Preservation and Tree Removal Application for Building Development in Private Projects
- Leisure and Culture Services Department *Register of Old and Valuable Trees* (Website: http://ovt.lcsd.gov.hk/ovt/)
- Webb, R. (1991) *Tree Planting and Maintenance in Hong Kong*. Standing Interdepartmental Landscape Technical Group, Hong Kong Government, Hong Kong

## ANNEX B

TREE SURVEY AND RECOMMENDATION PLAN

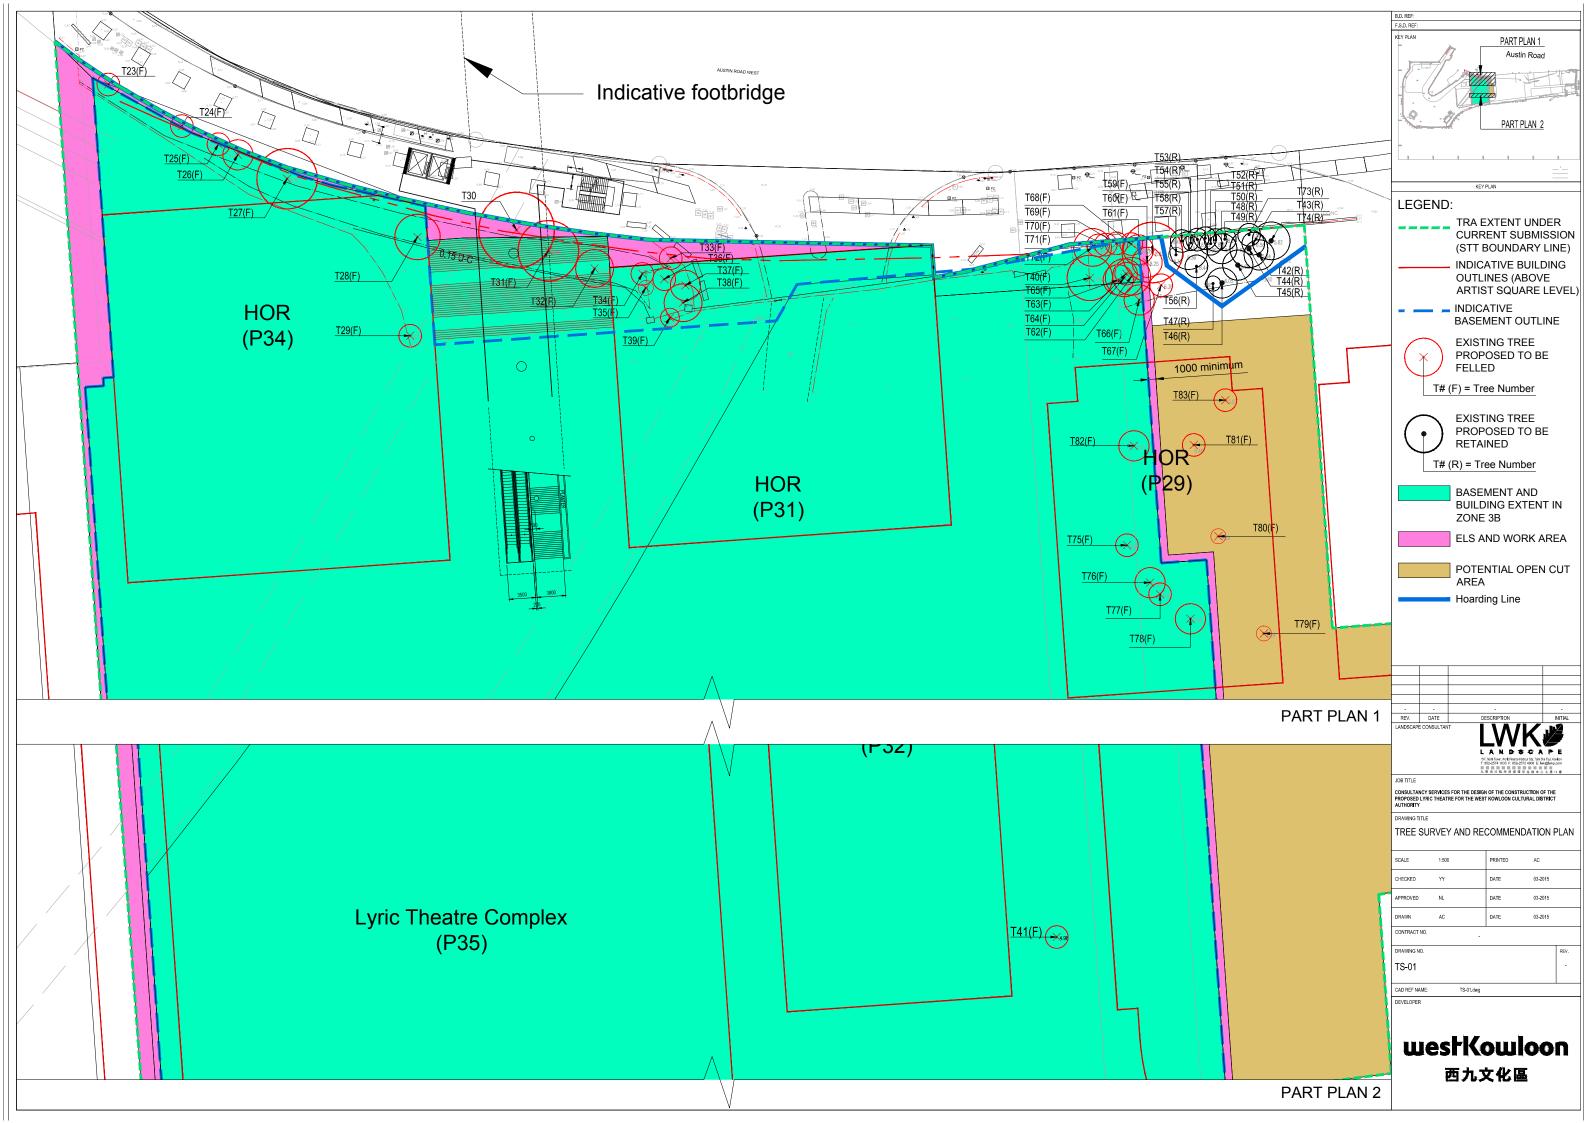

## ANNEX C

TREE ASSESSMENT SCHEDULE

### TREE ASSESSMENT SCHEDULE

Consultancy Services for the Design of the Construction of the Proposed Lyric Theatre for the West Kowloon Cultural District Authority To be read in conjunction with Drawing No. TS-01 23/03/2014: First Submission PROJECT:

TOPOGRAPHIC SURVEY: 10/03/2015: SAM MAK & ASSOCIATES SURVEYORS (HK) LTD. TREE SURVEY: 23/03/2015: Chang Chok Fai (ISA-CA no. HK-0747A)

Tree ID	ree ID Photo Number			Original Location	Government Department for Tree Felling		Tree Size		Top of Soil Level above Root Zone	Form	Health	Amenity Value	Anticipated Survival Rate after Transplanting	Proposed Treatment	Remarks
Number		(Botanical name)	(Chinese name)	Location	Jurisdiction [1]	DBH (mm)	Height (m)	Spread (m)	(mPD)	(G/ F/ P)	(G/ F/ P)	(H/ M/ L)	(H/ M/ L)	(Retain/Transplant / Fell)	
T23		Leucaena leucocephala	銀合歡	Within Lot	LandsD	120	5	3	5.70	Poor	Fair	Low	Low	Fell	leaning;
T24		Acacia auriculiformis	耳果相思	Within Lot	LandsD	150	4	3	6.10	Fair	Fair	Low	Low	Fell	leaning;
T25		Leucaena leucocephala	銀合歡	Within Lot	LandsD	200	5	3	6.20	Fair	Fair	Low	Low	Fell	leaning;
T26	004 005 006	Leucaena leucocephala	銀合歡	Within Lot	LandsD	150 425	4	4	6.30	Fair	Fair	Low	Low	Fell Fell	leaning;
T27 T28	005 006	Acacia confusa Leucaena leucocephala	台灣相思 銀合歡	Within Lot Within Lot	LandsD LandsD	725	9	6	6.40 5.80	Fair Fair	Fair Fair	Low	Low	Fell	forked; on slope; multi-trunk; on slope;
T29		Leucaena leucocephala	銀合歡	Within Lot	LandsD	303	6	9	5.10	Fair	Fair	Low	Low	Fell	multi-trunk; on slope;
T30		Acacia confusa	台灣相思	Within Lot	LandsD	262	6	10	7.30	Fair	Fair	Low	Low	Fell	multi-trunk; on slope;
T31	011,012	Cassia siamea	鐵刀木	Within Lot	LandsD	300	6	8	6.90	Fair	Fair	Low	Low	Fell	on slope;
T32	013,014	Melia azedarach	苦楝	Within Lot	LandsD	335	6	5	6.20	Fair	Fair	Low	Low	Fell	leaning; on slope; forked;
T33	015	Celtis sinensis	朴樹	Within Lot	LandsD	120	4	3	7.60	Fair	Fair	Low	Low	Fell	on slope;
T34	016	Leucaena leucocephala	銀合歡	Within Lot	LandsD	200	6	3	6.58	Poor	Poor	Low	Low	Fell	leaning; on slope; abrupt bends;
T35		Dead Tree	枯死樹木	Within Lot	LandsD	141	7	2	6.50	-	-	-	-	Fell	
T36		Leucaena leucocephala	銀合歡	Within Lot	LandsD	100	7	3	6.98	Fair	Fair	Low	Low	Fell	on slope;
T37	019,020	Leucaena leucocephala	銀合歡	Within Lot	LandsD	150	6	4	7.41	Fair	Fair	Low	Low	Fell	leaning; on slope;
T38		Acacia confusa	台灣相思	Within Lot	LandsD	872	6	5	7.82	Fair	Fair	Low	Low	Fell Fell	multi-trunk; on slope; near structure;
T39 T40	022 023	Leucaena leucocephala Celtis sinensis	銀合歡 朴樹	Within Lot Within Lot	LandsD LandsD	150 150	6	2.5 6	6.55 7.90	Fair Fair	Fair Fair	Low	Low	Fell	on slope; on slope:
T41		Celtis sinensis	朴樹	Within Lot	LandsD	160	5	3	5.00	Fair	Fair	Low	Low	Fell	vined; broken branches;
T42		Leucaena leucocephala	銀合歡	Within Lot	LandsD	120	6	4	5.80	Poor	Poor	Low	Low	Retain	on slope;
T43	026	Leucaena leucocephala	銀合歡	Within Lot	LandsD	130	7	3	6.60	Poor	Poor	Low	Low	Retain	on slope;
T44		Leucaena leucocephala	銀合歡	Within Lot	LandsD	269	9	5	6.80	Poor	Poor	Low	Low	Retain	on slope;
T45	028	Leucaena leucocephala	銀合歡	Within Lot	LandsD	198	9	4	6.70	Poor	Poor	Low	Low	Retain	on slope;
T46	029,030	Leucaena leucocephala	銀合歡	Within Lot	LandsD	250	8	4	6.00	Poor	Poor	Low	Low	Retain	on slope;
T47	031,032	Leucaena leucocephala	銀合歡	Within Lot	LandsD	110	5	2	6.00	Poor	Poor	Low	Low	Retain	on slope;
T48	033	Leucaena leucocephala	銀合歡	Within Lot	LandsD	160	9	4	8.20	Poor	Poor	Low	Low	Retain	on slope;
T49		Leucaena leucocephala	銀合歡	Within Lot	LandsD	100	6	3	8.20	Poor	Poor	Low	Low	Retain	on slope;
T50	035	Leucaena leucocephala	銀合歡	Within Lot	LandsD	164	6	3	8.30	Poor	Poor	Low	Low	Retain	on slope;
T51	036	Leucaena leucocephala	銀合歡	Within Lot	LandsD	170	/	3	8.40	Poor	Poor	Low	Low	Retain Retain	on slope;
T52 T53	037 038	Leucaena leucocephala Leucaena leucocephala	銀合歡銀合歡	Within Lot Within Lot	LandsD LandsD	140 200	/ 8	3	8.40 8.40	Poor Poor	Poor Poor	Low	Low	Retain	on slope; on slope:
T54	039	Leucaena leucocephala	銀合歡	Within Lot	LandsD	100	8	2	8.50	Poor	Poor	Low	Low	Retain	on slope;
T55	040	Leucaena leucocephala	銀合歡	Within Lot	LandsD	260	8	5	8.40	Poor	Poor	Low	Low	Retain	on slope;
T56	041	Leucaena leucocephala	銀合歡	Within Lot	LandsD	110	6	3	8.40	Poor	Poor	Low	Low	Retain	on slope;
T57	042	Leucaena leucocephala	銀合歡	Within Lot	LandsD	100	7	2	8.30	Poor	Poor	Low	Low	Retain	on slope;
T58	043	Leucaena leucocephala	銀合歡	Within Lot	LandsD	200	9	3	8.50	Poor	Poor	Low	Low	Retain	on slope;
T59	044	Dead Tree	枯死樹木	Within Lot	LandsD	180	2	8	8.80	-	-	-	-	Fell	on slope; uprooted;
T60		Leucaena leucocephala	銀合歡	Within Lot	LandsD	229	7	4	8.20	Poor	Poor	Low	Low	Fell	on slope;
T61		Bauhinia x blakeana	洋紫荊	Within Lot	LandsD	120	7	4	8.60	Poor	Poor	Low	Low	Fell	on slope;
T62		Bombax ceiba	木棉	Within Lot	LandsD	160	7	5	7.20	Poor	Poor	Low	Low	Fell	on slope;
T63		Leucaena leucocephala	銀合歡	Within Lot	LandsD	130	7	3	7.60	Poor	Poor	Low	Low	Fell	on slope;
T64		Leucaena leucocephala	銀合歡	Within Lot	LandsD	180	8	5	7.20	Poor	Poor	Low	Low	Fell Fell	on slope;
T65 T66		Leucaena leucocephala  Dead Tree	銀合歡枯死樹木	Within Lot Within Lot	LandsD LandsD	150 100	3	4	7.10 6.40	Poor -	Poor -	Low	Low	Fell	on slope; on slope; uprooted;
T67		Leucaena leucocephala	銀合歡	Within Lot	LandsD	156	7	3	6.40	Poor	Poor	Low	Low	Fell	on slope;
T68		Leucaena leucocephala	銀合歡	Within Lot	LandsD	100	7	3	8.60	Poor	Poor	Low	Low		on slope;
T69		Leucaena leucocephala	銀合歡	Within Lot	LandsD	120	7	3	8.60	Poor	Poor	Low	Low	Fell	on slope;
T70		Leucaena leucocephala	銀合歡	Within Lot	LandsD	150	7	3	8.60	Poor	Poor	Low	Low	Fell	on slope;
T71		Leucaena leucocephala	銀合歡	Within Lot	LandsD	100	7	3	8.50	Poor	Poor	Low	Low	Fell	on slope;
T72	059,060	Leucaena leucocephala	銀合歡	Within Lot	LandsD	120	4	5	8.60	Poor	Poor	Low	Low	Fell	on slope;
T73	061	Leucaena leucocephala	銀合歡	Within Lot	LandsD	130	9	5	6.90	Poor	Poor	Low	Low	Retain	on slope;
T74	062	Leucaena leucocephala	銀合歡	Within Lot	LandsD	250	10	5	5.60	Poor	Poor	Low	Low	Retain	on slope;



#### TREE ASSESSMENT SCHEDULE

T82

T83

070

071

Consultancy Services for the Design of the Construction of the Proposed Lyric Theatre for the West Kowloon Cultural District Authority To be read in conjunction with Drawing No. TS-01 23/03/2014: First Submission PROJECT:

銀合歡

銀合歡

Within Lot

Within Lot

LandsD

LandsD

150

240

5

TOPOGRAPHIC SURVEY: 10/03/2015: SAM MAK & ASSOCIATES SURVEYORS (HK) LTD. TREE SURVEY: 23/03/2015: Chang Chok Fai (ISA-CA no. HK-0747A)

Leucaena leucocephala

Leucaena leucocephala

Tree ID	Photo Number (I	Tree Species		Original Location	Government Department for Tree Felling		Tree Size		Top of Soil Level above Root Zone	Form	Health	Value	Anticipated Survival Rate after Transplanting	Treatment	Remarks
Number		(Botanical name)	(Chinese name)		Jurisdiction [1]	DBH (mm)	Height (m)	Spread (m)	(mPD)	(G/ F/ P)	(G/ F/ P)	(H/ M/ L) (H/ M/	(H/ M/ L)	(Retain/Transplant / Fell)	
T75	063	Leucaena leucocephala	銀合歡	Within Lot	LandsD	150	5	3	5.50	Poor	Poor	Low	Low	Fell	
T76	064	Celtis sinensis	朴樹	Within Lot	LandsD	150	5	4	5.60	Poor	Poor	Low	Low	Fell	
T77	065	Leucaena leucocephala	銀合歡	Within Lot	LandsD	130	5	3	5.60	Poor	Poor	Low	Low	Fell	
T78	066	Leucaena leucocephala	銀合歡	Within Lot	LandsD	180	6	4	5.50	Poor	Poor	Low	Low	Fell	
T79	067	Leucaena leucocephala	銀合歡	Within Lot	LandsD	120	3	2	6.20	Poor	Poor	Low	Low	Fell	
T80	068	Leucaena leucocephala	銀合歡	Within Lot	LandsD	156	3	2	5.70	Poor	Poor	Low	Low	Fell	
T81	069	Leucaena leucocephala	銀合歡	Within Lot	LandsD	212	5	3	5.40	Poor	Poor	Low	Low	Fell	

5.10

5.30

Poor

Poor

Poor

Poor

Low

Low

Low

Low


Fell

Fell



ANNEX D

TYPICAL PLANTER DETAIL

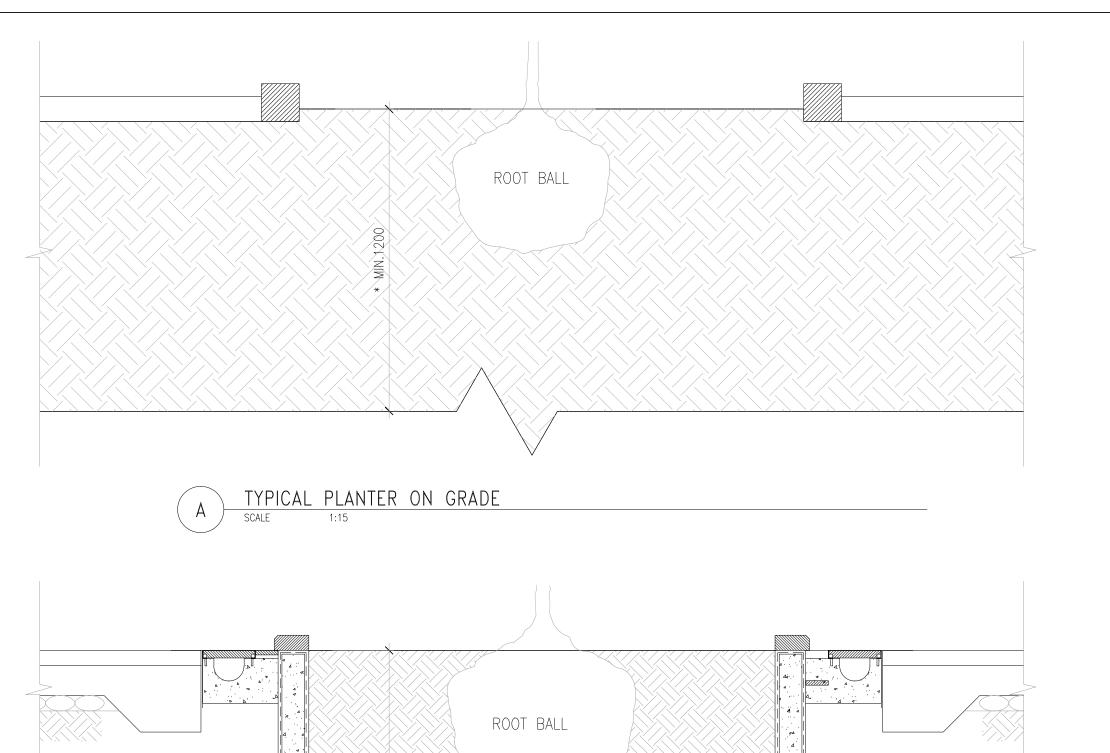

4 4 4 4 44

#### Remarks:

The proposed Heavy standard trees as compensatory plantng should provide stem diameter exceeding 100mm but not exceeding 110mm measured at a height of 1m from the root collar, a rootball at least 750mm in diameter and 400mm deep, when container grown trees are required, grown in a container at least 750mm in diameter and 600mm deep, and free of any pest, non-symbiotic fungi, disease, rubbing branches, inwardly growing branches, bark tears/abrasion and tie cuts / cankers.

Whenever the planter wall is above ground, internal side of the planter wall should be applied with a layer of architect's approved waterproofing layer product.

All planters should be built as open bottom type to facilitate proper drainage performance unless otherwise specified. In case of close bottom typed planter, it should be provided with proper drainage layering system under the soil layer.

> \*NOTE: A MIN. 1.2M SOIL DEPTH EXCLUDING DRAINAGE LAYER WILL BE PROVIDED FOR TREE PLANTING

-	-	=	-
REV.	DATE	DESCRIPTION	INITIAL
LANDSCAPE	CONSULTAN		The second
		15.F, Morth Tower, Worth Finance Herbour Chy, Ts T: 852-2574 1833 F: 852-2572 4938 E 操 黃 顏 境 觀 穀 計 事 務 所 再 九 廳 史 珍 唱 海 淋 皈 環 填 全 點 中	lwk@lwkp.com

S.D. REF:

RAWING TITLE

#### TYPICAL PLANTER DETAIL

SCALE	AS SHOWN	PRINTED	AC
CHECKED	YY	DATE	03-2015
APPROVED	NL	DATE	03-2015
DRAWN	AC	DATE	03-2015
CONTRACT NO.	-		

DRAWING NO.

LD-01

CAD REF NAME




西丸文化區管理局 West Kowloon Cultural District Authority

TYPICAL PLANTER ON STRUCTURE

ANNEX E

**LOCATION PLAN** 

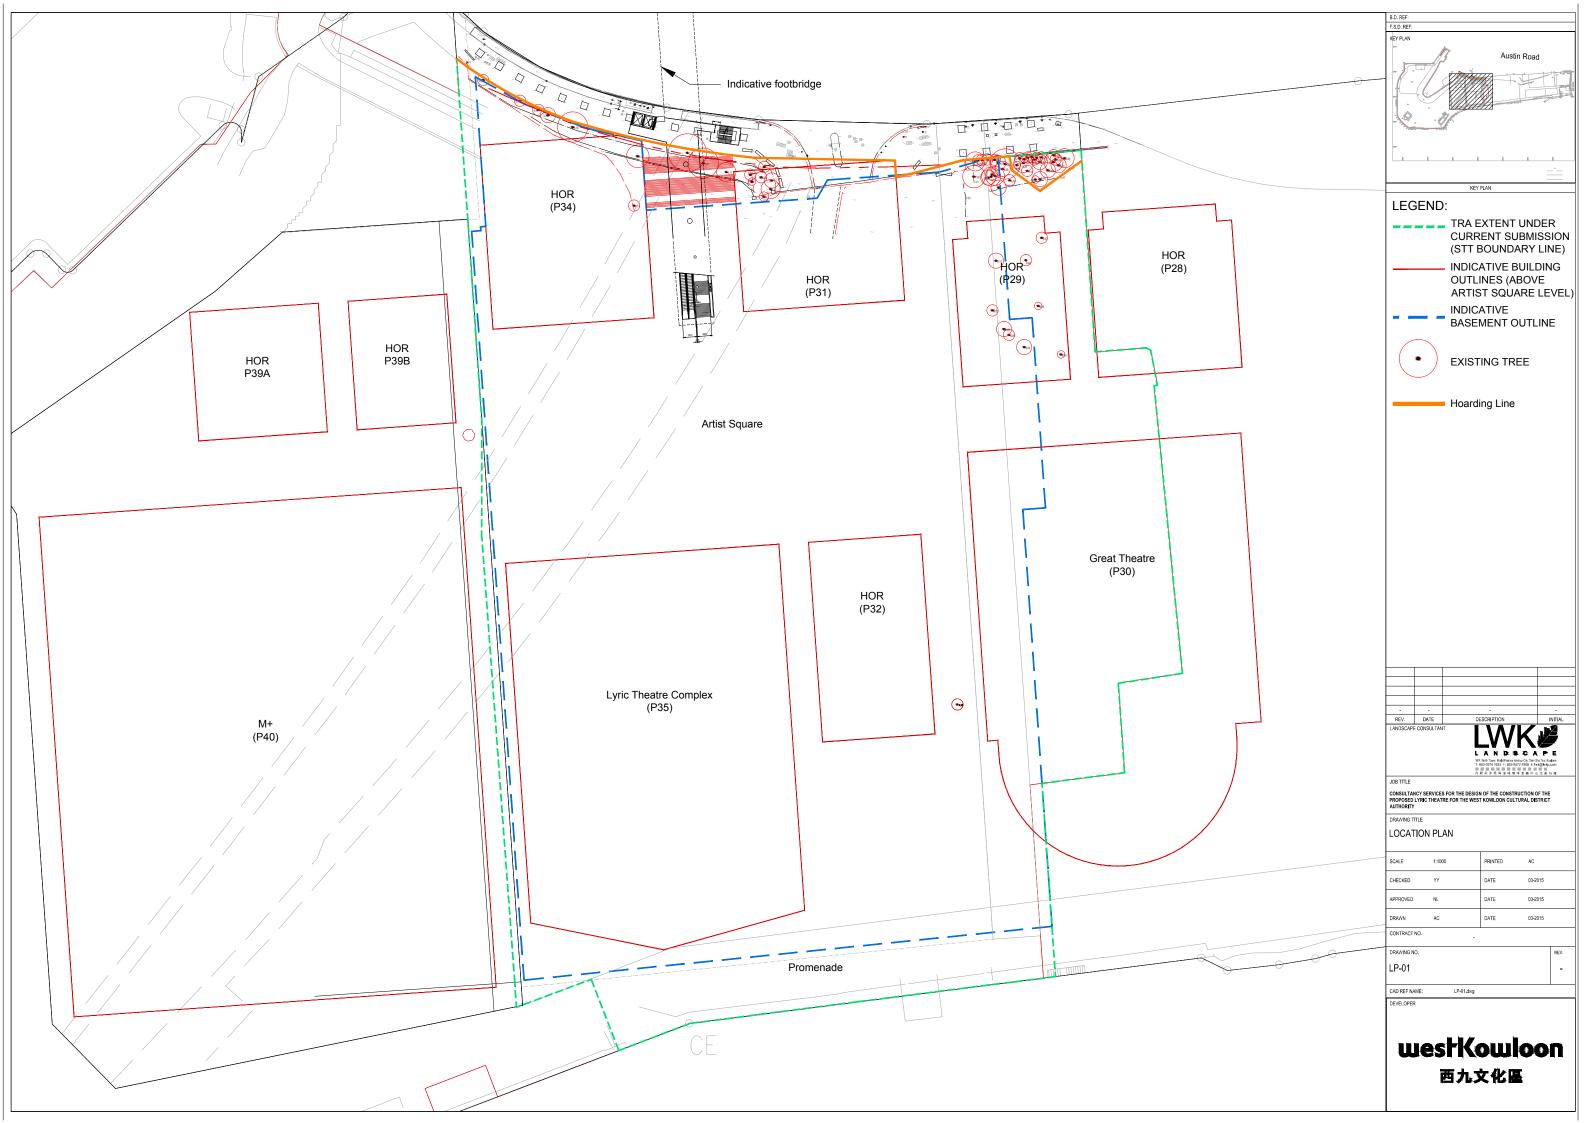

# ANNEX F

**Compensatory Tree Planting Plan** 





Our Ref.

LT20001113

Job Ref.

8092L

17 March 2020

Tel: 852-3842 7505 / Fax: 852-2782 5061

(By Fax & By Hand)

Lands Department
Lands Administration Office
District Lands Office, Kowloon West
4/F, South Tower, West Kowloon Government Offices,
11 Hoi Ting Road, Yau Ma Tei, Kowloon

Attn: Mr. LAM Yam On, Jim

Dear Madam,

Re:

Consultancy Services for The Design of The Construction of the Proposed Lyric Theatre

for The West Kowloon Cultural District Authority
- Amendment to Compensatory Planting Plan

Further to the DLO's approval of the Tree Preservation and Removal Application of the captioned on 28 May 2015 (ref. no. (13) in DLOKW KX 2844(T) IV), we would like to forward the amendment of the document as follows for your approval,

- Updated Form 1
- 2. Revised Compensatory Planting Plan (CP-01 rev. A)

We would like to reiterate that due to the change of the planters' layout, amendment to the Compensatory Planting Plan is inevitable. However, numbers and aggregated DBH of the compensatory trees are not less than the previous approved submission, other Compensatory Planting Plans CP-02 to CP-05 are kept the same as the previous approved submission.

Should you have any queries, please contact the undersigned or our Mr. Alex Chang on 3589 0639 for further information.

Thank you for your attention.

Yours faithfully, For and on behalf of LWK & PARTNERS (HK) LTD



Xylem Leung
Registered Landscape Architect
RL/IF/PW/XL/SL/AC/chh

Encl.

cc. WKCDA ADRG (Fax: 2895 0016) (Fax: 2808 0147) Mr. Alan Chan Mrs. Jenny Tang (w/ encl.)

Landscape Advisory Team

(Fax: 2412 4488)

Miss KWAN Hoi Ling, Kelly

(w/ encl.)
(w/ encl.)

#### Form 1 – Submission of Tree Preservation and Removal Proposal<sup>(Note 1)</sup> for <u>Compliance of Tree Preservation Clause under Lease<sup>(Note 2)</sup></u>

To: <u>District Lands Office/ Kowloon East & Kowloon West</u> of Lands Department (LandsD)

Section I		
Lot Number (No.)	STT No. KX2	<u>2844</u>
Address	-	Lyric Theatre for West Kowloon Cultural District with anton Road, Austin Road West
value, and any other tr	ees as designate	se (including Old and Valuable Trees, trees of particular ed and preserved under lease) ecial Condition No. 13
Tree Preservation and	-	sal (TPRP)
✓ Tree Preser	vation	
▼ Tree Felling	9	
☐ Tree Prunin	ıg	
Tree Transp	olanting	
Compensat	ory Planting	
☐ Others: #		
Submission Type (Please refer to the Guidan	ce Notes <sup>(Note 1)</sup> for	r the full list of mandatory information to be provided.)
☐ New Submi	ssion	(i.e. a formal first submission)
☐ Re-submiss	ion	(i.e. a formal submission made to comply with points of disapproval resulting from a previous submission, or constitute amendment/ revision to the initial submission)
✓ Amendmen	t Submission	(i.e. a formal submission proposing amendments and/or revisions to a previously approved submission)
Prior written approval this development	from LandsD fo	or existing tree(s) affected by this submission and/or by
<u>Yes</u> If yes,	please provide	details of the LandsD's approval letter(s):
Date (	(dd/mm/yyyy):	28 May 2015
Ref. n	0.:	(13) in DLOKW KX 2844(T) IV

Sect	ion I (cont'd)	
	or disturbed and/or interfered tree(s) other than the above prior written apparendment submission only)	proval
	No If yes, please specify: (e.g. Report(s) of emergency tree felling/prunit cause, incident report(s) of tree damage, etc. Use separate sheet, if necessity	
	#	
Exi	sting tree(s) surveyed in this TPRP	
(a)	Existing tree(s) growing within the private lot (i.e. Pink Area under the lease	plan)
	No. of trees to be retained in-situ	19
	No. of trees to be transplanted	0
	No. of trees to be felled	42
	No. of trees to be (please specify): (#	0
	Total of $(a) =$	61
(b)	Existing tree(s) growing <u>outside</u> the lot boundary or within Coloured Ar	eas
	No. of trees to be retained in-situ	0
	No. of trees to be transplanted	. 0
	No. of trees to be felled	0
	No. of trees to be (please specify): (#	0
	Total of (b) =	0
	Total no. of existing tree(s) surveyed in this TPRP =	
	i.e. (a) + (b)	61
	v tree(s) confirmed as compensatory planting for the implement	entation upon
(i)	No. of new trees to be planted, within lot	75
(ii)	No. of new trees to be planted <u>outside</u> lot or within Coloured Areas	10
	Total no. of new tree(s) confirmed as compensatory planting for implementation upon completion of this proposed development = i.e. (i) + (ii)	85

(Rev. 1/2020)

$\alpha$	. •	-	
<b>►</b> △	ction		
171	CLIVII		

Submission of TPRP for tree(s) on areas to be handed back to the Government or formed outside the lot boundary or Coloured Areas to relevant government offices

<u>No</u>

If yes, please make reference to the office/ department concerned according to distribution list at Section V.

Sectio	Section III – List of supporting document enclosed:								
	Tree Assessment Schedule (surveyed on #(dd/mm/yyyy))								
	Photographic record of existing trees (in colour, date-imprinted and marked with corresponding *identification/ reference/ serial number)								
	Documents supporting the engineering works (*drawings and/or written statement from the *structural / geotechnical engineer)								
	Others (Please specify) (#)								

#### **Section IV** - List of drawings submitted: Revision **Date Drawing No. Drawing Title** no. (dd/mm/yyyy) (if any) Tree Survey Plan with an overlay of the lease plan and latest site formation plan/building plan (in scale 1:# on \*A4/A3/A1 paper) Compensatory Planting Plan with an overlay of the lease plan and latest site formation plan/ <u>CP-01</u> 16/3/2020 <u>A</u> building plan (in scale 1 : <u>600</u> on <u>A3</u> paper) Detail(s) and sections (in scale 1:# on \*A4/A3/A1 paper) Others (Please specify)

Section V - Distribution list of relevant government departments:									
	Office/ Department Concerned	No. of copies required	Original locations of the existing trees to be affected	Drawings submitted to Office concerned directly?					
<b>V</b>	(a) District Lands Office (DLO) or Building Plan Unit (BPU) of LandsD	2	Pink Area	yes					
<b>V</b>	(b) Landscape Advisory Team (LAT) of LandsD	1	Pink Area	yes					
	(c) Leisure and Cultural Services Department (LCSD)	#	*Green/ Yellow Area to be handed back to LCSD	*yes/ no					
	(d) Agriculture Fisheries and Conservation Department (AFCD)	#	*Green-Hatched Black/ Brown/ Yellow Area other than (c) above	*yes/ no					
	(e) Highways Department (Note 3) (HyD)	#	Green Area to be handed back to HyD	*yes/ no					
	(f) Others (Please specify) #	#	Others (Please specifiy): #	*yes/ no					

#### **Section VI**

I hereby certify that the information in this submission is true and complete. I understand that if I provide any incorrect or incomplete information, a complaint may be lodged with the Landscape Architects Registration Board for investigation of the alleged misconduct or negligence pursuant to the Landscape Architects Registration Ordinance (Cap. 516).

I hereby acknowledge that the Director of Lands is not obliged to keep the content of this submission, its enclosures or any documents submitted in support of or in relation to this submission confidential, particularly in circumstances when the Director considers that disclosure is in the public interest and/or it would be reasonable for the Director to accede to requests from third parties with interest over the land for access to the same. This acknowledgement applies irrespective of whether the consent in the following paragraph is given or not.

#### Section VI (cont'd)

 $\checkmark$ 

Insofar as my consent is required under any statutory, regulatory or other provisions, I hereby consent and/or have procured consent from the relevant intellectual property rights owner that the Director of Lands may, after issue of the Certificate of Compliance, disclose the content of this submission, its enclosures or any documents submitted in support of or in relation to this submission to any third party including members of the public upon request of any such third party, media or otherwise, or on LandsD's own accord.

Signature

(signed by the Registered Landscape Architect (RLA) with valid registration chop affixed, if any)

Xylem

Regis

Name of the RLA

Xylem Leung

Registration No.

R082

Date

17/3/2020 (dd/mm/yyyy)

#### Notes:

- (1) This form shall be used for submission of the Tree Preservation and Removal Proposal for building development in private projects. Please read in conjunction with the *Guidance Notes on Tree Preservation and Removal Proposal for Building Development in Private Projects –Compliance of Tree Preservation Clause under Lease* issued by LandsD which are available on LandsD's website.
- (2) All references to "lease" in this Form shall include Conditions of Sale/Grant/Exchange, etc. as the case may be.
- (3) Landscape Division and Regional Office for trees outside lot boundary on streets maintained by HyD.
- # Fill in as appropriate
- \* Select as appropriate
- ☐ Tick as appropriate


#### Personal Information Collection Statement

#### PLEASE READ THE FOLLOWING BEFORE COMPLETING THIS FORM


- 1. The information relating to you provided in this submission, its enclosures and any documents submitted will be used by LandsD for the purposes of considering and processing your submission for approval of the TPRP for compliance of the tree preservation clause under lease and for other purposes related to such submission.
- 2. Your provision of all the information in this submission, its enclosures and any documents submitted is required for administering compliance with the lease conditions. Your submission will not be processed if you fail to provide all the information as requested.
- 3. The information you provided in this submission, its enclosures and any documents submitted may be disclosed to other government bureaux/departments for the purposes mentioned in paragraph 1 above. The above personal data may also be disclosed to any third party (whether individual, corporate body, members of the public or other organizations) whether in response to enquiry from members of the public, media or otherwise, or on LandsD's own accord.
- 4. You have the right of access and correction with respect to personal data as provided for in Sections 18 and 22 and Principle 6 of Schedule 1 to the Personal Data (Privacy) Ordinance (Cap. 486). Such right of access incudes the right to obtain a copy of the personal data provided in this submission on payment of the applicable charge.
- 5. Enquiries on the personal data collected, including the request for access to and correction of the data, should be addressed to the Departmental Personal Data Controlling Officer of Lands Department, 20/F., North Point Government Offices, 333 Java Road, North Point, Hong Kong.


Compens	satory T	ree Planting Schedule							
Item	Qty	Botanical Name	Chinese	Height	Spread	Spacing	Live-	DBH	Aggregated
			Name	(mm)	(mm)	(mm)	crown ratio	(mm)	DBH size for this lost tree
TREES									
SS	9	Sapium sebiferum	烏桕	3000	2500	3000	0.4	80	720
TD	13	Taxodium distichum	落羽松	5000	2500	3000	0.4	100	1300
TM	22	Terminalia mantaly	細葉欖仁	6000	3000	3000	0.4	110	2420
TMT	17	Terminalia mantaly cv. 'Tricolour'	錦葉欖仁	5000	3000	3000	0.4	100	1700
TC	14	Terminalia catappa	欖仁樹	5000	2500	3000	0.4	100	1400
TOTAL	75								7540

NOTE: A MIN. 1.2M SOIL DEPTH EXCLUDING DRAINAGE LAYER WILL BE PROVIDED FOR

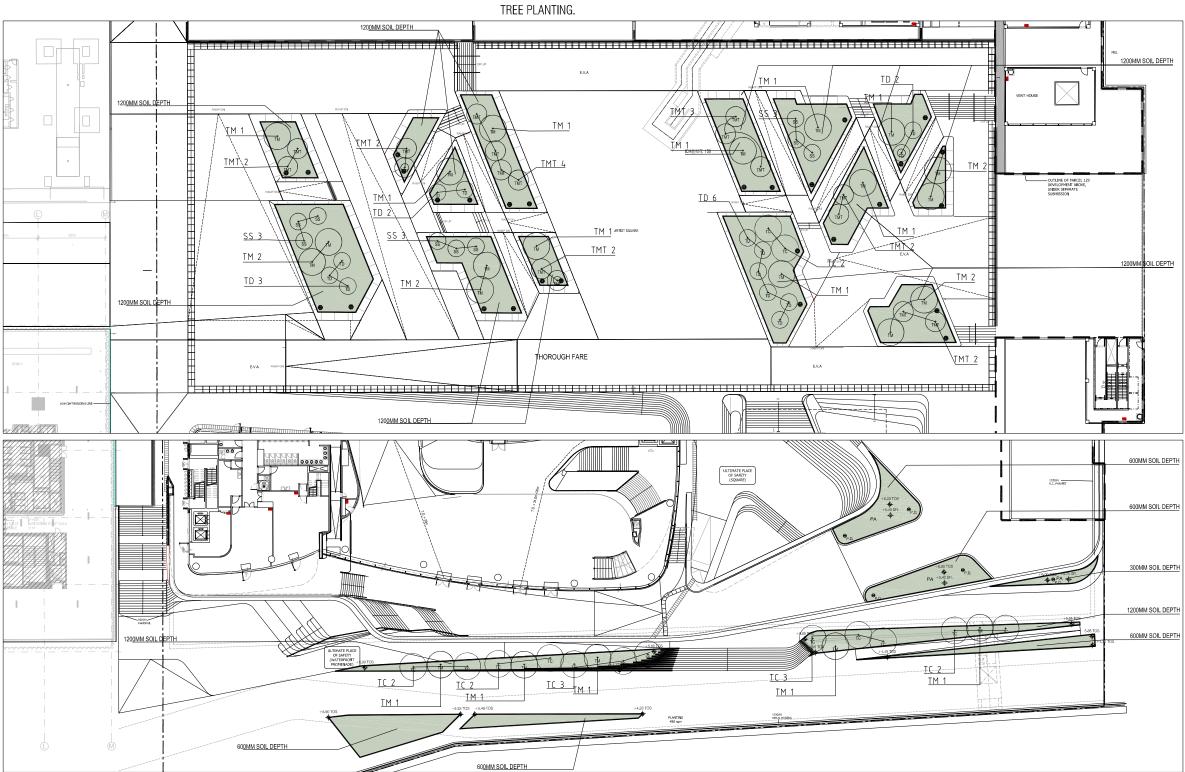



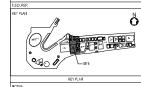


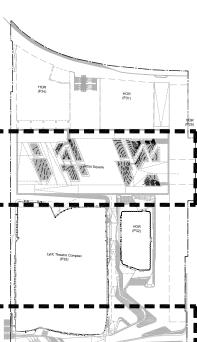

KEY PLAN

1 KEY PLAN

2001 NTS

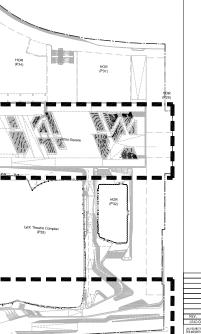

#### UNSTUDIO/AD+RG

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AECOM 138 Shatin Rural Co

# THE SPACE FACTORY MARSHALL DAY Sulte 1201, James 2 The C 25 Canton Phon IRS 16

MVA LWK**#** 


THE DESIGN AND CONSTRUCTION OF THE LYRIC THEATRE OF THE WEST KOWLOON CULTURAL DISTRICT


#### COMPENSATORY PLANTING PLAN


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CHECKED	W	DATE	03 - 2013
APPROVED	NL	DATE	03 - 2013
PRODUCED BY	MS/EP	DATE	03 - 2013
AUTHOR			LWKL
DISCIPLINE			LANDSCAPE
PHASE		L2 C	ONSTRUCTION
DRAWING NO.			REV.
CP <b>-</b> 01			А
CAD REF NAME:			CP-01.dwg
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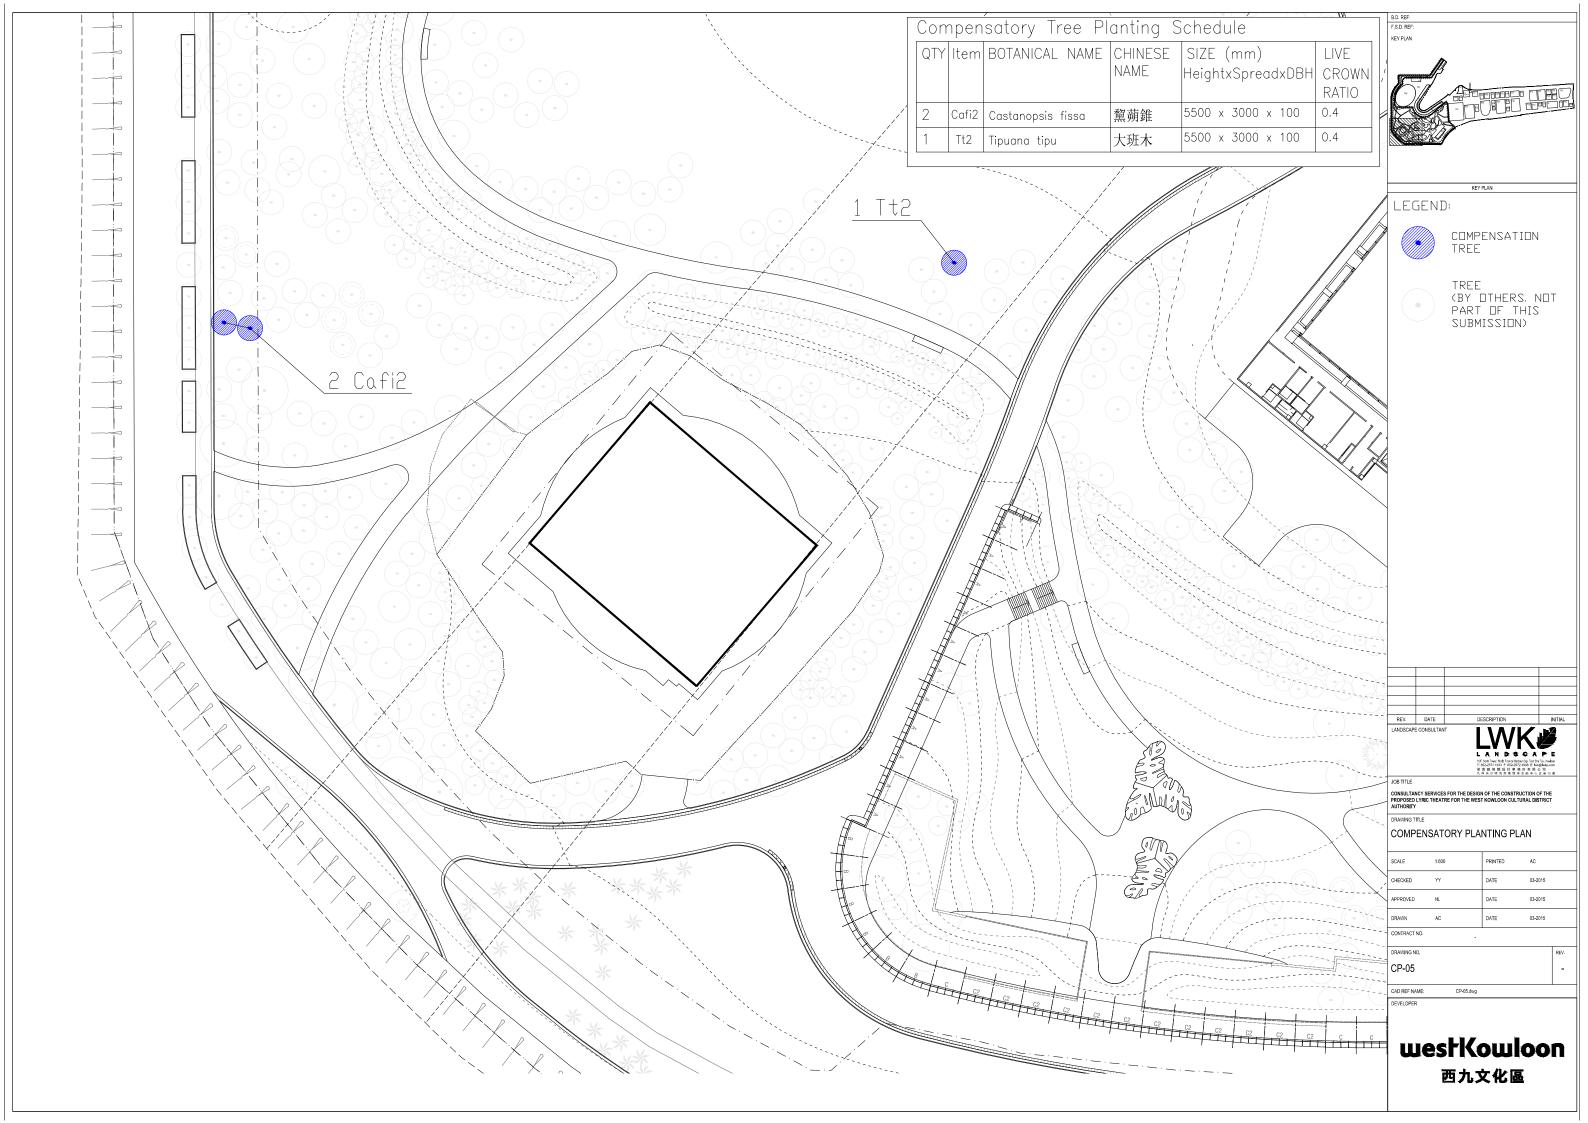
westKowloon

西九文化區



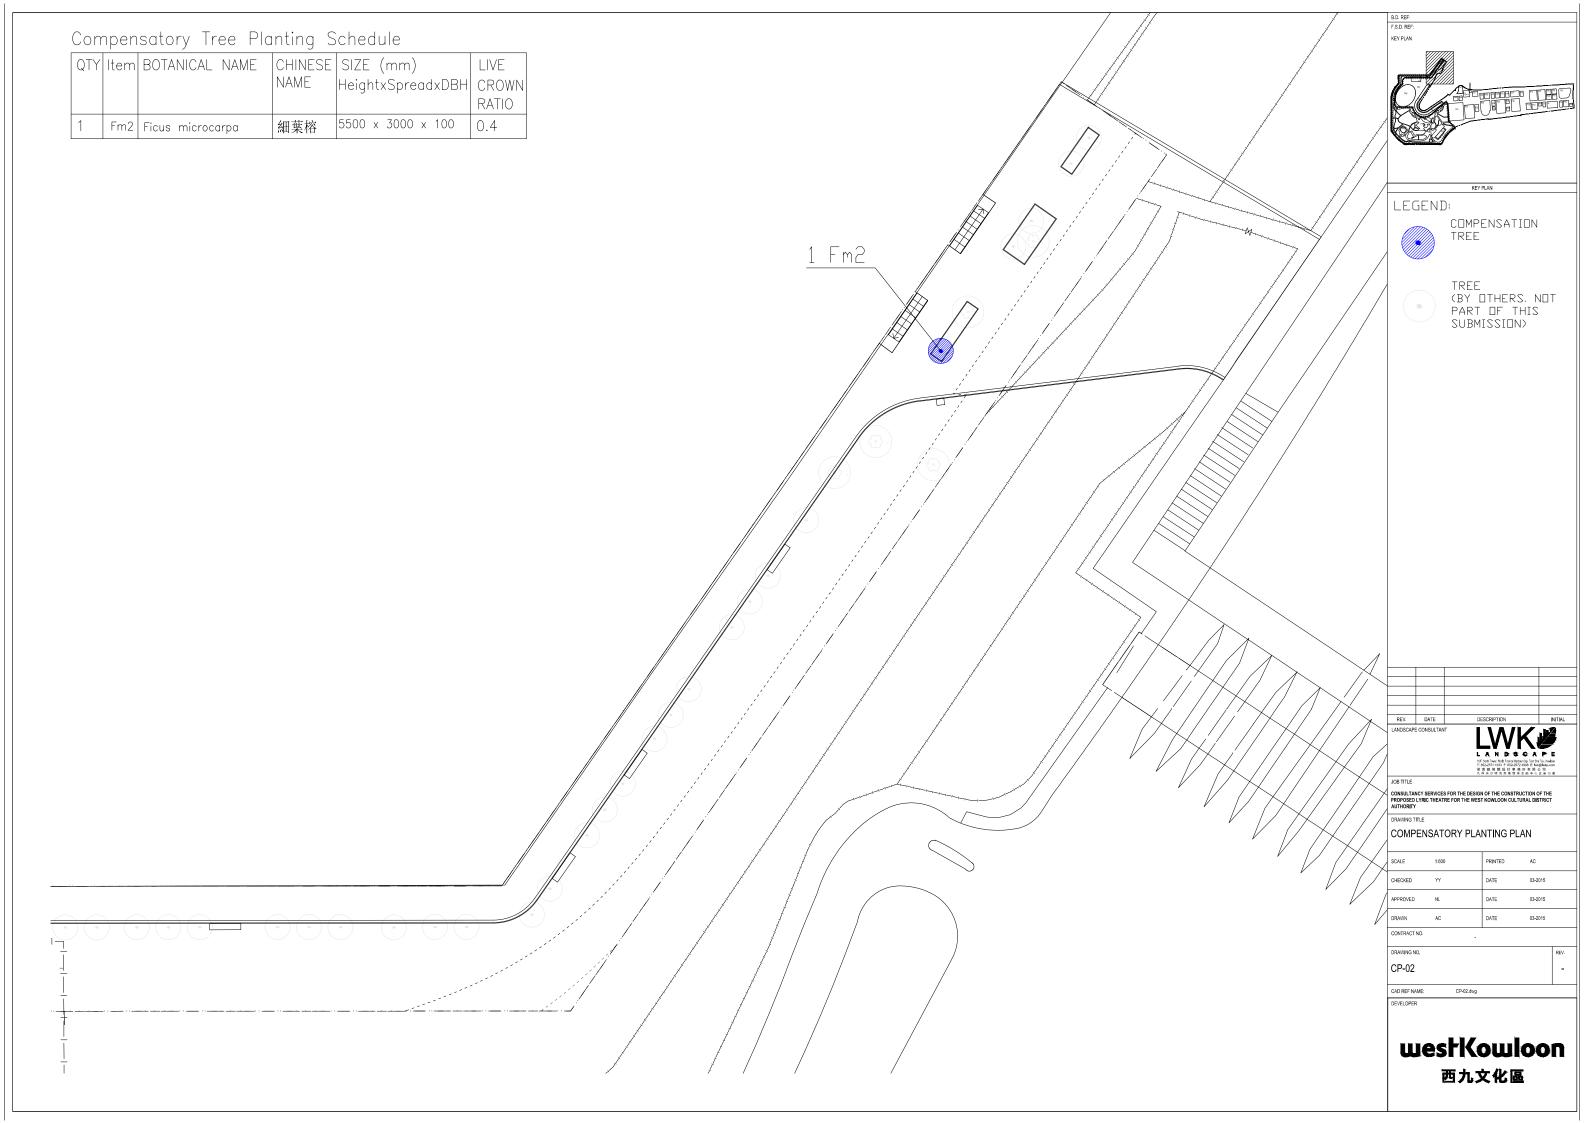


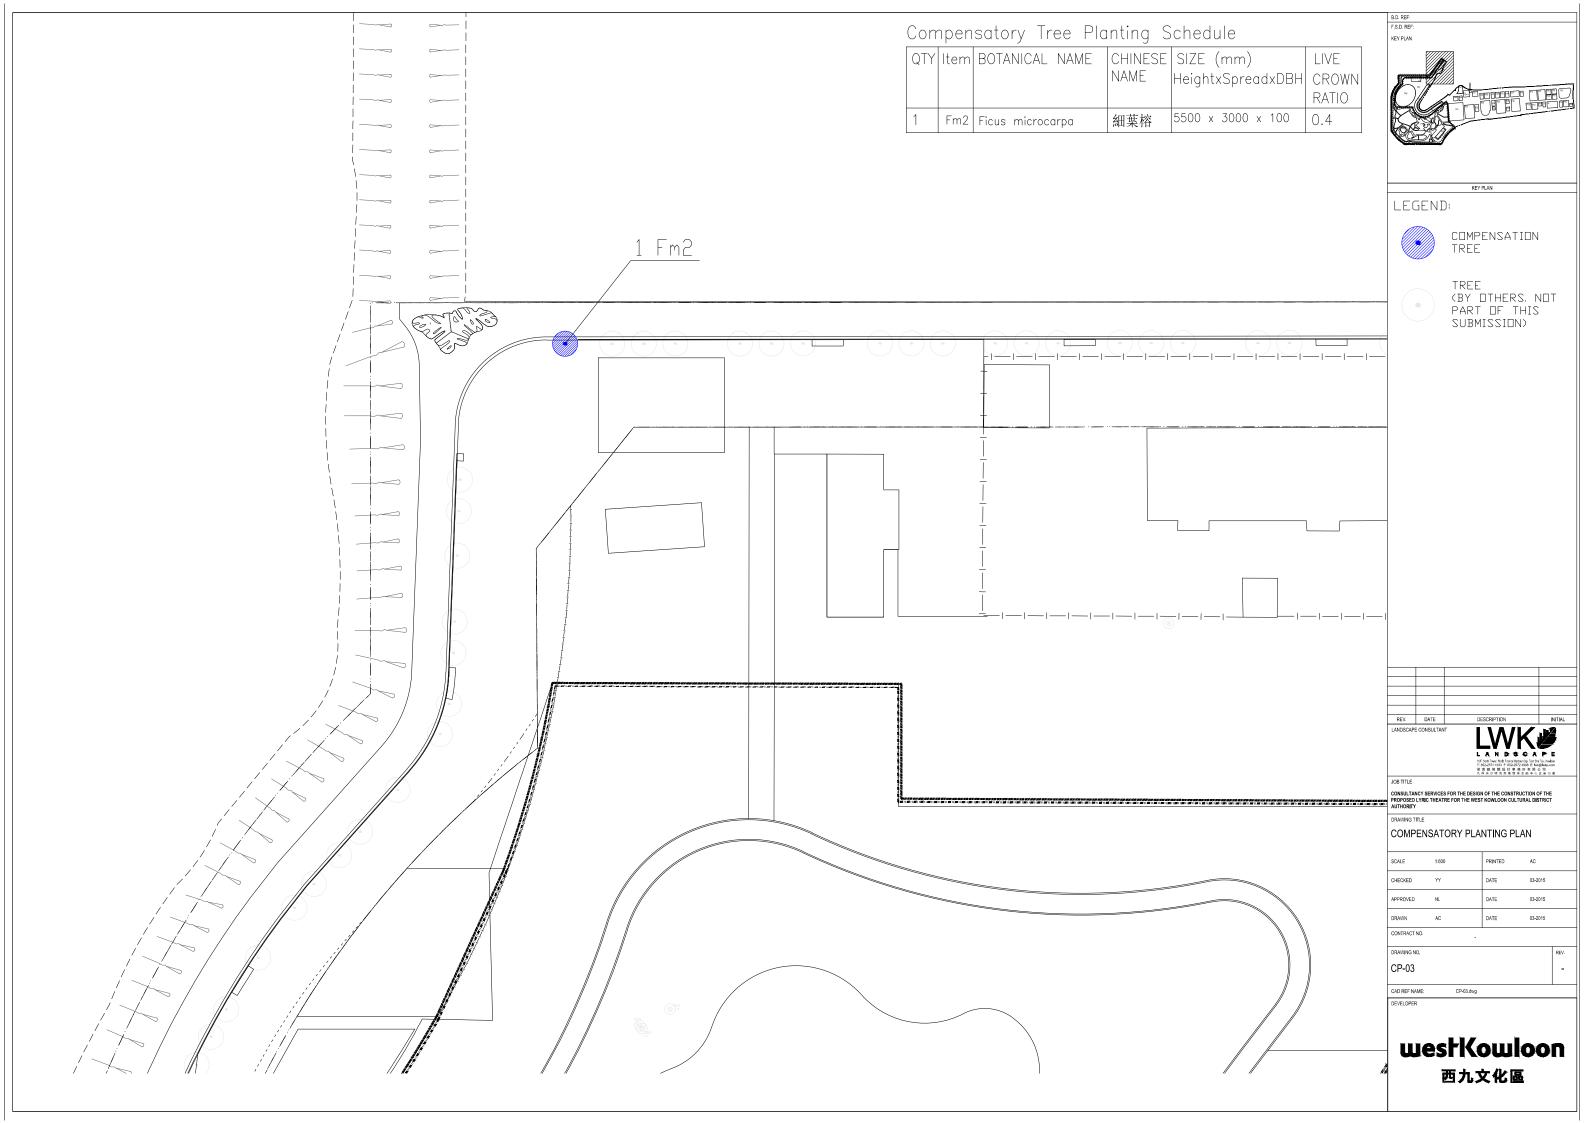


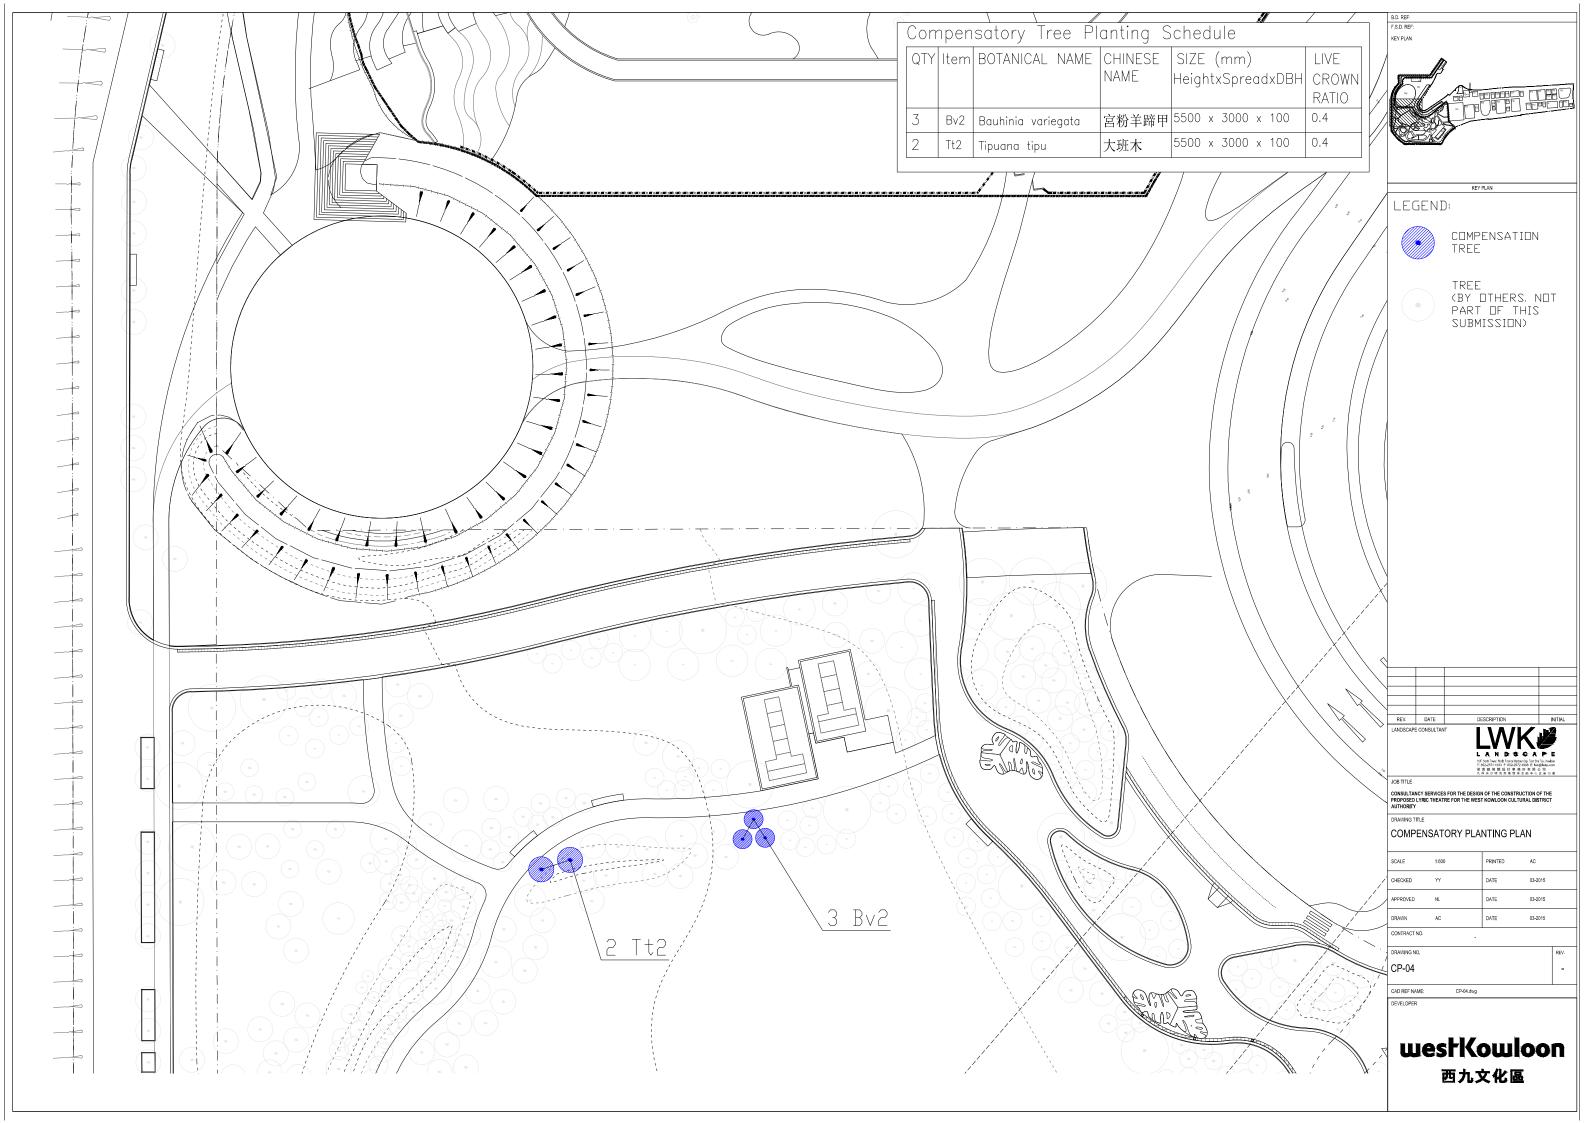


**Appendix D – Planting Plan & Planting Schedule of Lyric Theatre** 



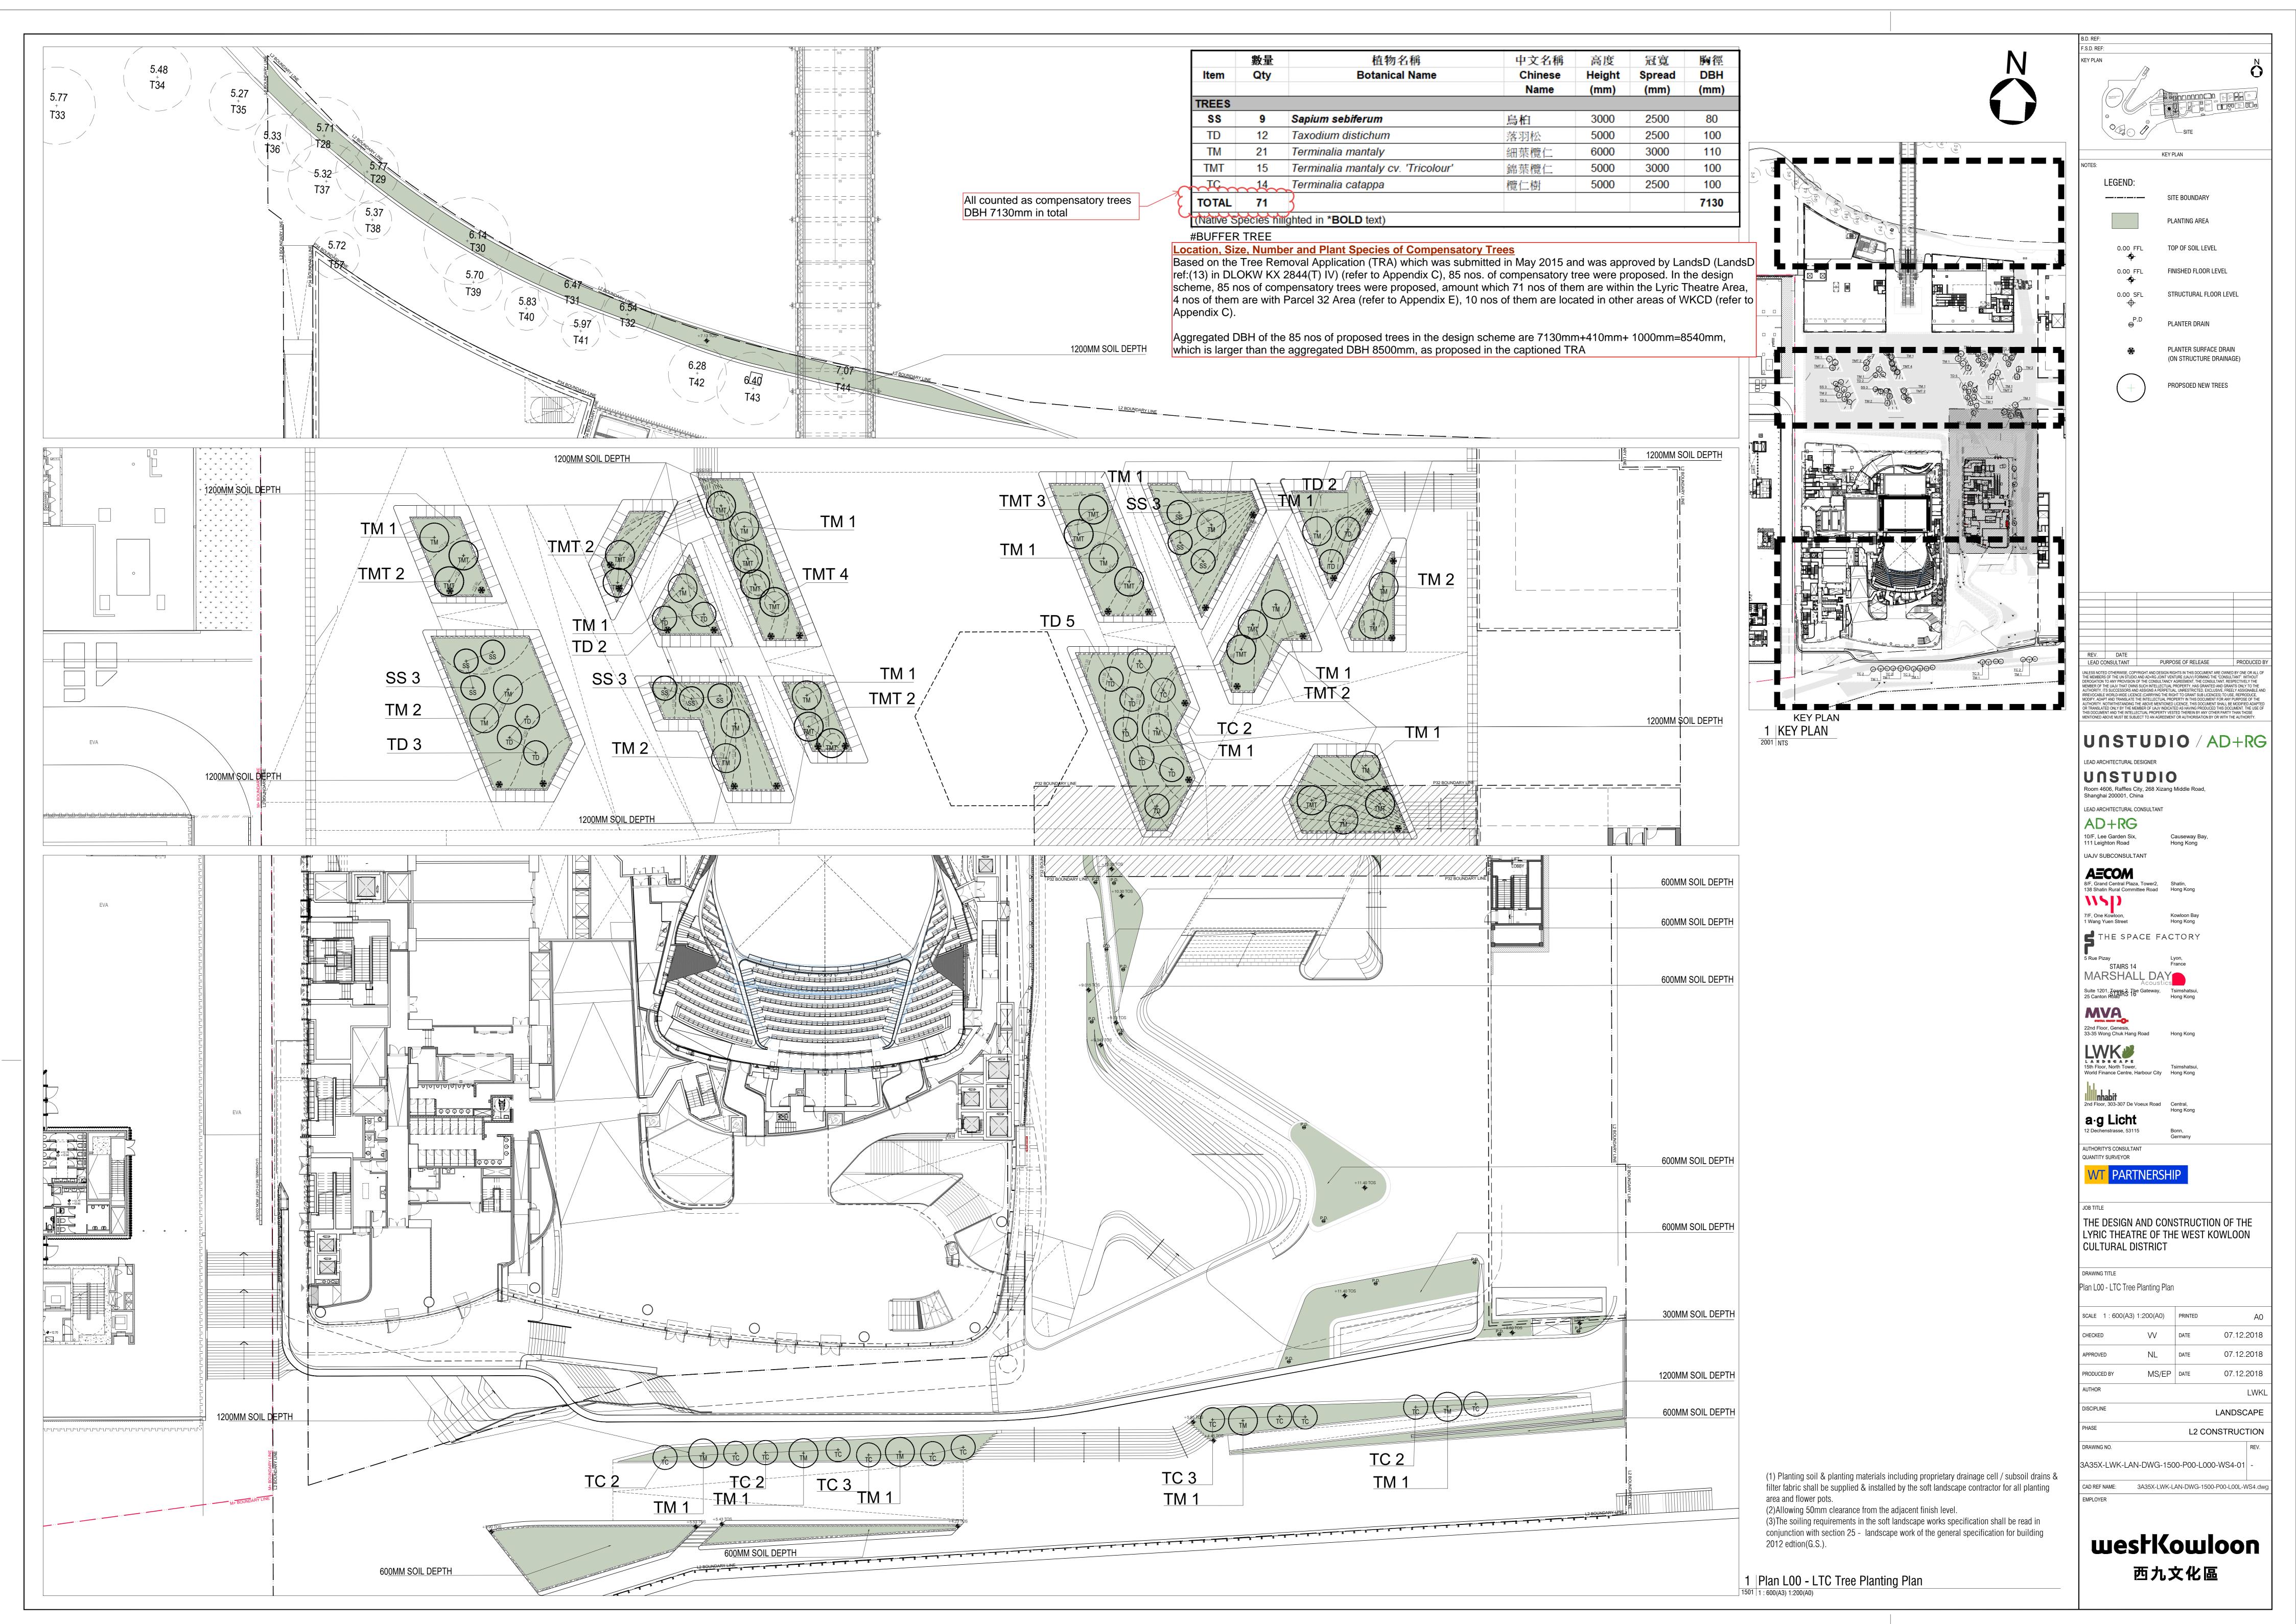

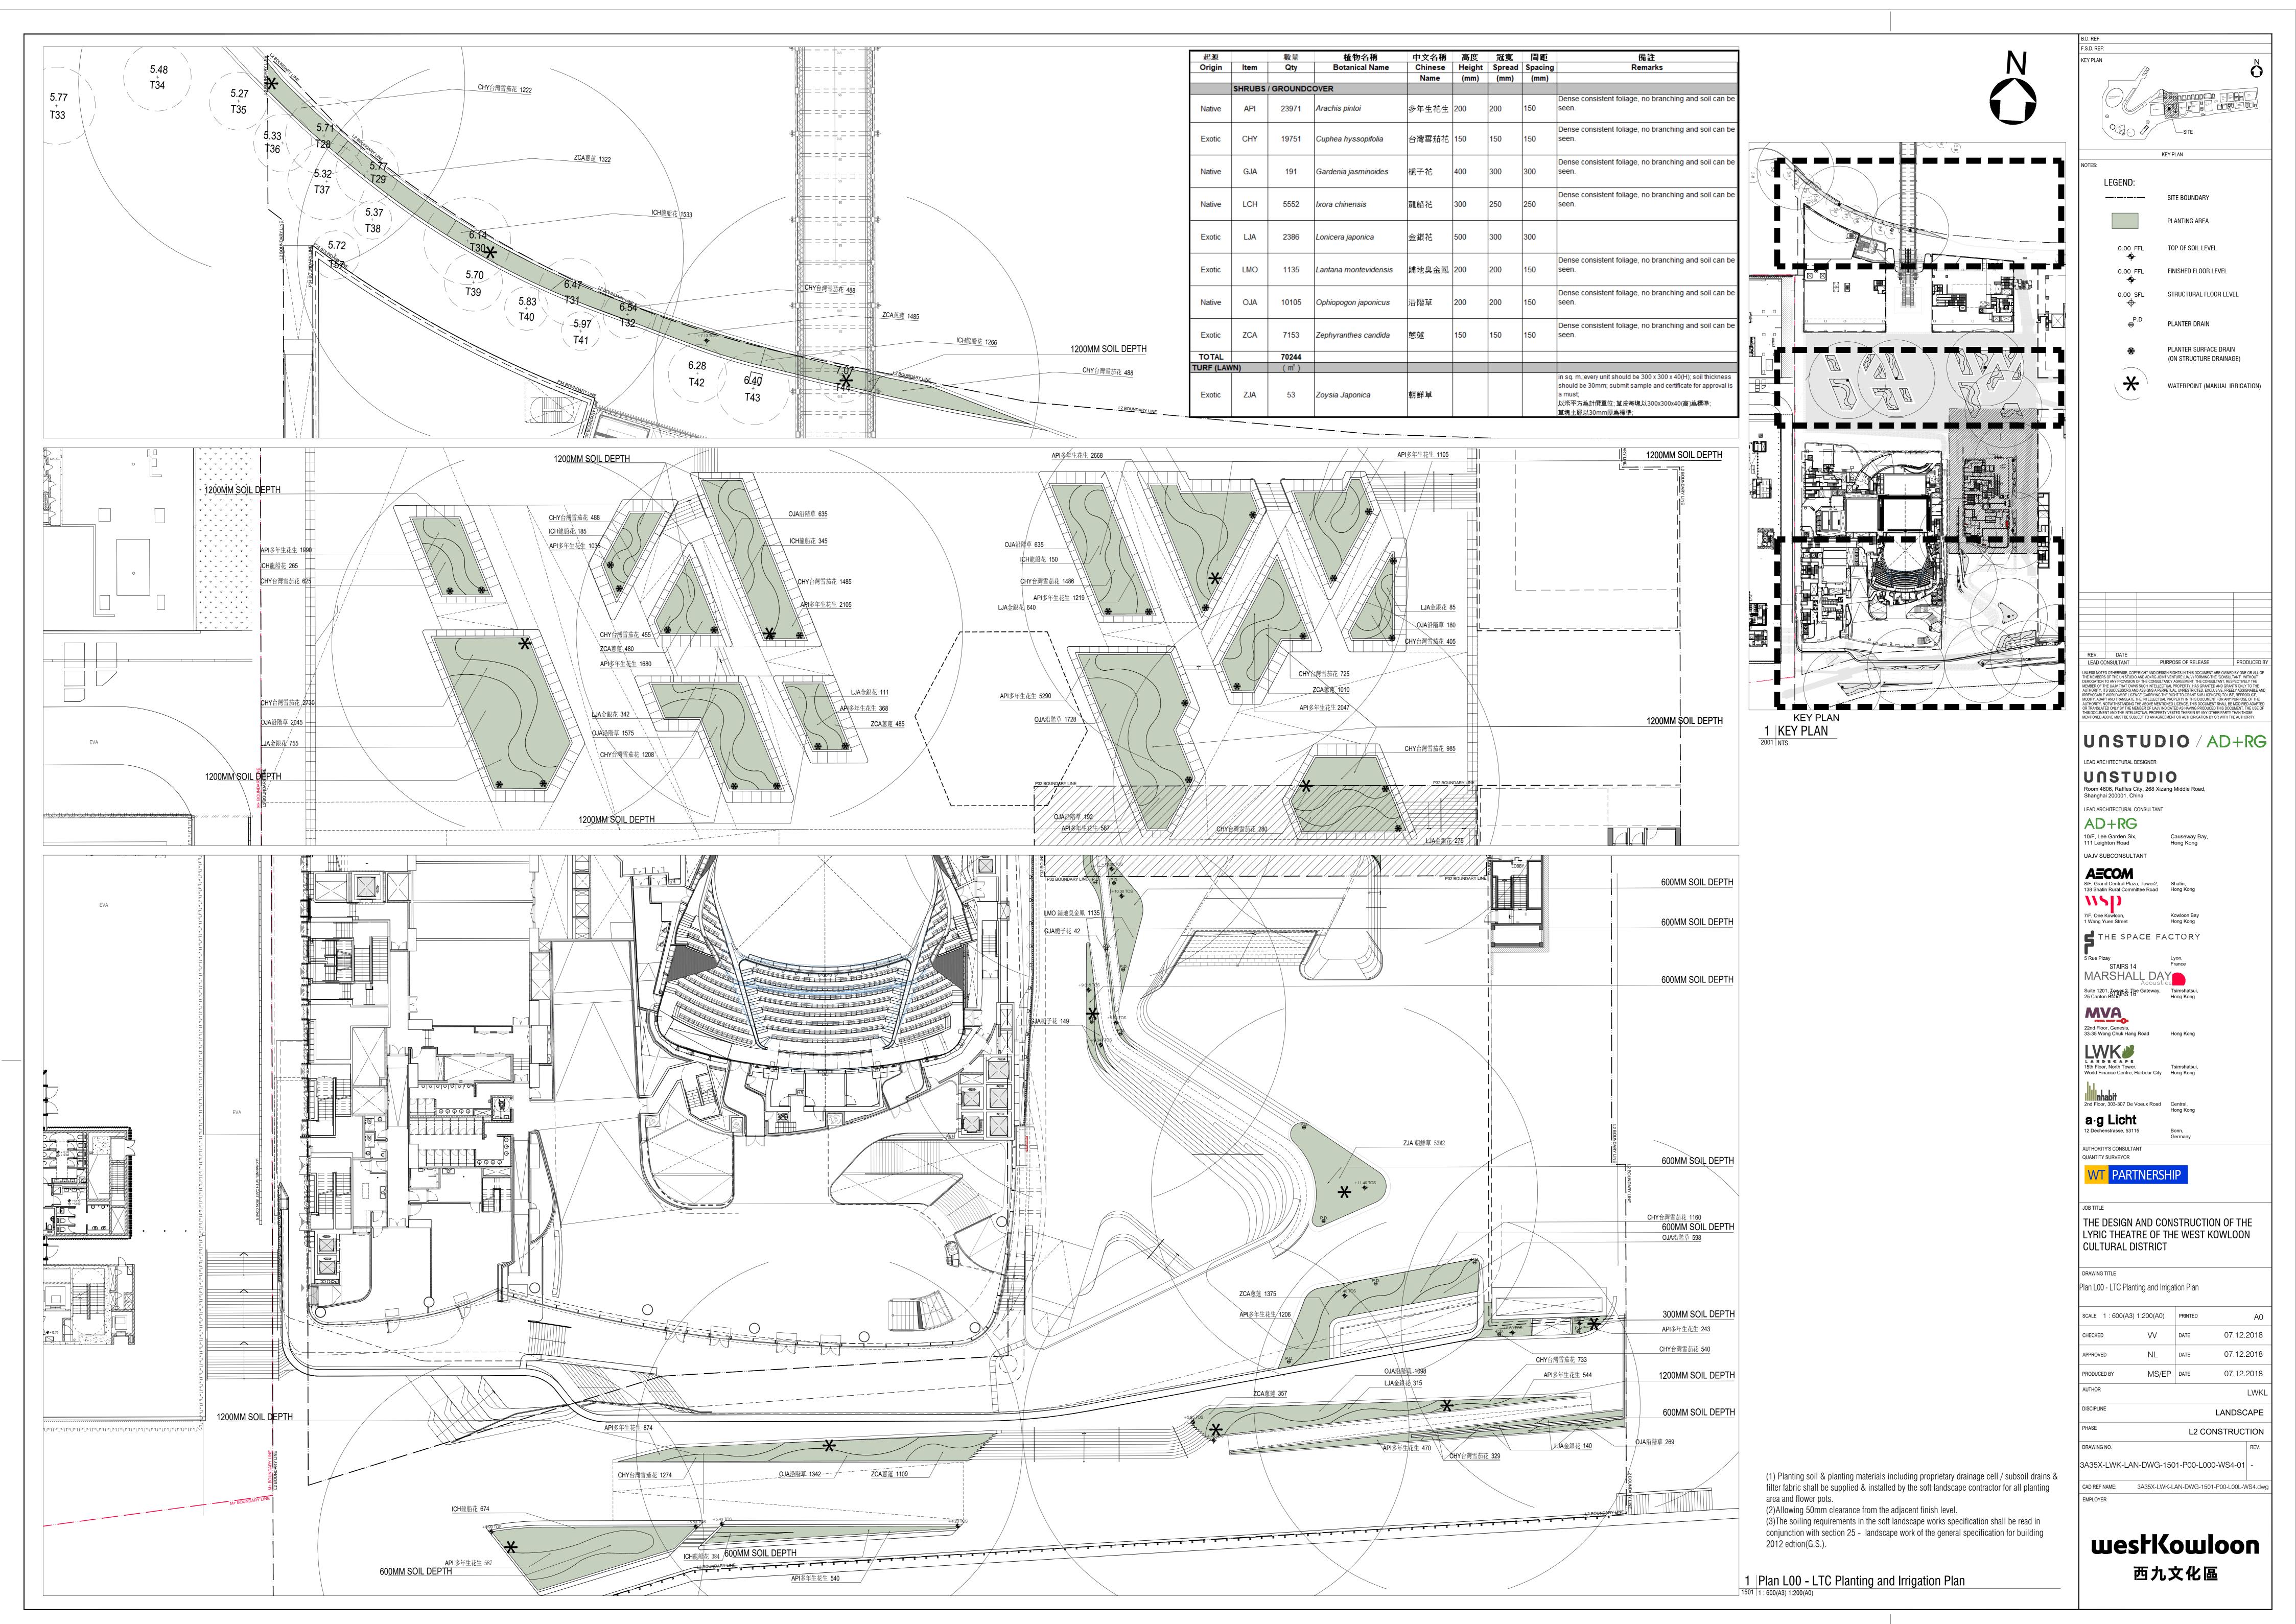



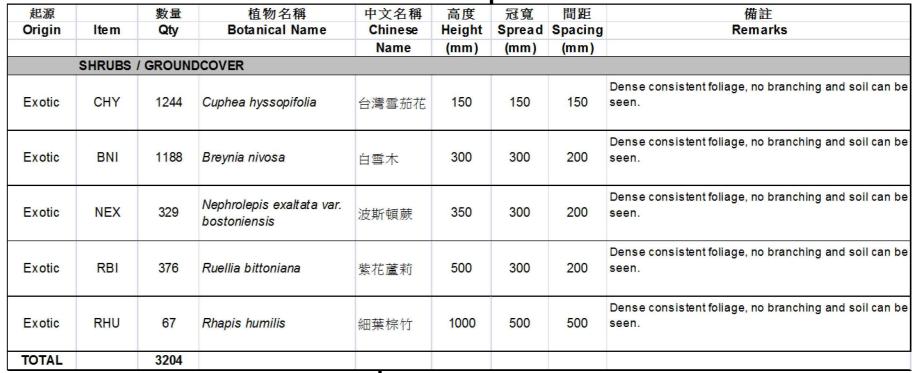

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—---- SITE BOUNDARY

0.00 FFL TOP OF SOIL LEVEL

0.00 FFL FINISHED FLOOR LEVEL

0.00 SFL STRUCTURAL FLOOR LEVEL

PLANTER DRAIN

WATERPOINT (MANUAL IRRIGATION)

UNSTUDIO / AD+RG

LEAD ARCHITECTURAL DESIGNER UNSTUDIO

Room 4606, Raffles City, 268 Xizang Middle Road, LEAD ARCHITECTURAL CONSULTANT

AD+RG 10/F, Lee Garden Six, 111 Leighton Road UAJV SUBCONSULTANT

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MARSHALL DAY
Acoustics

22nd Floor, Genesis, 33-35 Wong Chuk Hang Road Hong Kong

LANDSEAPE
15th Floor, North Tower,
World Finance Centre, Harbour City

Tsimshatsui,
Hong Kong

2nd Floor, 303-307 De Voeux Road Central,
Hong Kong

12 Dechenstrasse, 53115 AUTHORITY'S CONSULTANT QUANTITY SURVEYOR

THE DESIGN AND CONSTRUCTION OF THE LYRIC THEATRE OF THE WEST KOWLOON CULTURAL DISTRICT

DRAWING TITLE Plan L05 - LTC Planting and Irrigation Plan

SCALE 1:600(A3) 1:200(A0) PRINTED 07.12.2018 07.12.2018 07.12.2018 PRODUCED BY LANDSCAPE L2 CONSTRUCTION DRAWING NO.

3A35X-LWK-LAN-DWG-1502-P00-L005-WS4-01

CAD REF NAME: 3A35X-LWK-LAN-DWG-1502-P00-L005-WS4.dwg


(1) Planting soil & planting materials including proprietary drainage cell / subsoil drains & filter fabric shall be supplied & installed by the soft landscape contractor for all planting


(3)The soiling requirements in the soft landscape works specification shall be read in conjunction with section 25 - landscape work of the general specification for building


(2)Allowing 50mm clearance from the adjacent finish level.

area and flower pots.

2012 edtion(G.S.).

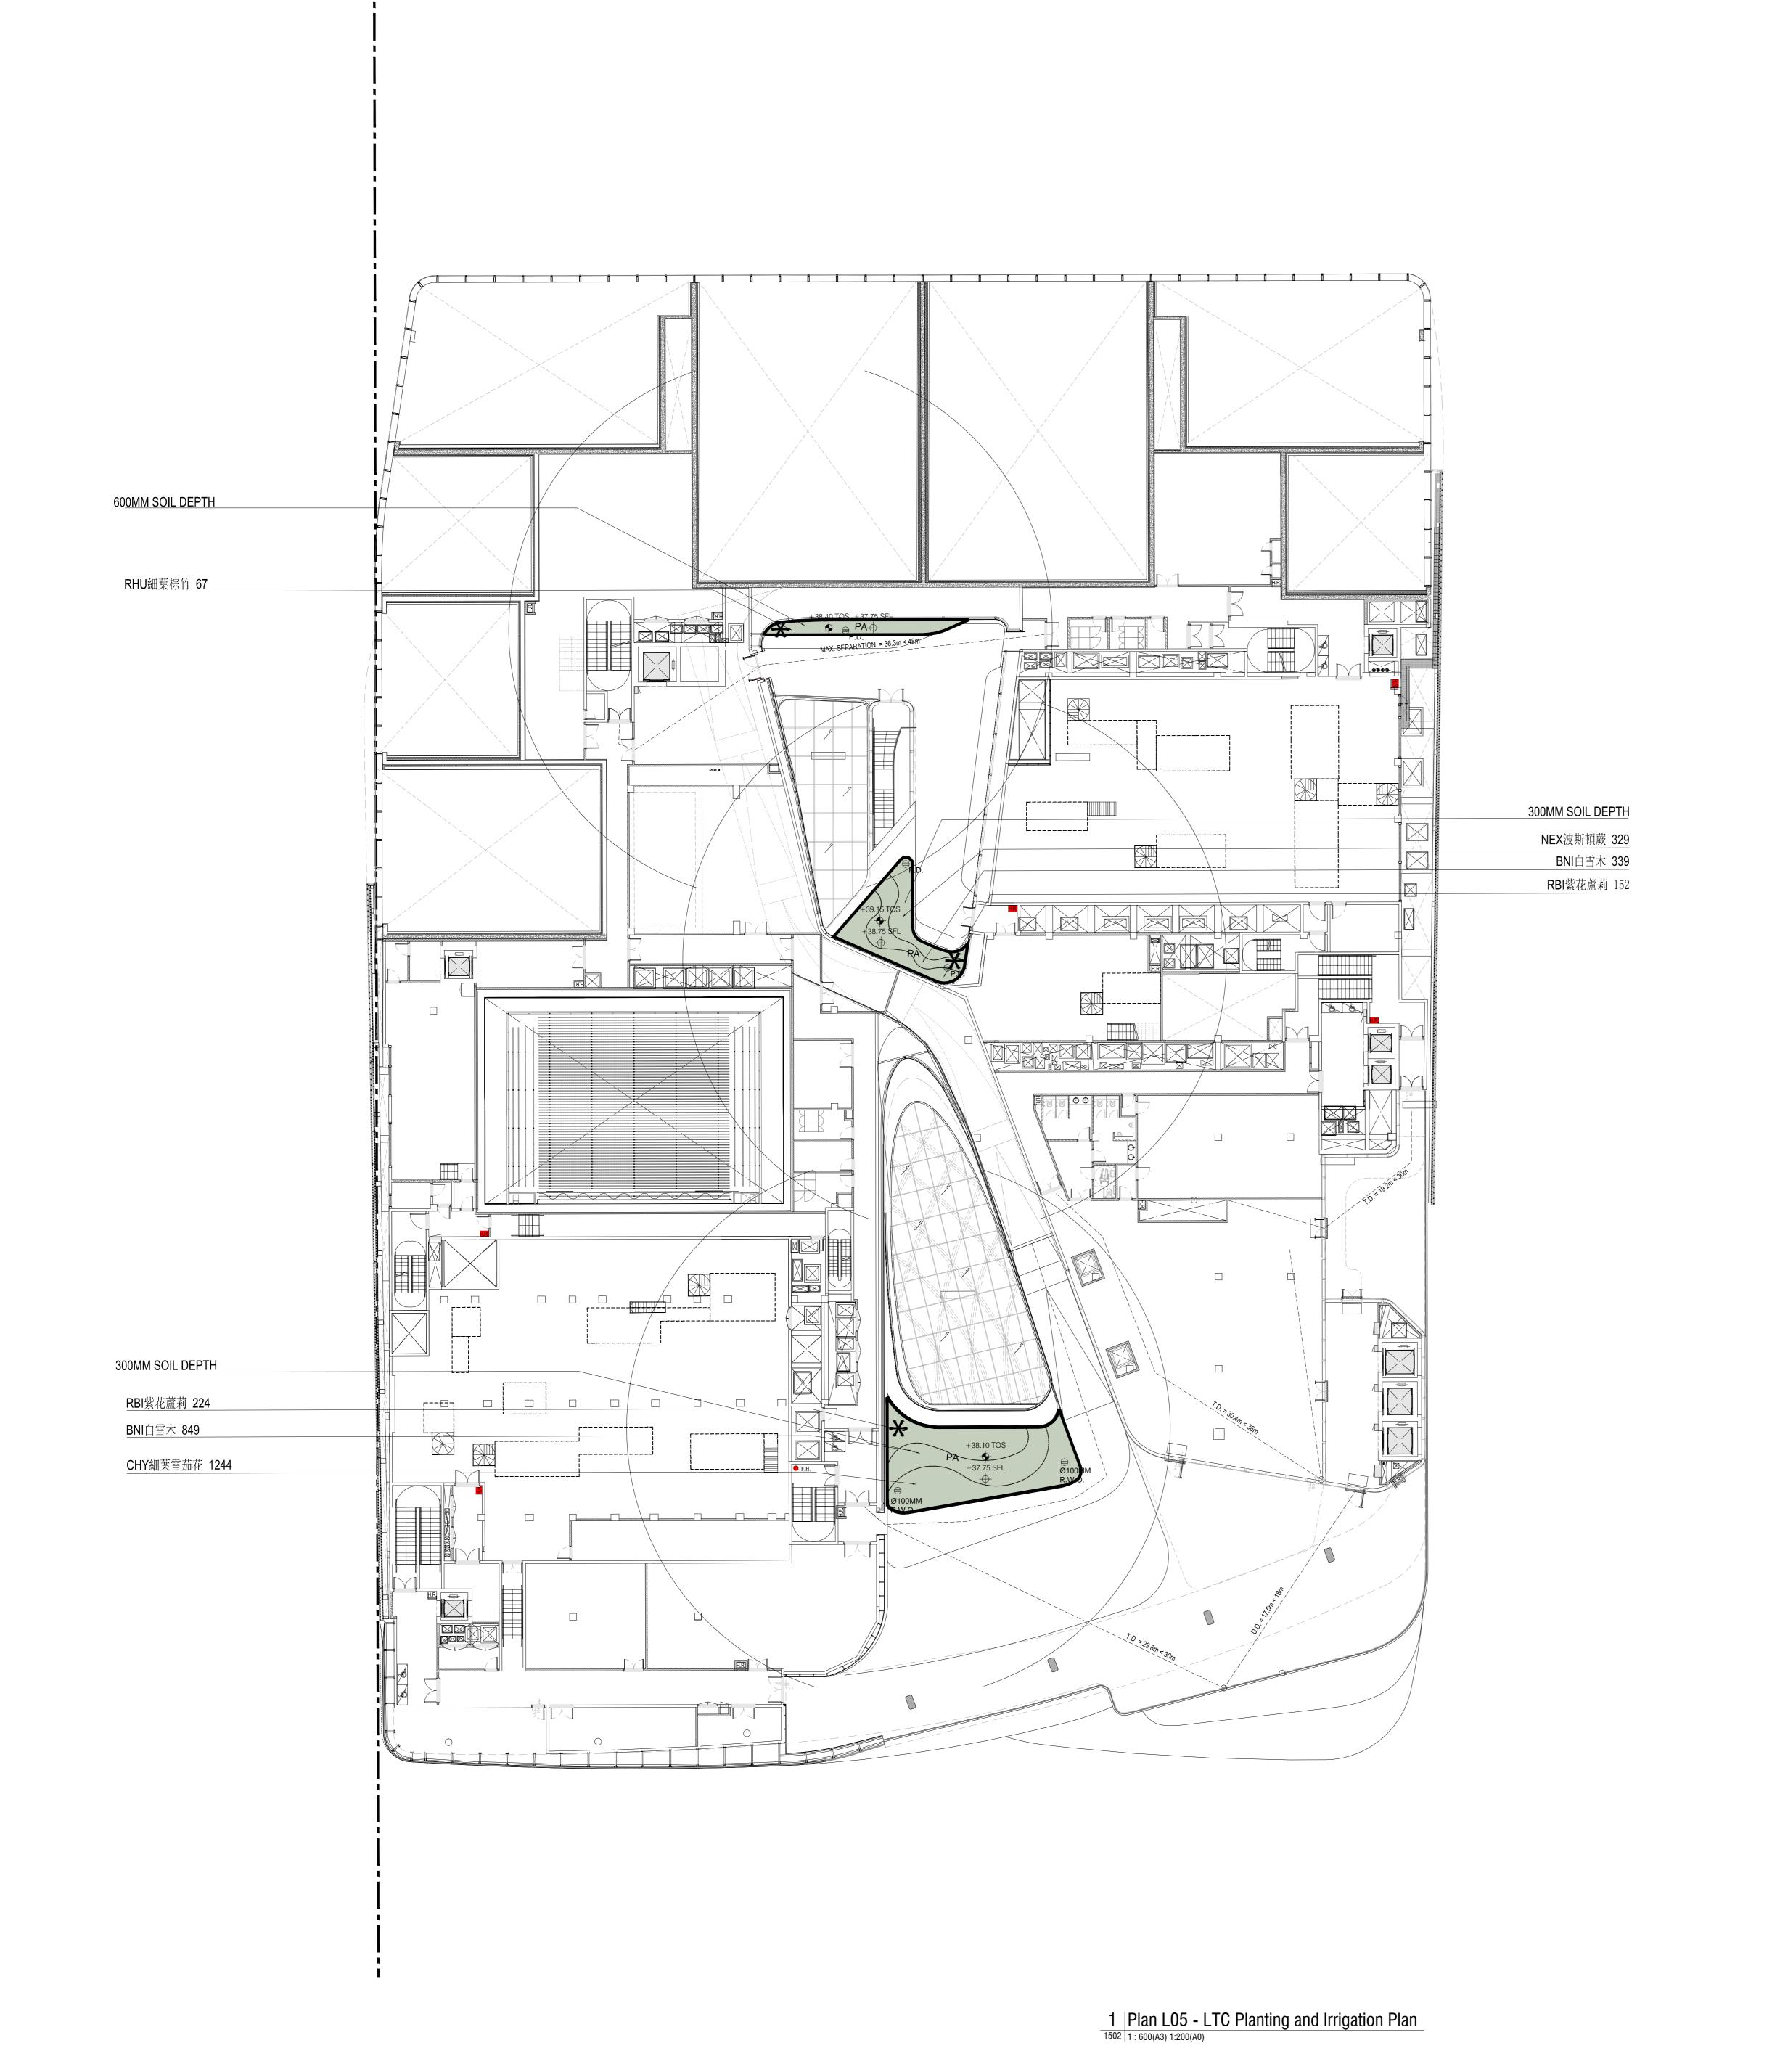

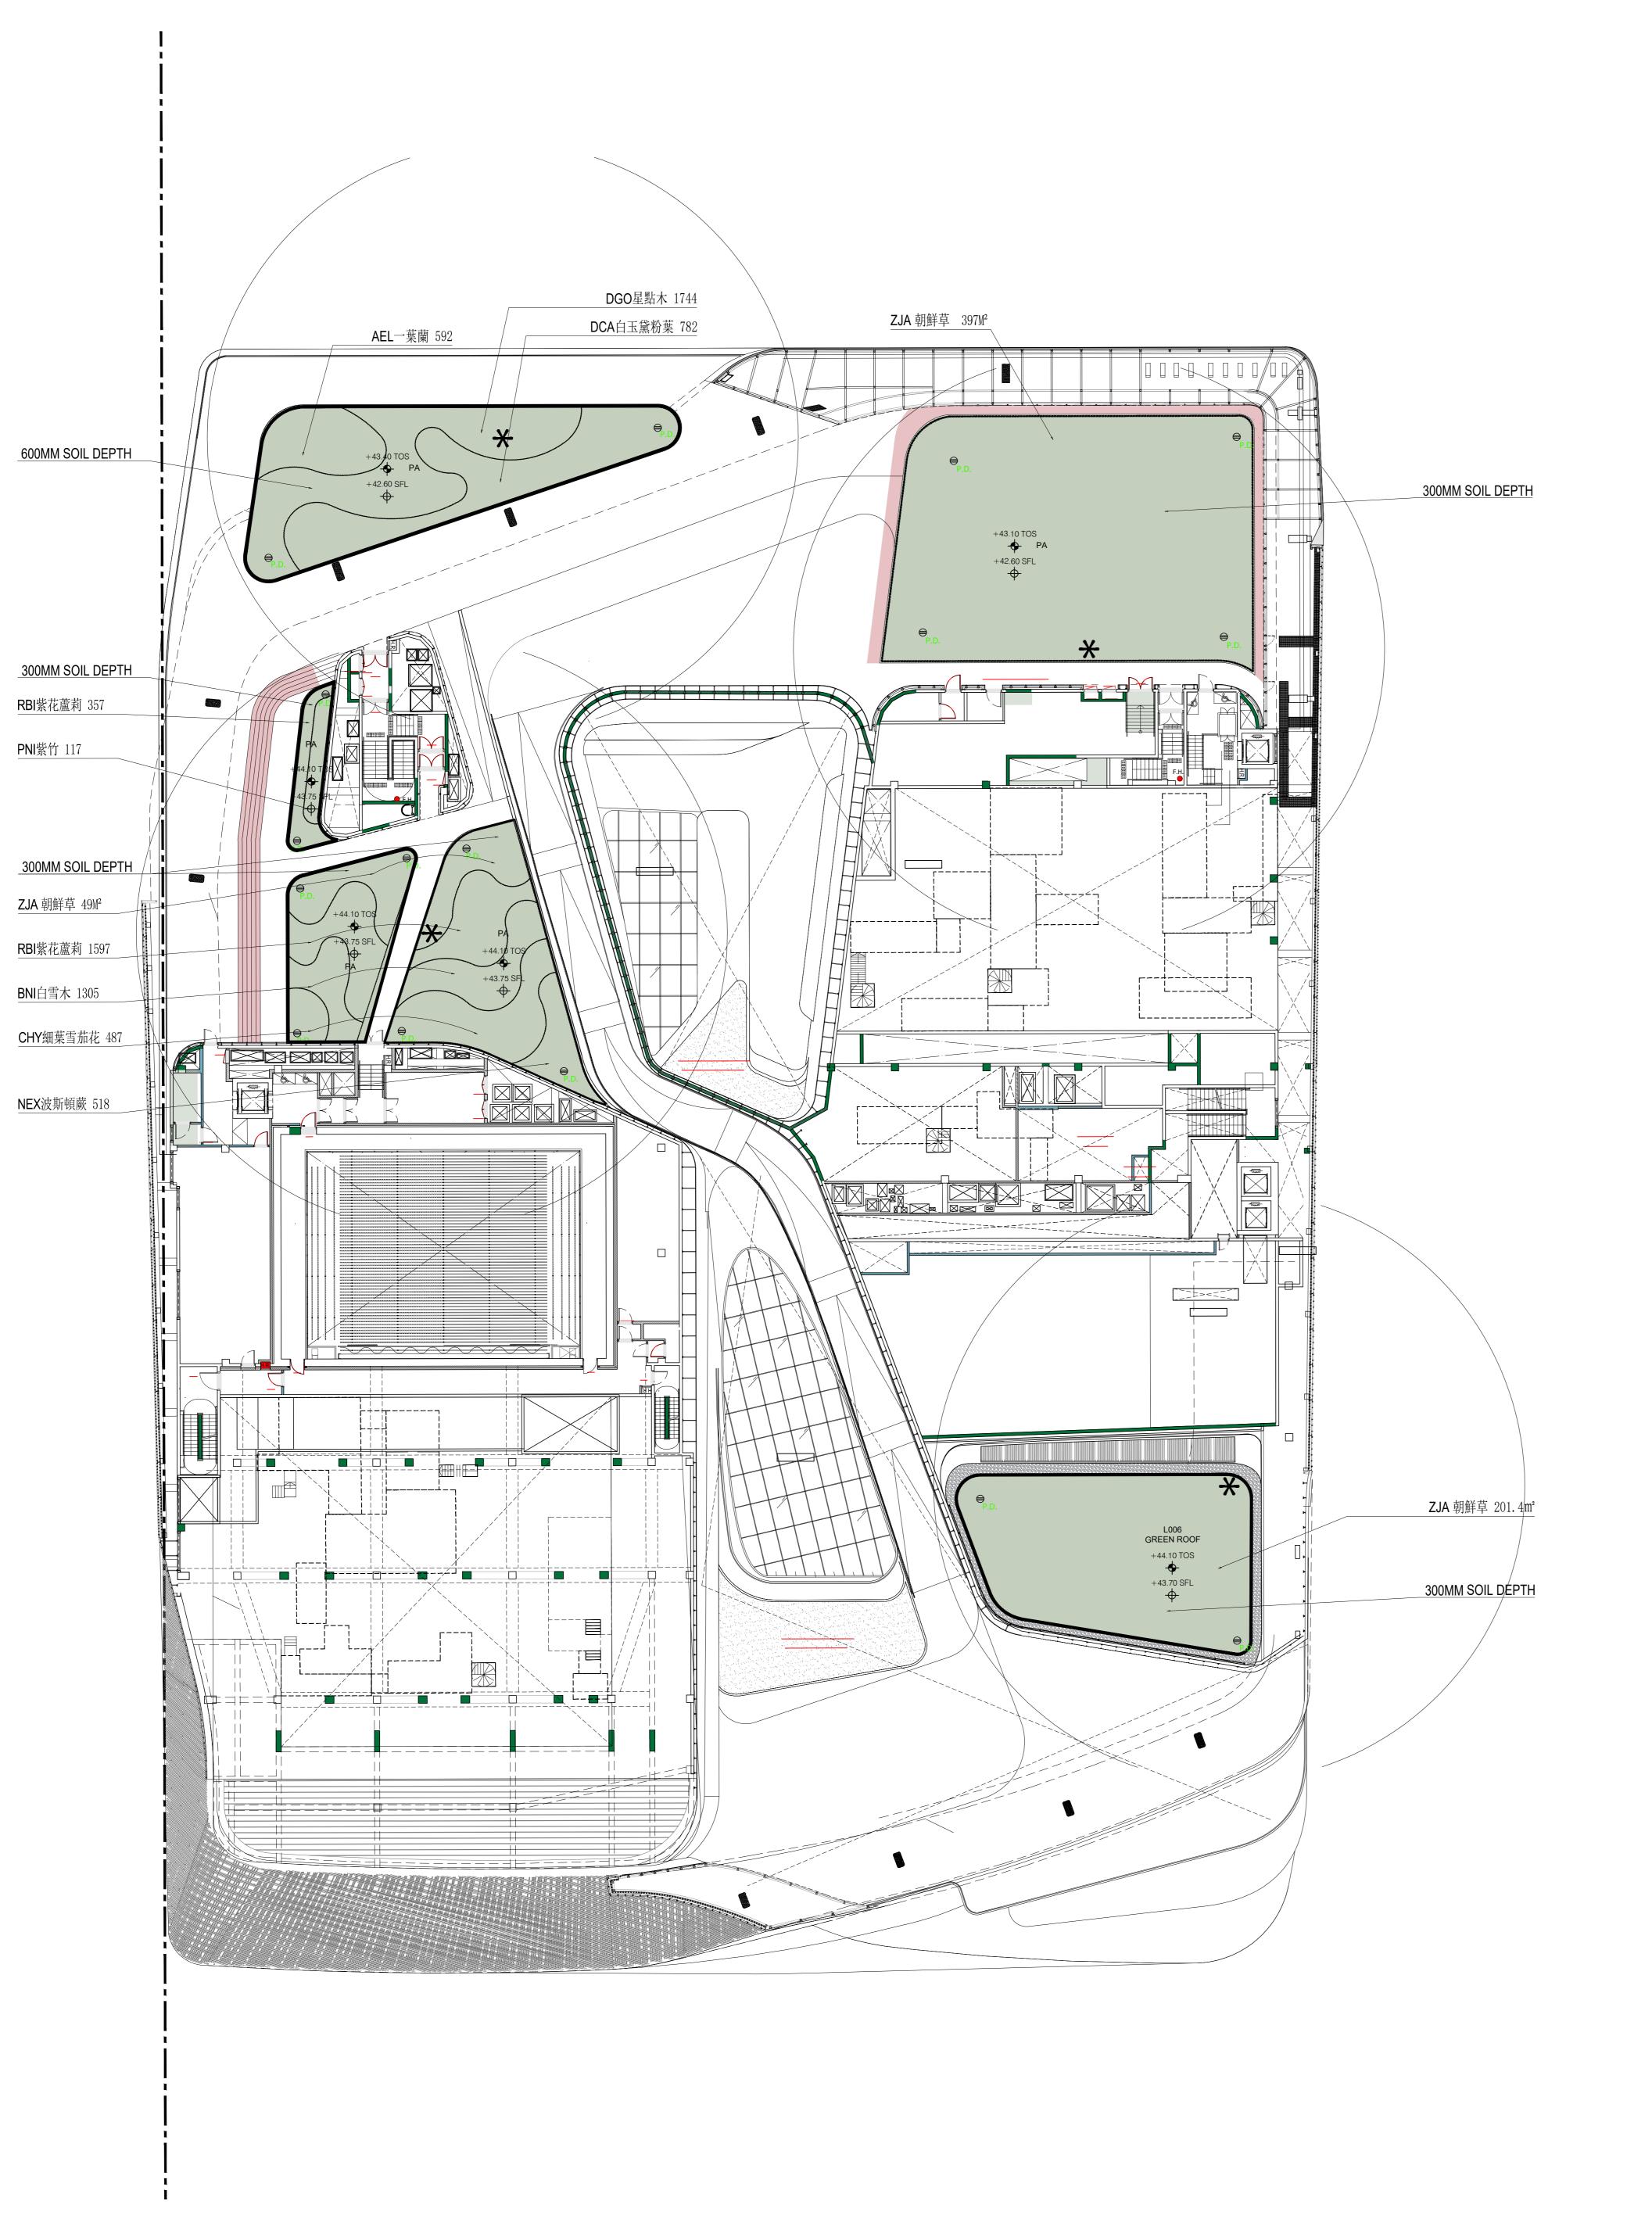

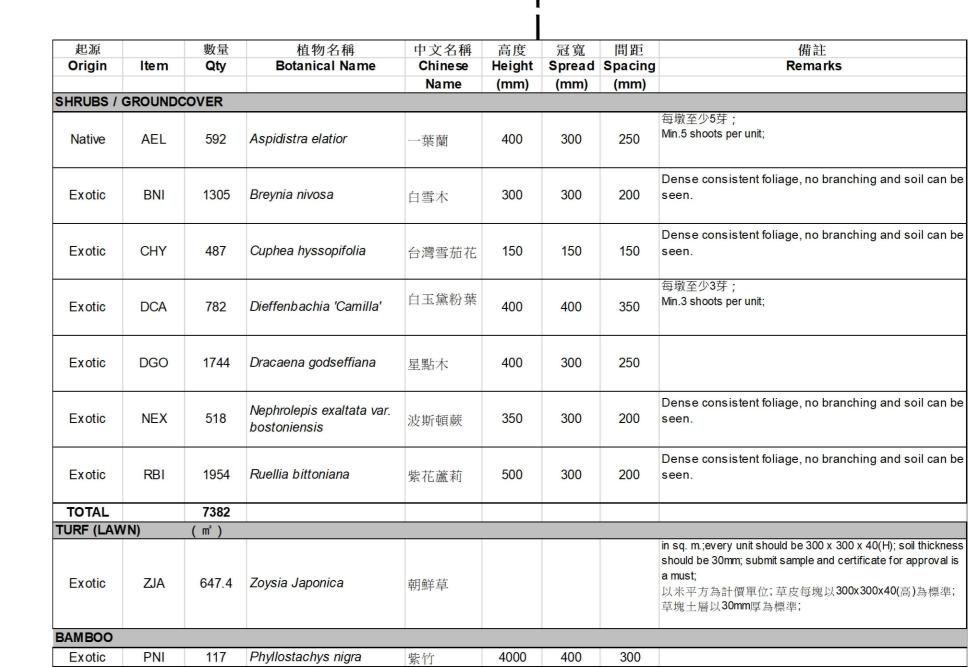

area and flower pots.

2012 edtion(G.S.).

(2) Allowing 50mm clearance from the adjacent finish level.

(3)The soiling requirements in the soft landscape works specification shall be read in conjunction with section 25 - landscape work of the general specification for building

—---- SITE BOUNDARY 0.00 FFL TOP OF SOIL LEVEL 0.00 FFL FINISHED FLOOR LEVEL 0.00 SFL STRUCTURAL FLOOR LEVEL PLANTER DRAIN WATERPOINT (MANUAL IRRIGATION) LEAD CONSULTANT UNLESS NOTED OTHERWISE, COPYRIGHT AND DESIGN RIGHTS IN THIS DOCUMENT ARE OWNED BY ONE OR ALL OF THE MEMBERS OF THE UN STUDIO AND AD-RG JOINT VENTURE (UAJV) FORMING THE "CONSULTANT". WITHOUT DEROGATION TO ANY PROVISION OF THE CONSULTANCY AGREEMENT, THE CONSULTANT, RESPECTIVELY THE MEMBER OF THE UAJV THAT OWNS SUCH INTELLECTUAL PROPERTY, HAS GRANTED AND GRANTS ONLY TO THE AUTHORITY, ITS SUCCESSORS AND ASSIGNS A PERPETUAL, UNRESTRICTED, EXCLUSIVE, FREELY ASSIGNABLE AND IRREVOCABLE WORLD-WIDE LICENCE (CARRYING THE RIGHT TO GRANT SUB LICENCES) TO USE, REPRODUCE, MODIFY, ADAPT AND TRANSLATE THE INTELLECTUAL PROPERTY IN THIS DOCUMENT FOR ANY PURPOSE OF THE AUTHORITY, NOTWITHSTANDING THE ABOVE MENTIONED LICENCE, THIS DOCUMENT SHALL BE MODIFIED ADAPTED OR TRANSLATED ONLY BY THE MEMBER OF UAJV INDICATED AS HAVING PRODUCED THIS DOCUMENT. THE USE OF THIS DOCUMENT AND THE INTELLECTUAL PROPERTY VESTED THEREIN BY ANY OTHER PARTY THAN THOSE MENTIONED ABOVE MUST BE SUBJECT TO AN AGREEMENT OR AUTHORISATION BY OR WITH THE AUTHORITY. UNSTUDIO / AD+RG LEAD ARCHITECTURAL DESIGNER UNSTUDIO
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138 Shatin Rural Committee Road Hong Kong THE SPACE FACTORY STAIRS 14 22nd Floor, Genesis, 33-35 Wong Chuk Hang Road World Finance Centre, Harbour City Hong Kong 2nd Floor, 303-307 De Voeux Road Central, Hong Kong 12 Dechenstrasse, 53115 AUTHORITY'S CONSULTANT QUANTITY SURVEYOR THE DESIGN AND CONSTRUCTION OF THE LYRIC THEATRE OF THE WEST KOWLOON
CULTURAL DISTRICT Plan L06R - LTC Planting and Irrigation Plan SCALE 1:600(A3) 1:200(A0) PRINTED MS/EP DATE

LANDSCAPE L2 CONSTRUCTION

3A35X-LWK-LAN-DWG-1503-P00-L006-WS4-01

CAD REF NAME: 3A35X-LWK-LAN-DWG-1503-P00-L006-WS4.dwg (1) Planting soil & planting materials including proprietary drainage cell / subsoil drains & filter fabric shall be supplied & installed by the soft landscape contractor for all planting



超源 製量 植物名稱 中文名稱 高度 冠寬 間距 備註

Origin Item Qty Botanical Name Chinese Height Spread Spacing Remarks

Name (mm) (mm) (mm)

SHRUBS / GROUNDCOVER

Native API 27975 Arachis pintoi 多年生花生 200 200 150 Dense consistent foliage, no branching and soil can be seen.

API多年生花生 27975 \300MM SOIL DEPTH EXTRUDED ALUMINUM
FINS
ON SUB-STRUCTURE OPEN PLANT BELOW

1 Plan L07R - LTC Planting and Irrigation Plan

(1) Planting soil & planting materials including proprietary drainage cell / subsoil drains & filter fabric shall be supplied & installed by the soft landscape contractor for all planting area and flower pots.

(2)Allowing 50mm clearance from the adjacent finish level.
(3)The soiling requirements in the soft landscape works specification shall be read in conjunction with section 25 - landscape work of the general specification for building 2012 edtion(G.S.).

B.D. REF:

F.S.D. REF:

KEY PLAN

NOTES:

PLANTING AREA

O.00 FFL

O.00 FFL

FINISHED FLOOR LEVEL

STRUCTURAL FLOOR LEVEL

PLANTER DRAIN

WATERPOINT (MANUAL IRRIGATION)

REV. DATE

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5 Rue Pizay

Lyon,

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15th Floor, North Tower,
World Finance Centre, Harbour City

Tsimshatsui,
Hong Kong

Tsimshatsui,
Hong Kong

Central,
Hong Kong

12 Dechenstrasse, 53115

AUTHORITY'S CONSULTANT
QUANTITY SURVEYOR

OR TITLE

THE DESIGN AND CONSTRUCTION OF THE LYRIC THEATRE OF THE WEST KOWLOON CULTURAL DISTRICT

DRAWING TITLE
Plan L07R - LTC Planting and Irrigation Plan

 SCALE
 1 : 600(A3) 1:200(A0)
 PRINTED
 A0

 CHECKED
 VV
 DATE
 07.12.2018

 APPROVED
 NL
 DATE
 07.12.2018

 PRODUCED BY
 MS/EP
 DATE
 07.12.2018

 AUTHOR
 LWKL

 DISCIPLINE
 LANDSCAPE

 PHASE
 L2 CONSTRUCTION


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 REV.


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CAD REF NAME: 3A35X-LWK-LAN-DWG-1504-P00-L007-WS4.dwg

TREE PLANTING SCHEDULE										
Item	數量 Qty	植物名稱 Botanical Name	中文名稱 Chinese Name	高度 Height	冠寬 Spread	胸徑 DBH (mm)				
TREES			<u> </u>	(mm)	(mm)	(mm)				
SS	9	Sapium sebiferum	 烏桕	3000	2500	80				
TD	12	Taxodium distichum	落羽松	5000	2500	100				
TM	21	Terminalia mantaly	細葉欖仁	6000	3000	110				
TMT	15	Terminalia mantaly cv. 'Tricolour'	 錦葉欖仁	5000	3000	100				
TC	14	Terminalia catappa	欖仁樹	5000	2500	100				
TOTAL	71					7130				
(Native Sp	ecies hi	lighted in <b>*BOLD</b> text)								

起源 Origin	Item	數量 Qty	植物名稱 Botanical Name	中文名稱 Chinese Name	高度 Height (mm)	冠寬 Spread (mm)	間距 Spacing (mm)	備註 Remarks
	SHRUBS /	GROUNE	COVER	110	(,	()	()	
Native	AEL	592	Aspidistra elatior	一葉蘭	400	300	250	每墩至少5芽; Min.5 shoots per unit;
Native	API	51946	Arachis pintoi	多年生花生	200	200	150	Dense consistent foliage, no branching and soil can be seen.
Exotic	BNI	2493	Breynia nivosa	白雪木	300	300	200	Dense consistent foliage, no branching and soil can be seen.
Exotic	CHY	21482	Cuphea hyssopifolia	台灣雪茄花	150	150	150	Dense consistent foliage, no branching and soil can be seen.
Exotic	DCA	782	Dieffenbachia 'Camilla'	白玉黛粉葉	400	400	350	每墩至少3芽; Min.3 shoots per unit;
Exotic	DGO	1744	Dracaena godseffiana	星點木	400	300	250	
Native	GJA	191	Gardenia jasminoides	梔子花	400	300	300	Dense consistent foliage, no branching and soil can be seen.
Native	LCH	5552	Ixora chinensis	龍船花	300	250	250	Dense consistent foliage, no branching and soil can be seen.
Exotic	LJA	2386	Lonicera japonica	金銀花	500	300	300	
Exotic	LMO	1135	Lantana montevidensis	鋪地臭金鳳	200	200	150	Dense consistent foliage, no branching and soil can be seen.
Exotic	NEX	847	Nephrolepis exaltata var. bostoniensis	波斯頓蕨	350	300	200	Dense consistent foliage, no branching and soil can be seen.
Native	OJA	10105	Ophiopogon japonicus	沿階草	200	200	150	Dense consistent foliage, no branching and soil can be seen.
Exotic	RBI	2330	Ruellia bittoniana	紫花蘆莉	500	300	200	Dense consistent foliage, no branching and soil can be seen.
Exotic	RHU	67	Rhapis humilis	細葉棕竹	1000	500	500	Dense consistent foliage, no branching and soil can be seen.
Exotic	ZCA	7153	Zephyranthes candida	蔥蓮	150	150	150	Dense consistent foliage, no branching and soil can be seen.
TURF (LAWN)								
Exotic	ZJA	700.4	Zoysia Japonica	朝鮮草				in sq. m.;every unit should be 300 x 300 x 40(H); soil thickness should be 30mm; submit sample and certificate for approval is a must; 以米平方為計價單位; 草皮每塊以300x300x40(高)為標準; 草塊土層以30mm厚為標準;
ВАМВОО								
Exotic	PNI	117	Phyllostachys nigra	紫竹	4000	400	300	

Appendix E - Planting Plan & Planting Schedule of P32 – Artist Hostel

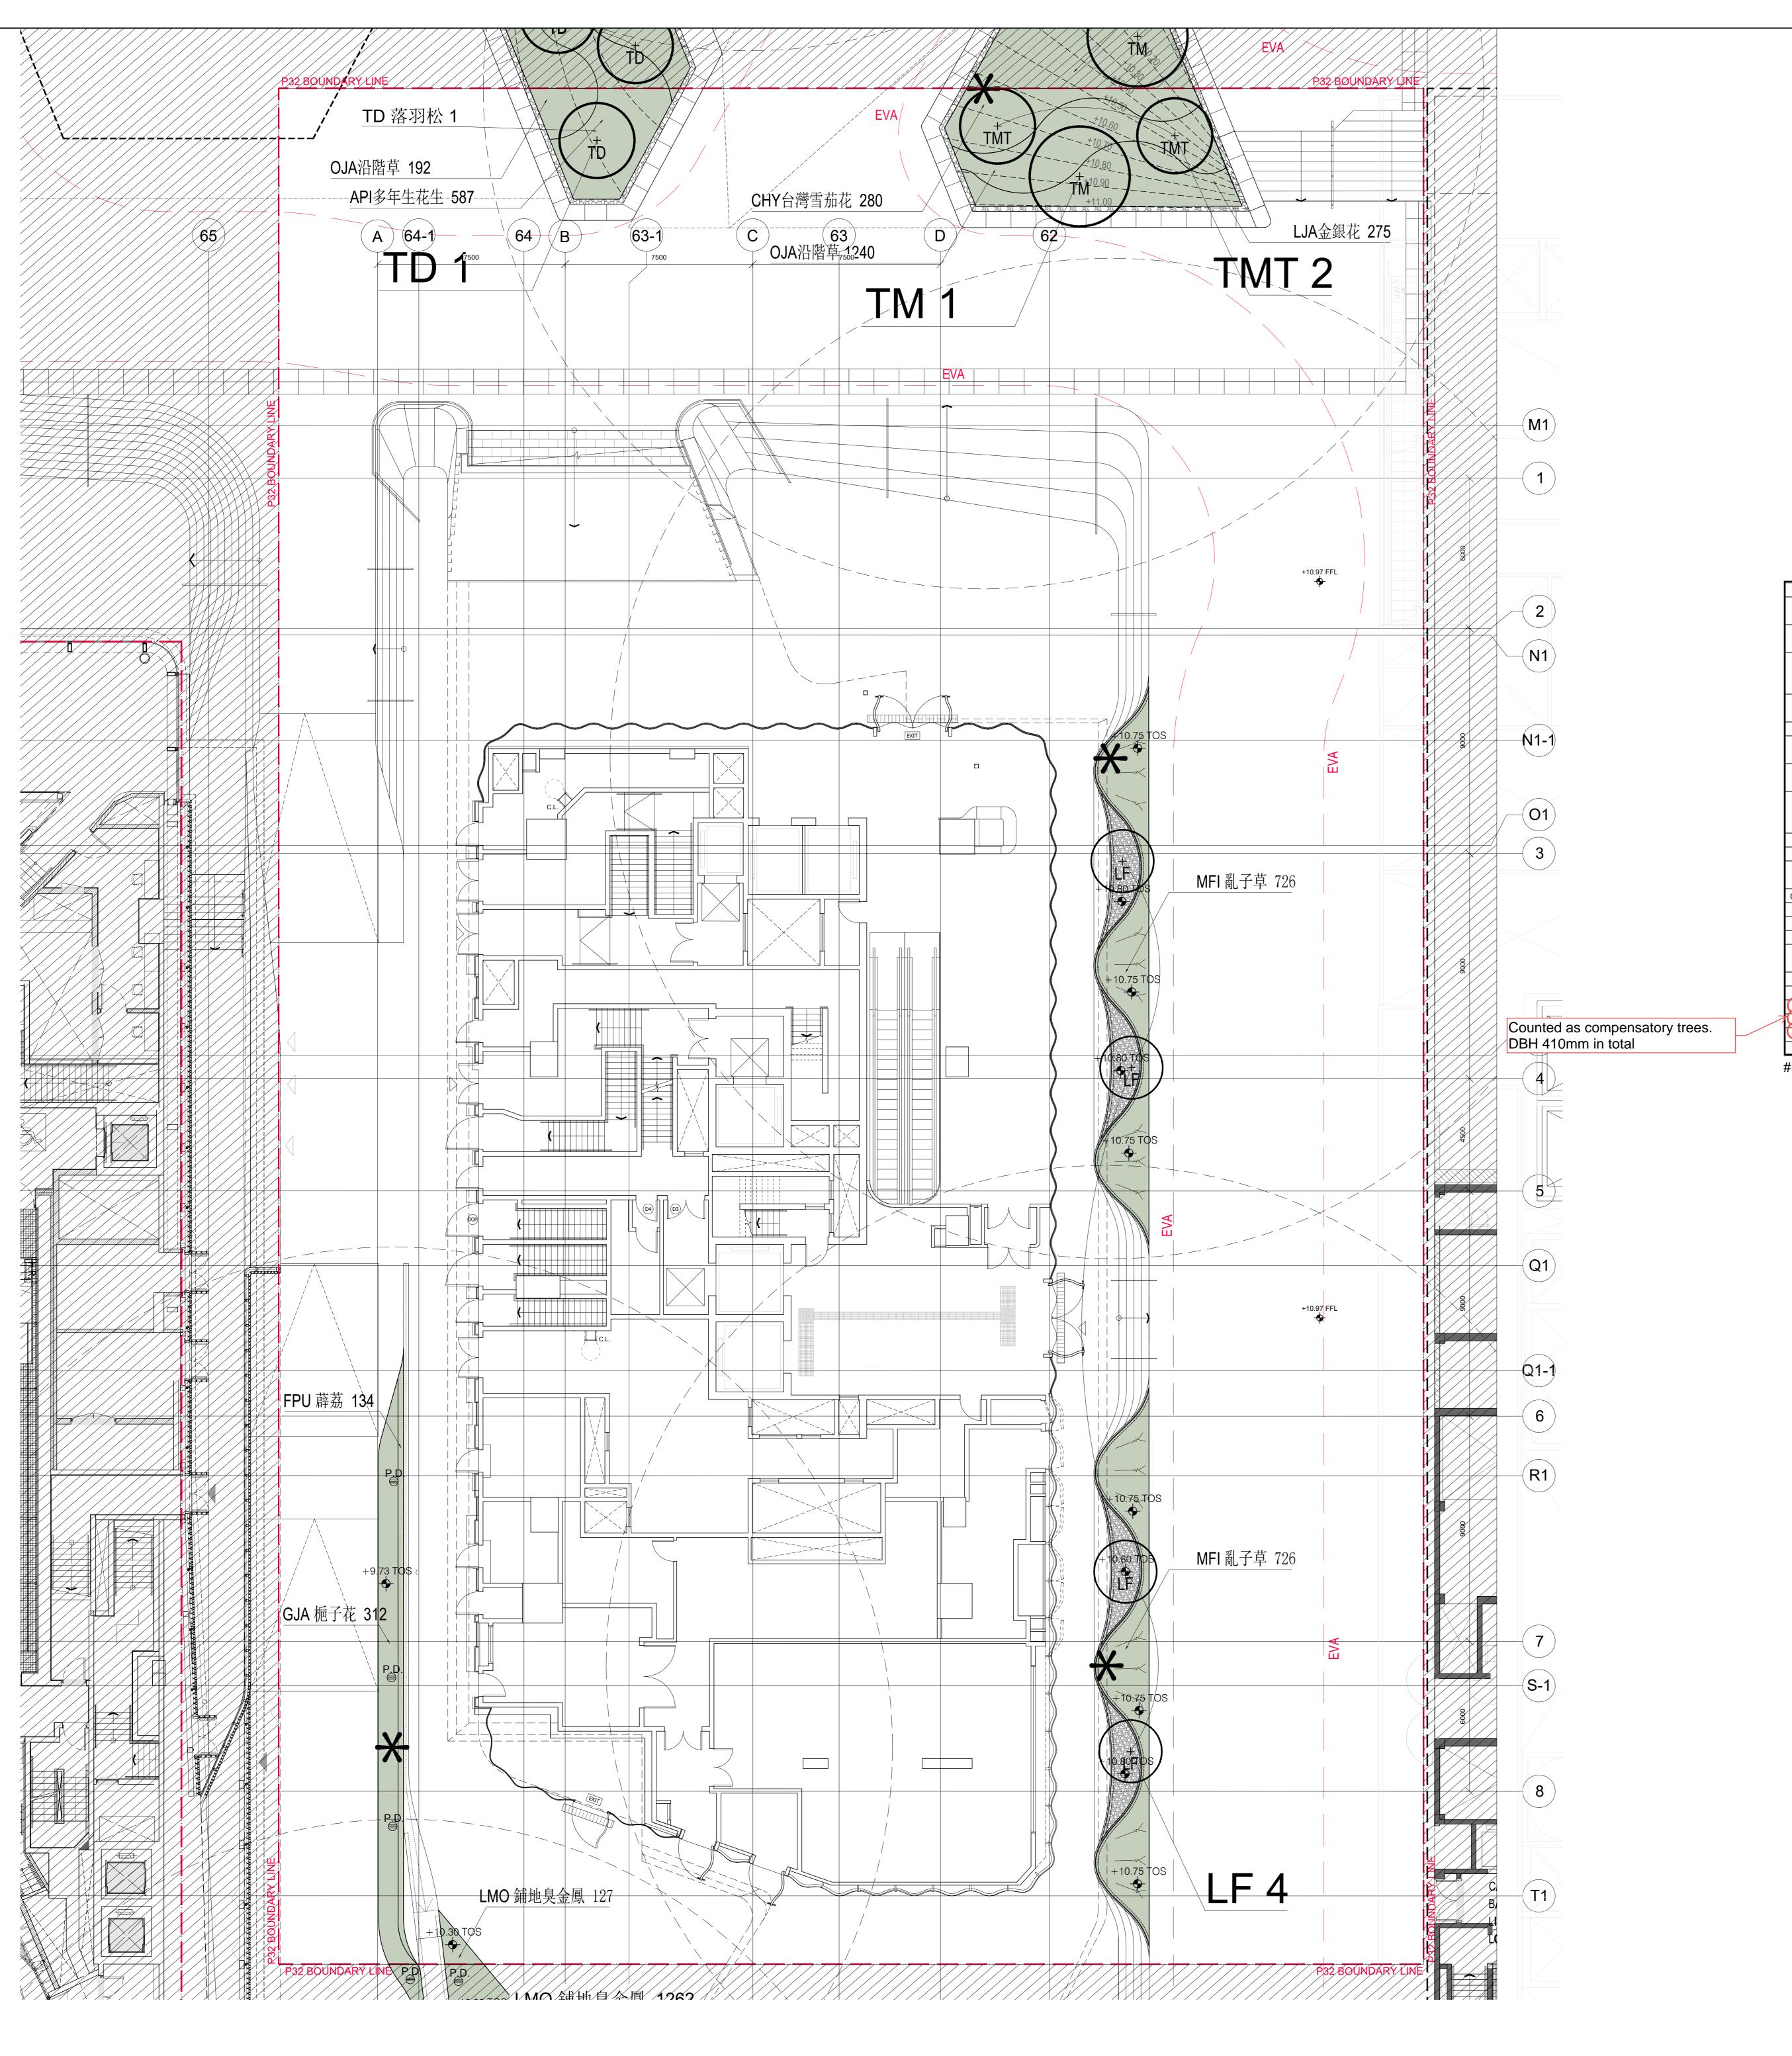

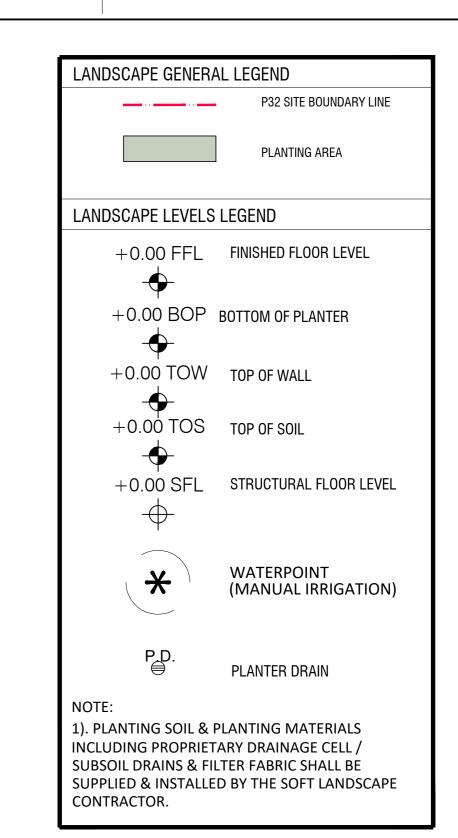

起源		數量	植物名稱	中文名稱	高度	冠寬	間距	備註
Crisis	ltem	O±v.	Botanical name	Chinese Name	Height	Spread	Spacing	Remarks
Origin	item	Qty	Botanicai name	Chinese Name	(mm)	(mm)	株/mm	
Native	API	587	Arachis pintoi	多年生花生	200	200	150	Dense consistent foliage, no branching and soil can be seen.
Exotic	СНҮ	280	Cuphea hyssopifolia	台灣雪茄花	150	150	150	Dense consistent foliage, no branching and soil can be seen.
Native	GJA	312	Gardenia jasminoides	槴子花	400	300	300	Dense consistent foliage, no branching and soil can be seen.
Exotic	LJA	275	Lonicera japonica	金銀花	500	300	300	
Exotic	LMO	127	Lantana montevidensis	舖地臭金鳳	200			Dense consistent foliage, no branching and soil can be seen.
Exotic	MFI	1452	Muhlenbergia filipes	亂子草	400	250	200	Dense consistent foliage, no branching and soil can be seen.
Native	OJA	1432	Ophiopogon japonicus	沿階草	200	200	150	Dense consistent foliage, no branching and soil can be seen.
						•	•	
起源		數量	植物名稱	中文名稱	冠	寬	間距	備註
Origin	là a ua	04	Botanical name	Chinese Name	Spr	ead	Spacing	Remarks
Origin	ltem	Qty	Botanical name	Chinese Name	(m	ım)	株/mm	
Climbers								
Native	FPU	134	Ficus pumila	薜荔	2	00	200	
起源		數量	植物名稱	中文名稱	高度	冠寬	胸徑	備註
Origin	ltem	Qty	Botanical name	Chinese Name	Height	Spread	DBH	Remarks
Oligili		4.7	Dotalical Hame	Cinnese Ivanie	(mm)	(mm)	(mm)	
Trees								
Native	LF	4	Liquidambar formosana #	楓香	4000	2500	100	
Exotic	TD	1	Taxodium distichum #	落羽松	5000	2500	100	
Exotic	TM	1	Terminalia mantaly #	細葉欖仁	6000	3000	110	
Exotic	TMT	2	Terminalia mantaly cv. 'Tricolour'	# 錦葉欖仁	5000	3000	100	

#BUFFER TREE

REV. DATE

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UNSTUDIO / AD+RG
LEAD ARCHITECTURAL DESIGNER

LEAD ARCHITECTURAL DESIGNER

UNSTUDIO

Room 1102-1105, 11/F, Yu Yuet Lai Building.

Room 1102-1105, 11/F, Yu Yuet Lai Building, 43-55 Wyndham Street, Central, Hong Kong

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AECOM

8/F, Grand Central Plaza, Tower 2, 138 Shatin Rural Committee Road, Shatin, Hong Kong **JRP 遵信** 

11/F, Tower 1, Millenium City 1,
388 Kwun Tong Road, Kowloon, Hong Kong

MARSHALL DAY
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JOB TITLE

P32 - ARTIST HOSTEL / RESIDENCE

Plan L000 - P32 Landscape Planting Plan

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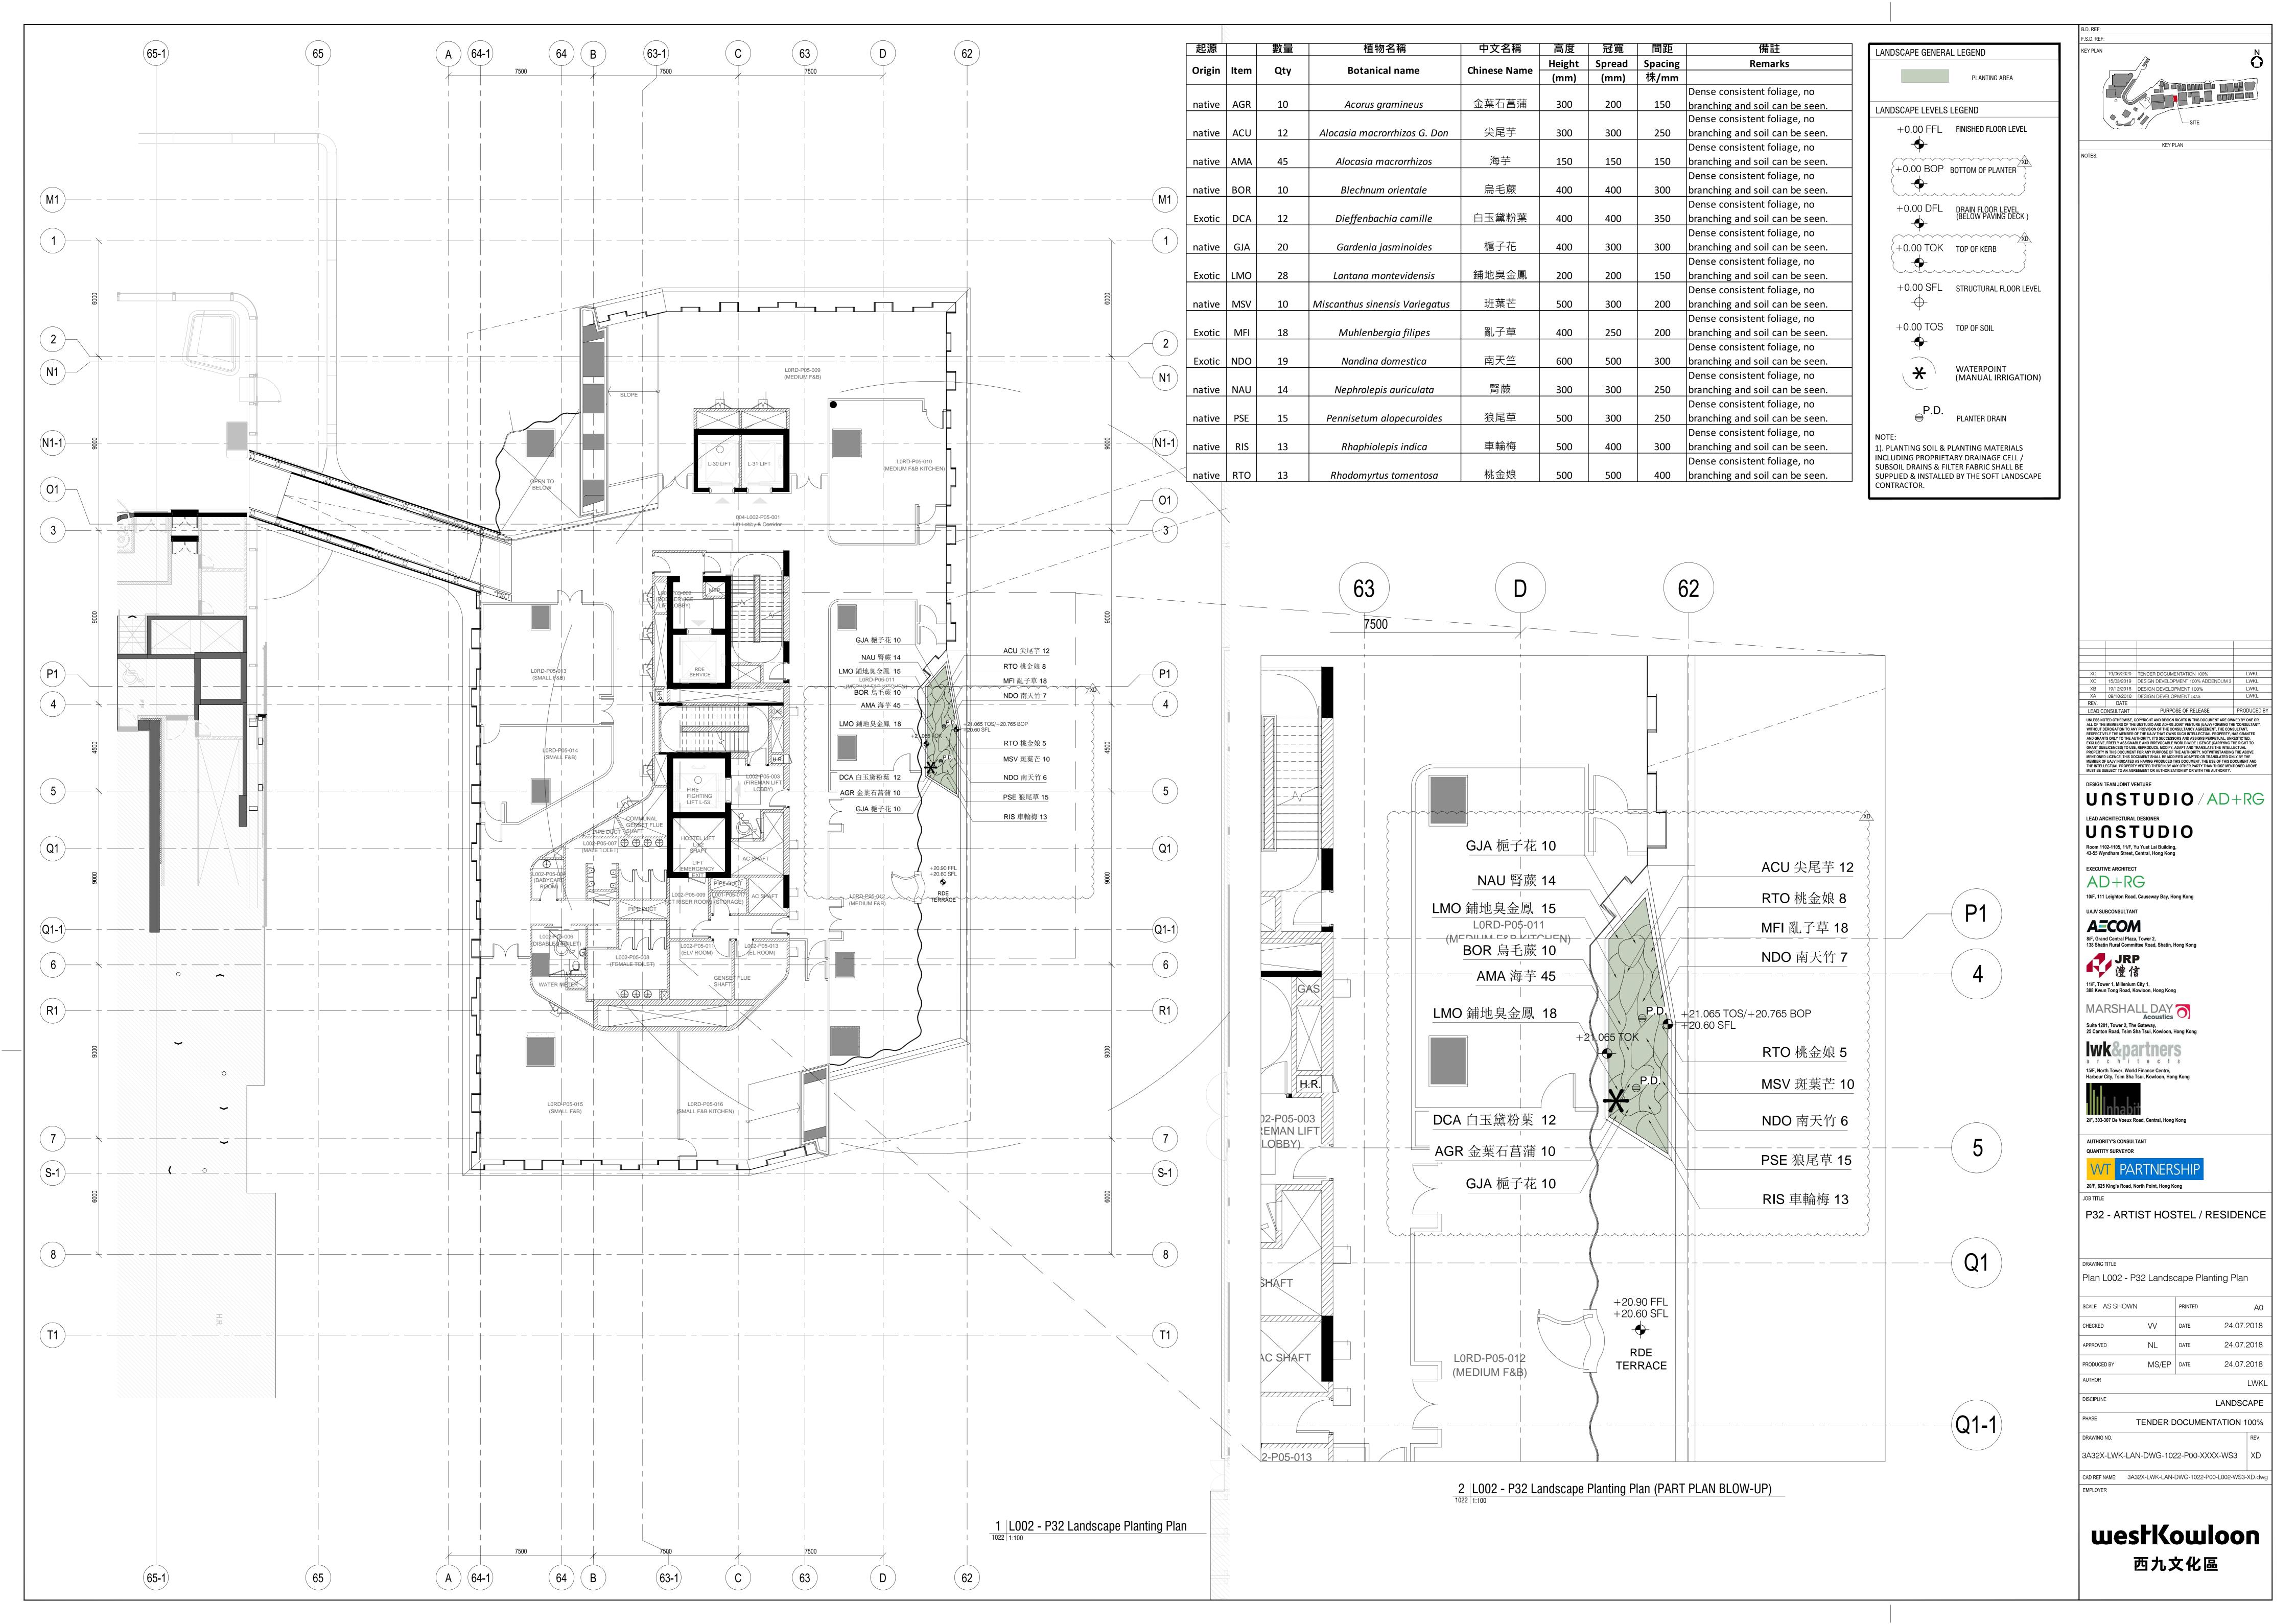
AUTHOR LWKL


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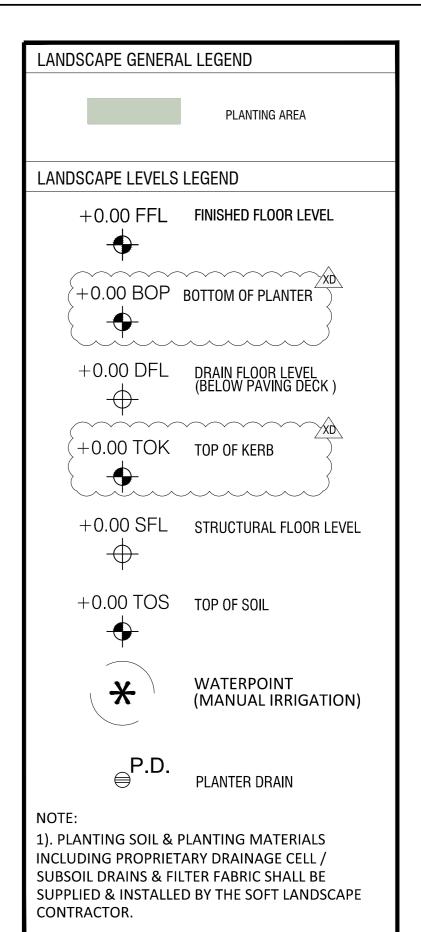
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起源		數量	植物名稱	中文名稱	高度	冠寬	間距
Origin	Item	Qty	Botanical name	Chinese Name	Height (mm)	Spread (mm)	Spacing 株/mm
native	ACH	37	Abelia chinensis R. Br	金錢蒲	300	300	700
native	ACU	85	Alocasia macrorrhizos G. Don	尖尾芋	300	300	250
native	AGR	106	Acorus gramineus	金葉石菖蒲	300	200	150
native	AMA	95	Alocasia macrorrhizos	海芋	150	150	150
native	BOR	32	Blechnum orientale	烏毛蕨	400	400	300
exotic	DCA	8	Dieffenbachia camille	白玉黛粉葉	400	400	350
native	GJA	52	Gardenia jasminoides	<b>槴子</b> 花	400	300	300
exotic	LCH	73	Loropetalum chinense	紅繼木	200	200	200
exotic	LMO	145	Lantana montevidensis	鋪地臭金鳳	200	200	150
native	LSI	233	Lonicera japonica	山指甲	400	300	150
native	LSP	60	Liriope spicata	麥門冬	200	200	150
exotic	MFI	118	Muhlenbergia filipes	亂子草	400	250	200
native	MSA	15	Melastoma sanguineum	毛菍	400	250	250
native	MSV	56	Miscanthus sinensis Variegatus	班葉芒	500	300	200
native	NAU	75	Nephrolepis auriculata	腎蕨	300	300	250
exotic	NDO	122	Nandina domestica	南天竺	600	500	300
native	OJA	85	Ophiopogon japonicus	沿階草	200	250	200
exotic	PPI	8	Philodendron bipinnatifidum	羽葉蔓綠絨	300	300	250
native	PSE	347	Pennisetum alopecuroides	狼尾草	500	300	250
native	RIS	24	Rhaphiolepis indica	車輪梅	500	400	300
native	RTO	26	Rhodomyrtus tomentosa	桃金娘	500	500	400



 
 XD
 19/06/2020
 TENDER DOCUMENTATION 100%

 XC
 15/03/2019
 DESIGN DEVELOPMENT 100% ADDENDUM 3

 XB
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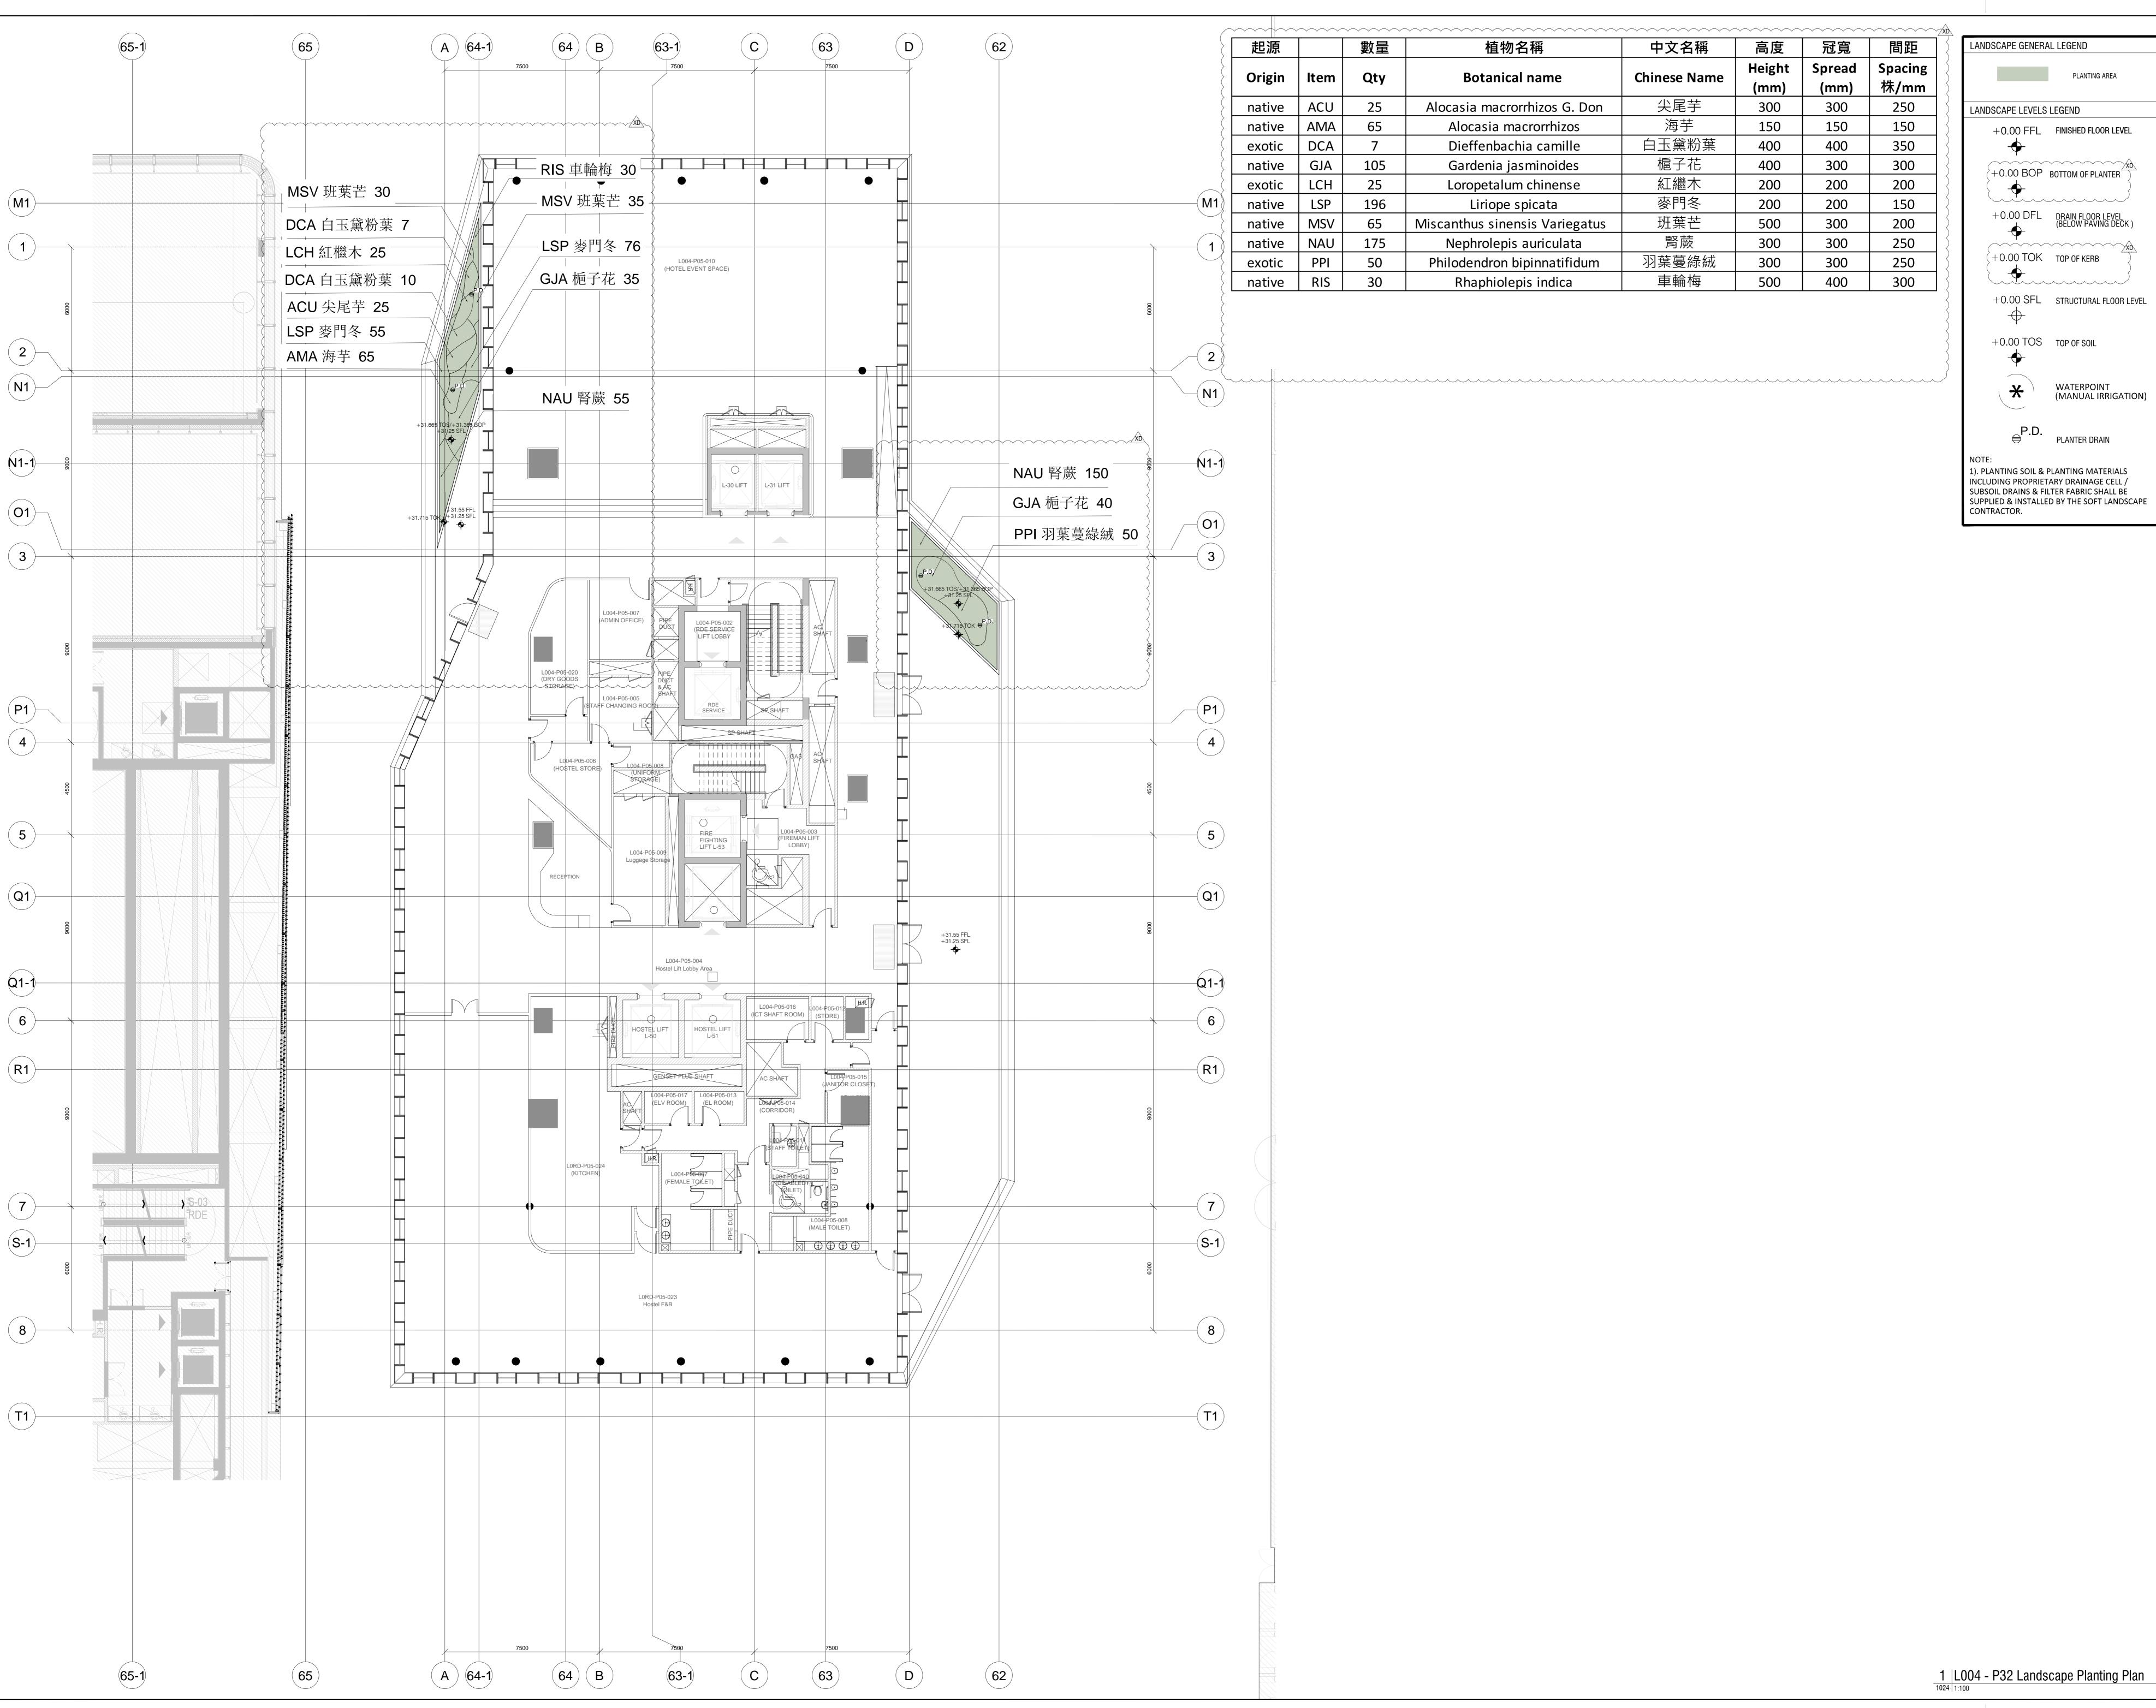
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Plan L003 - P32 Landscape Planting Plan
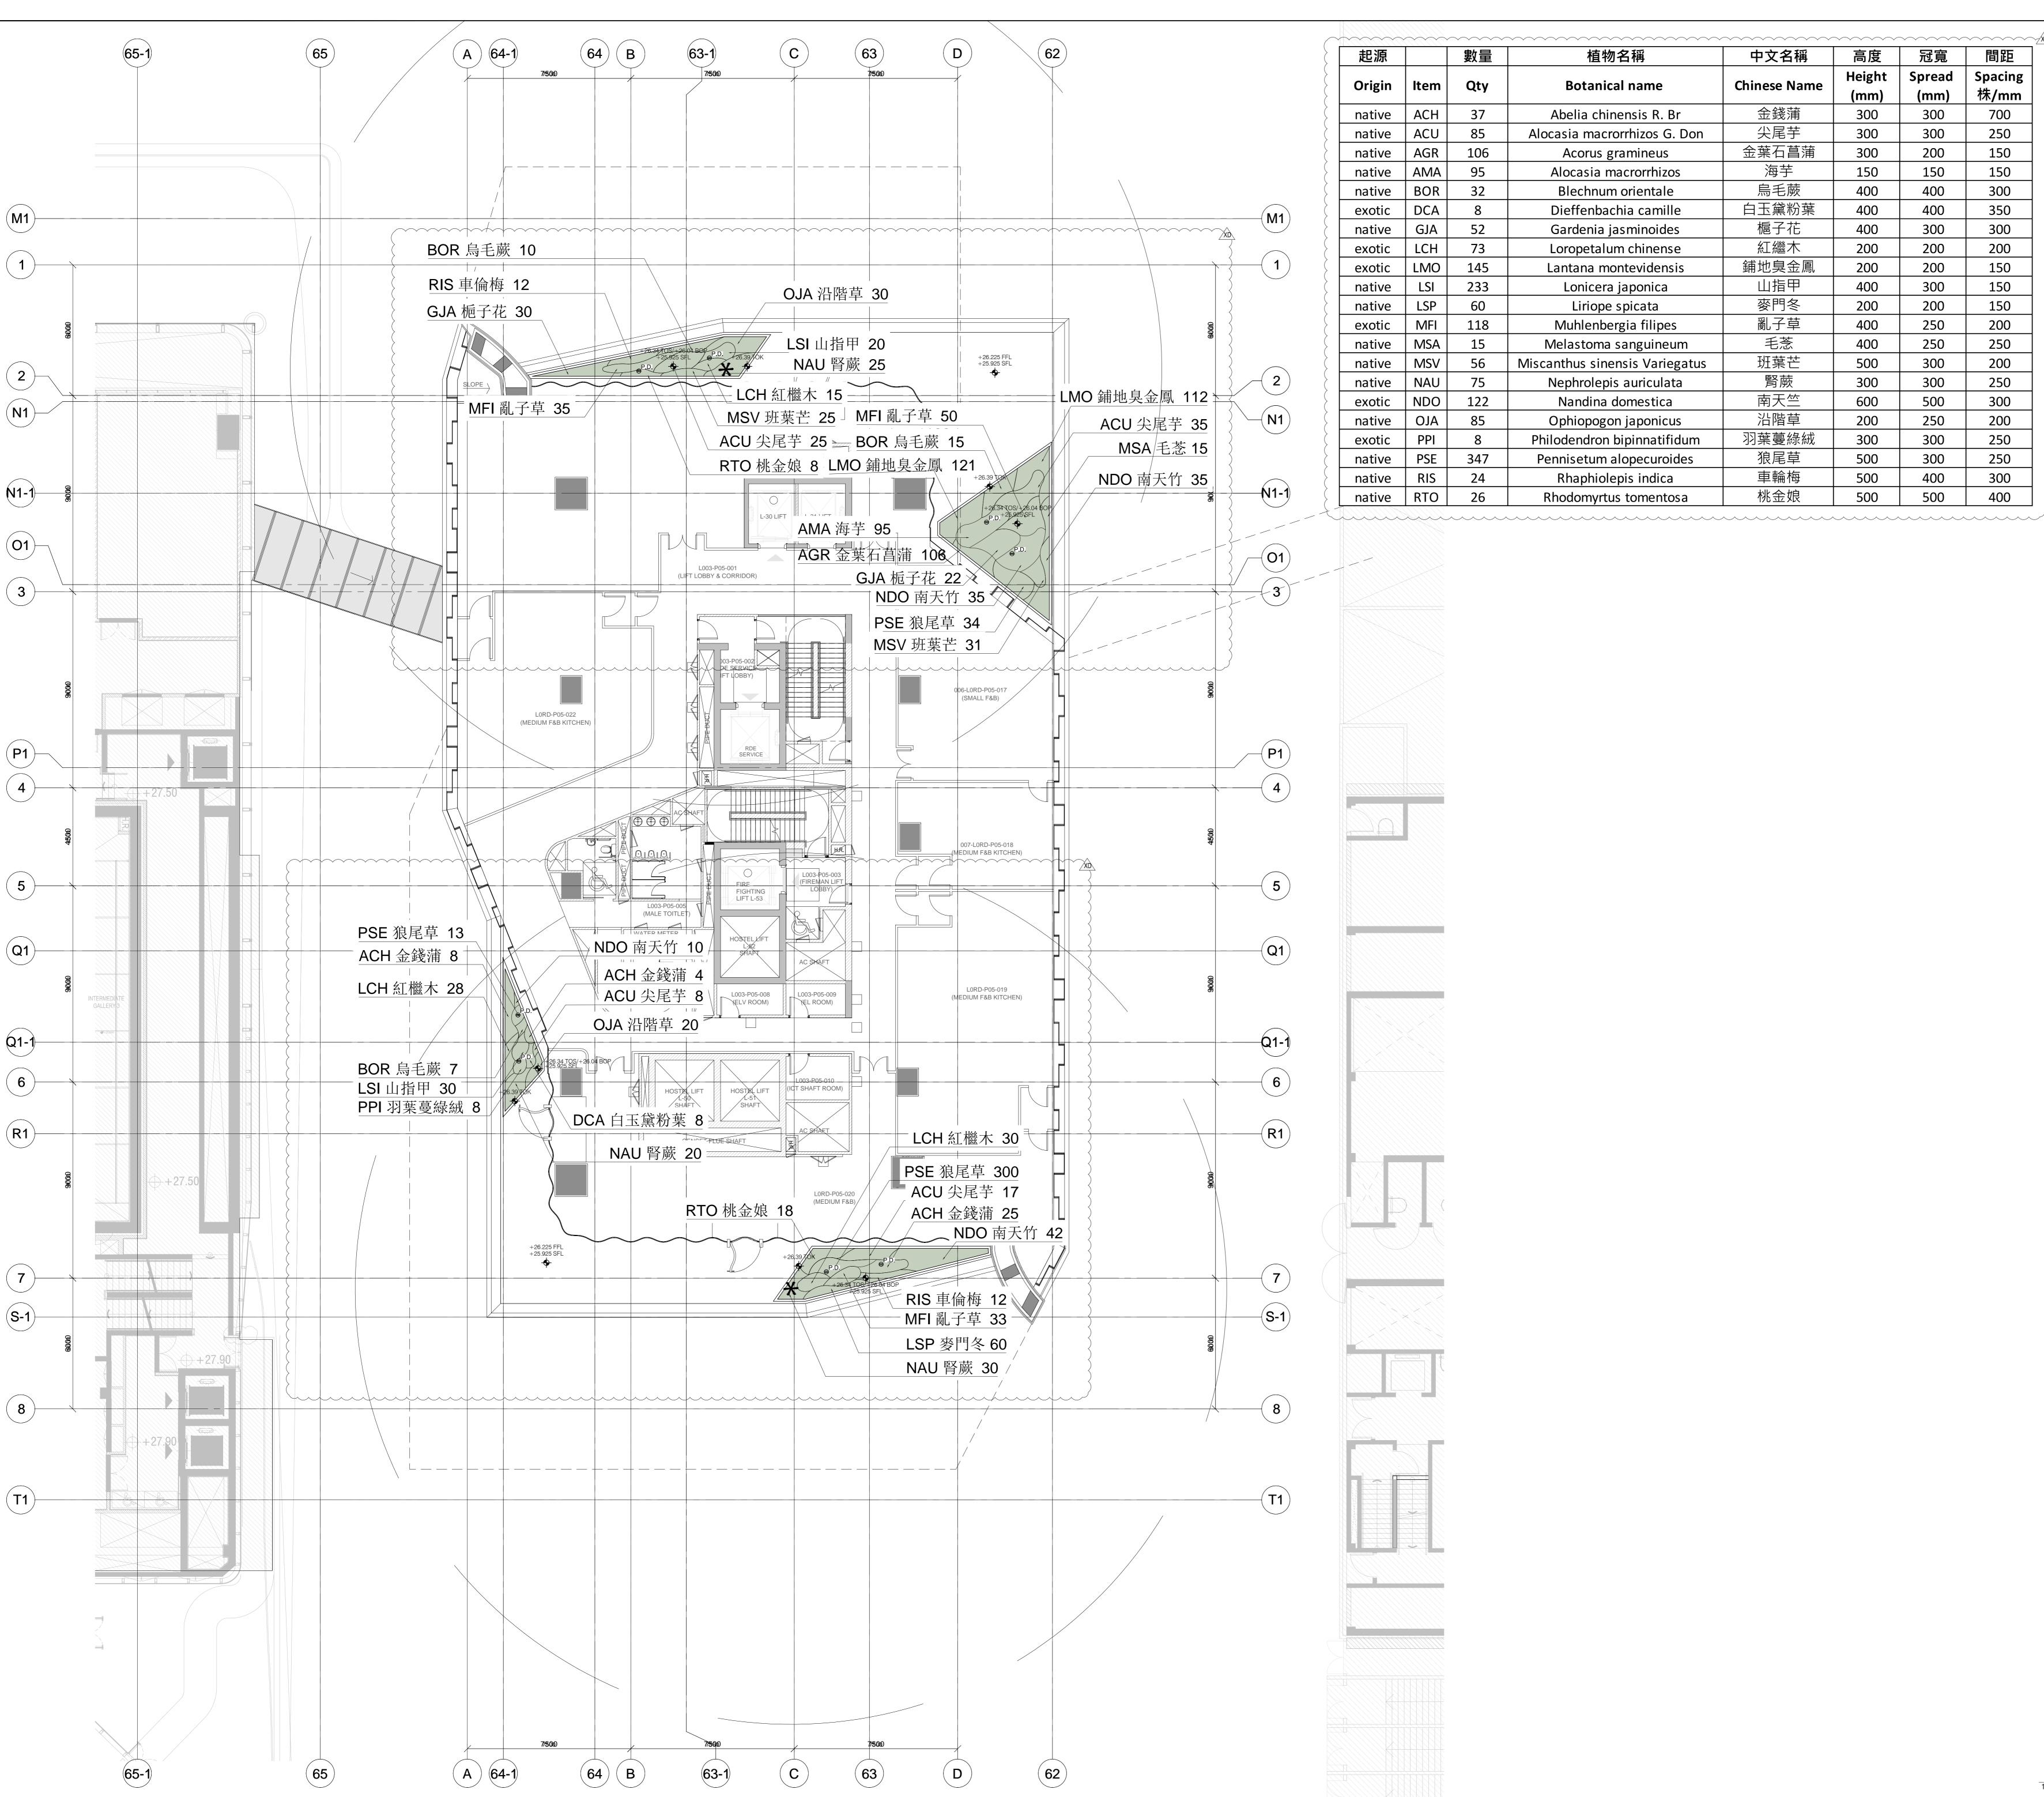
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XC 15/03/2019 DESIGN DEVELOPMENT 100% ADDENDUM 3

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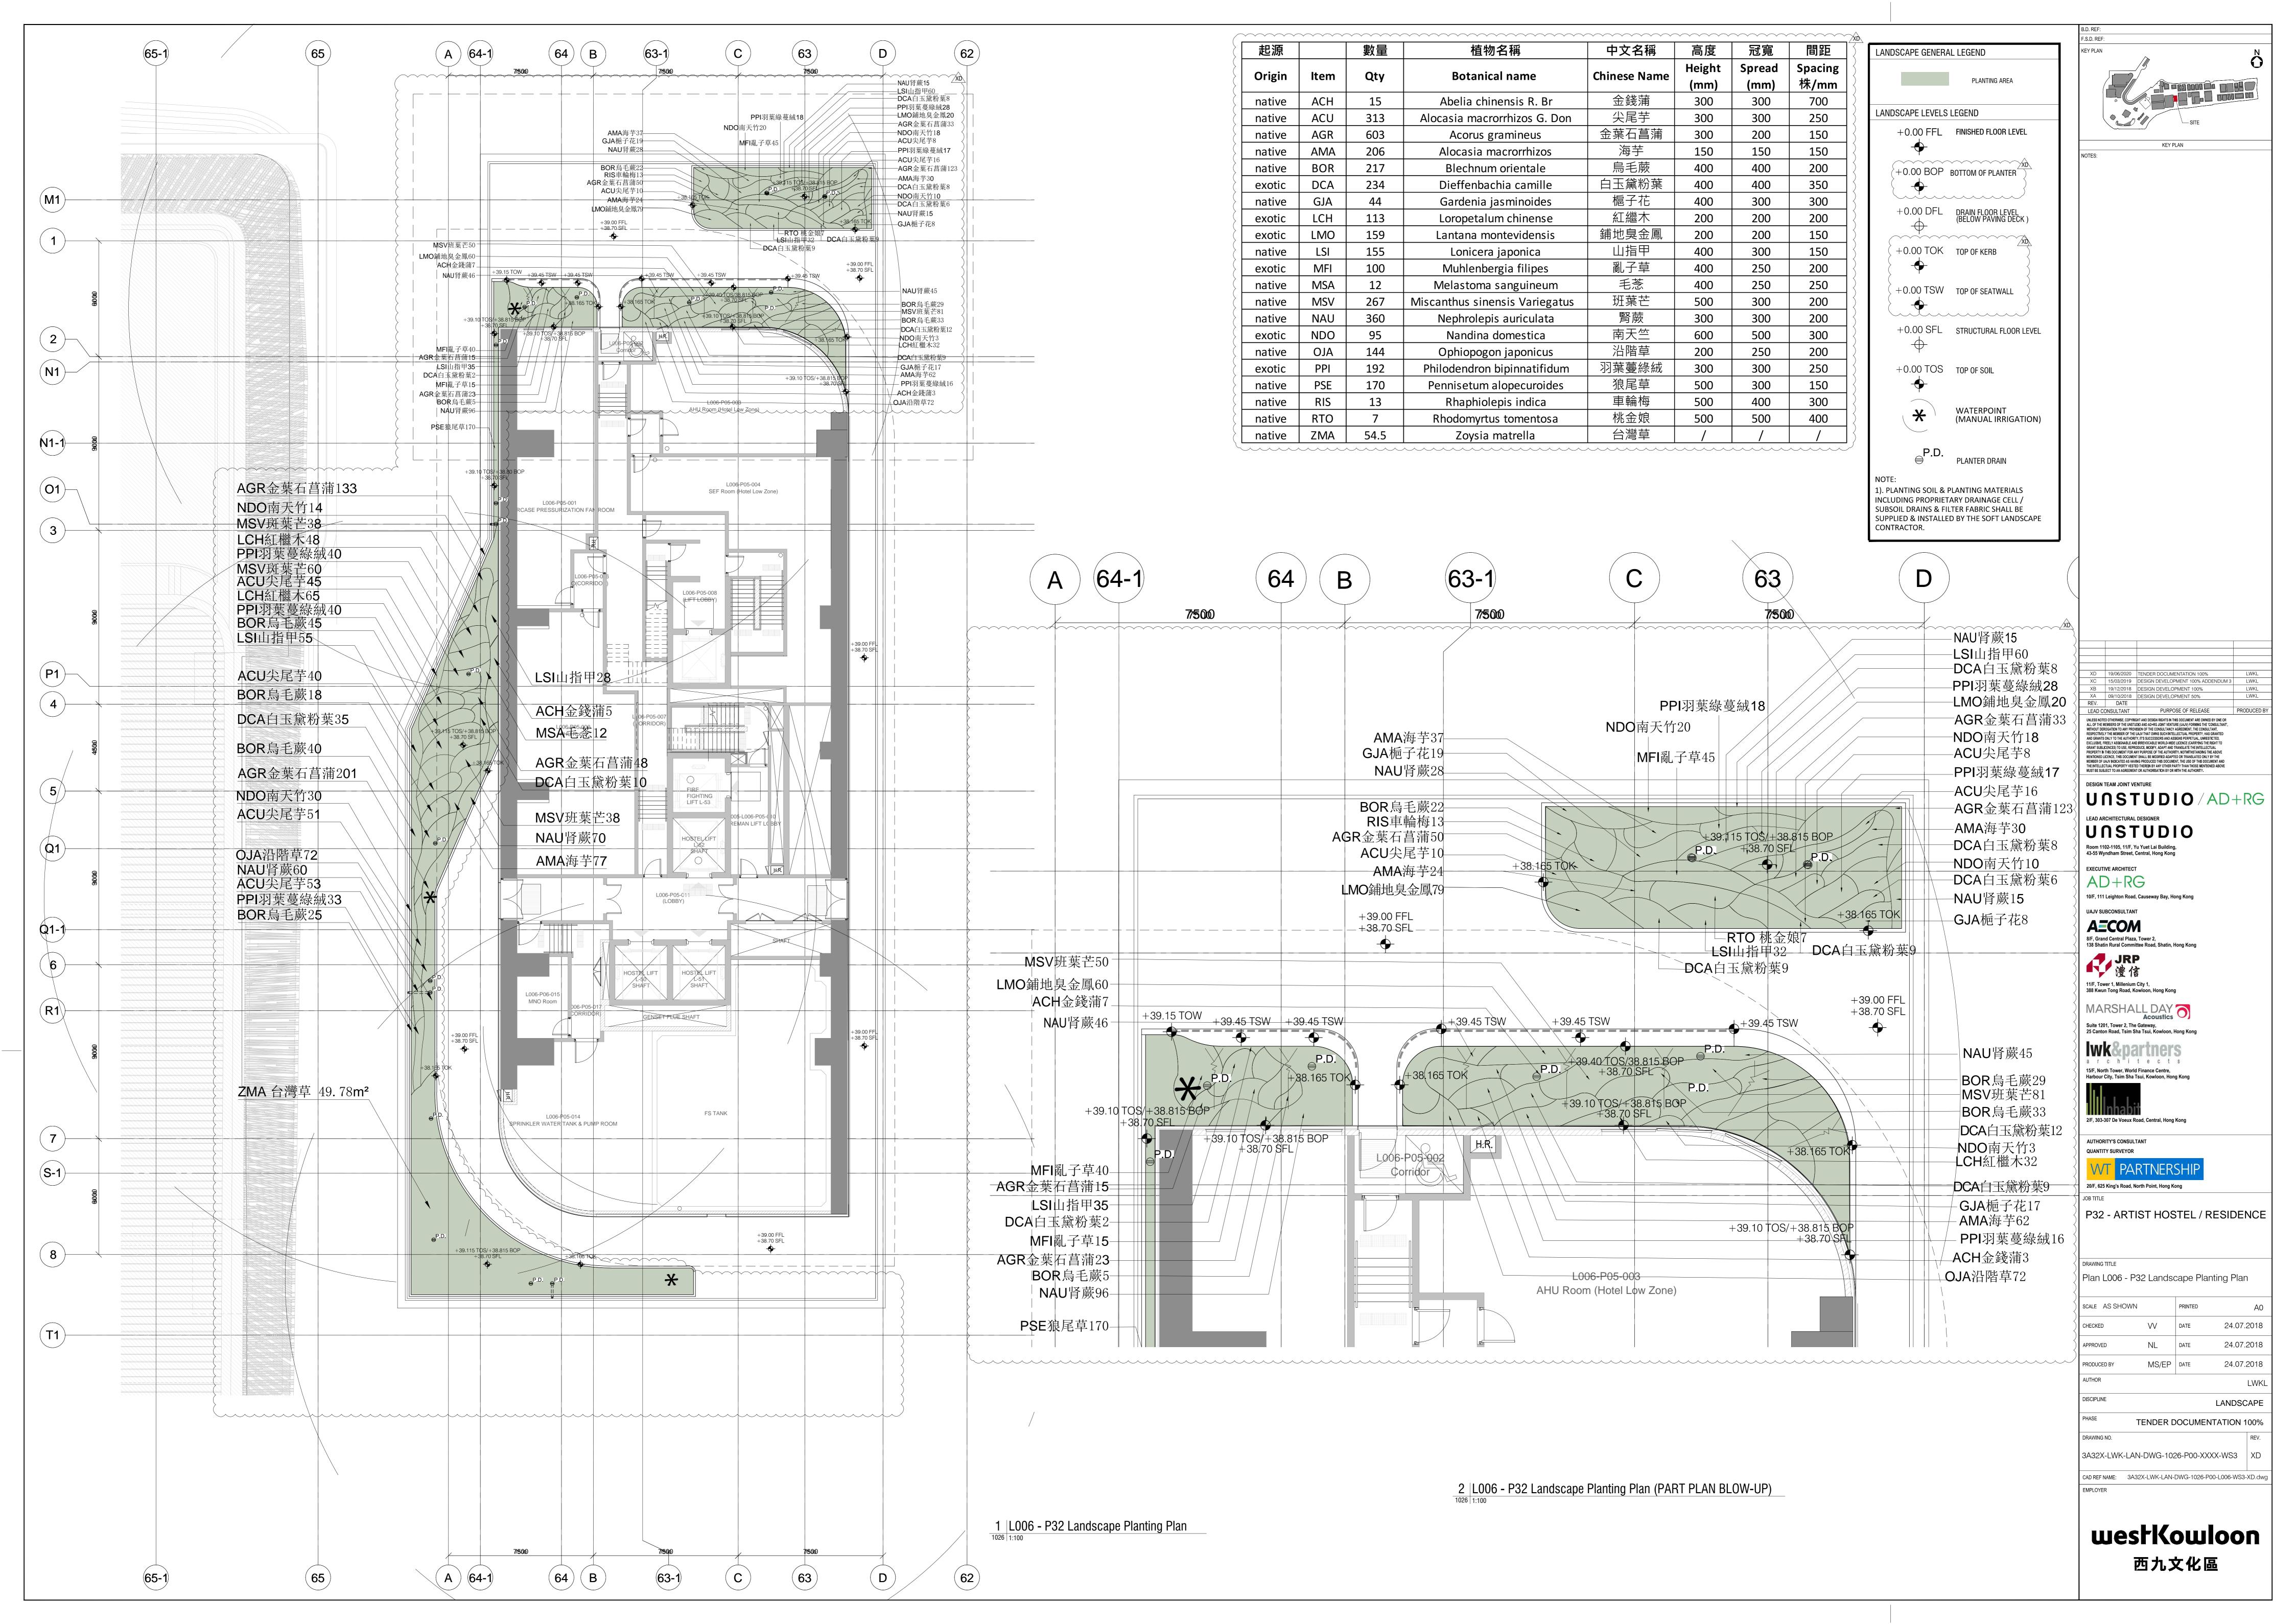
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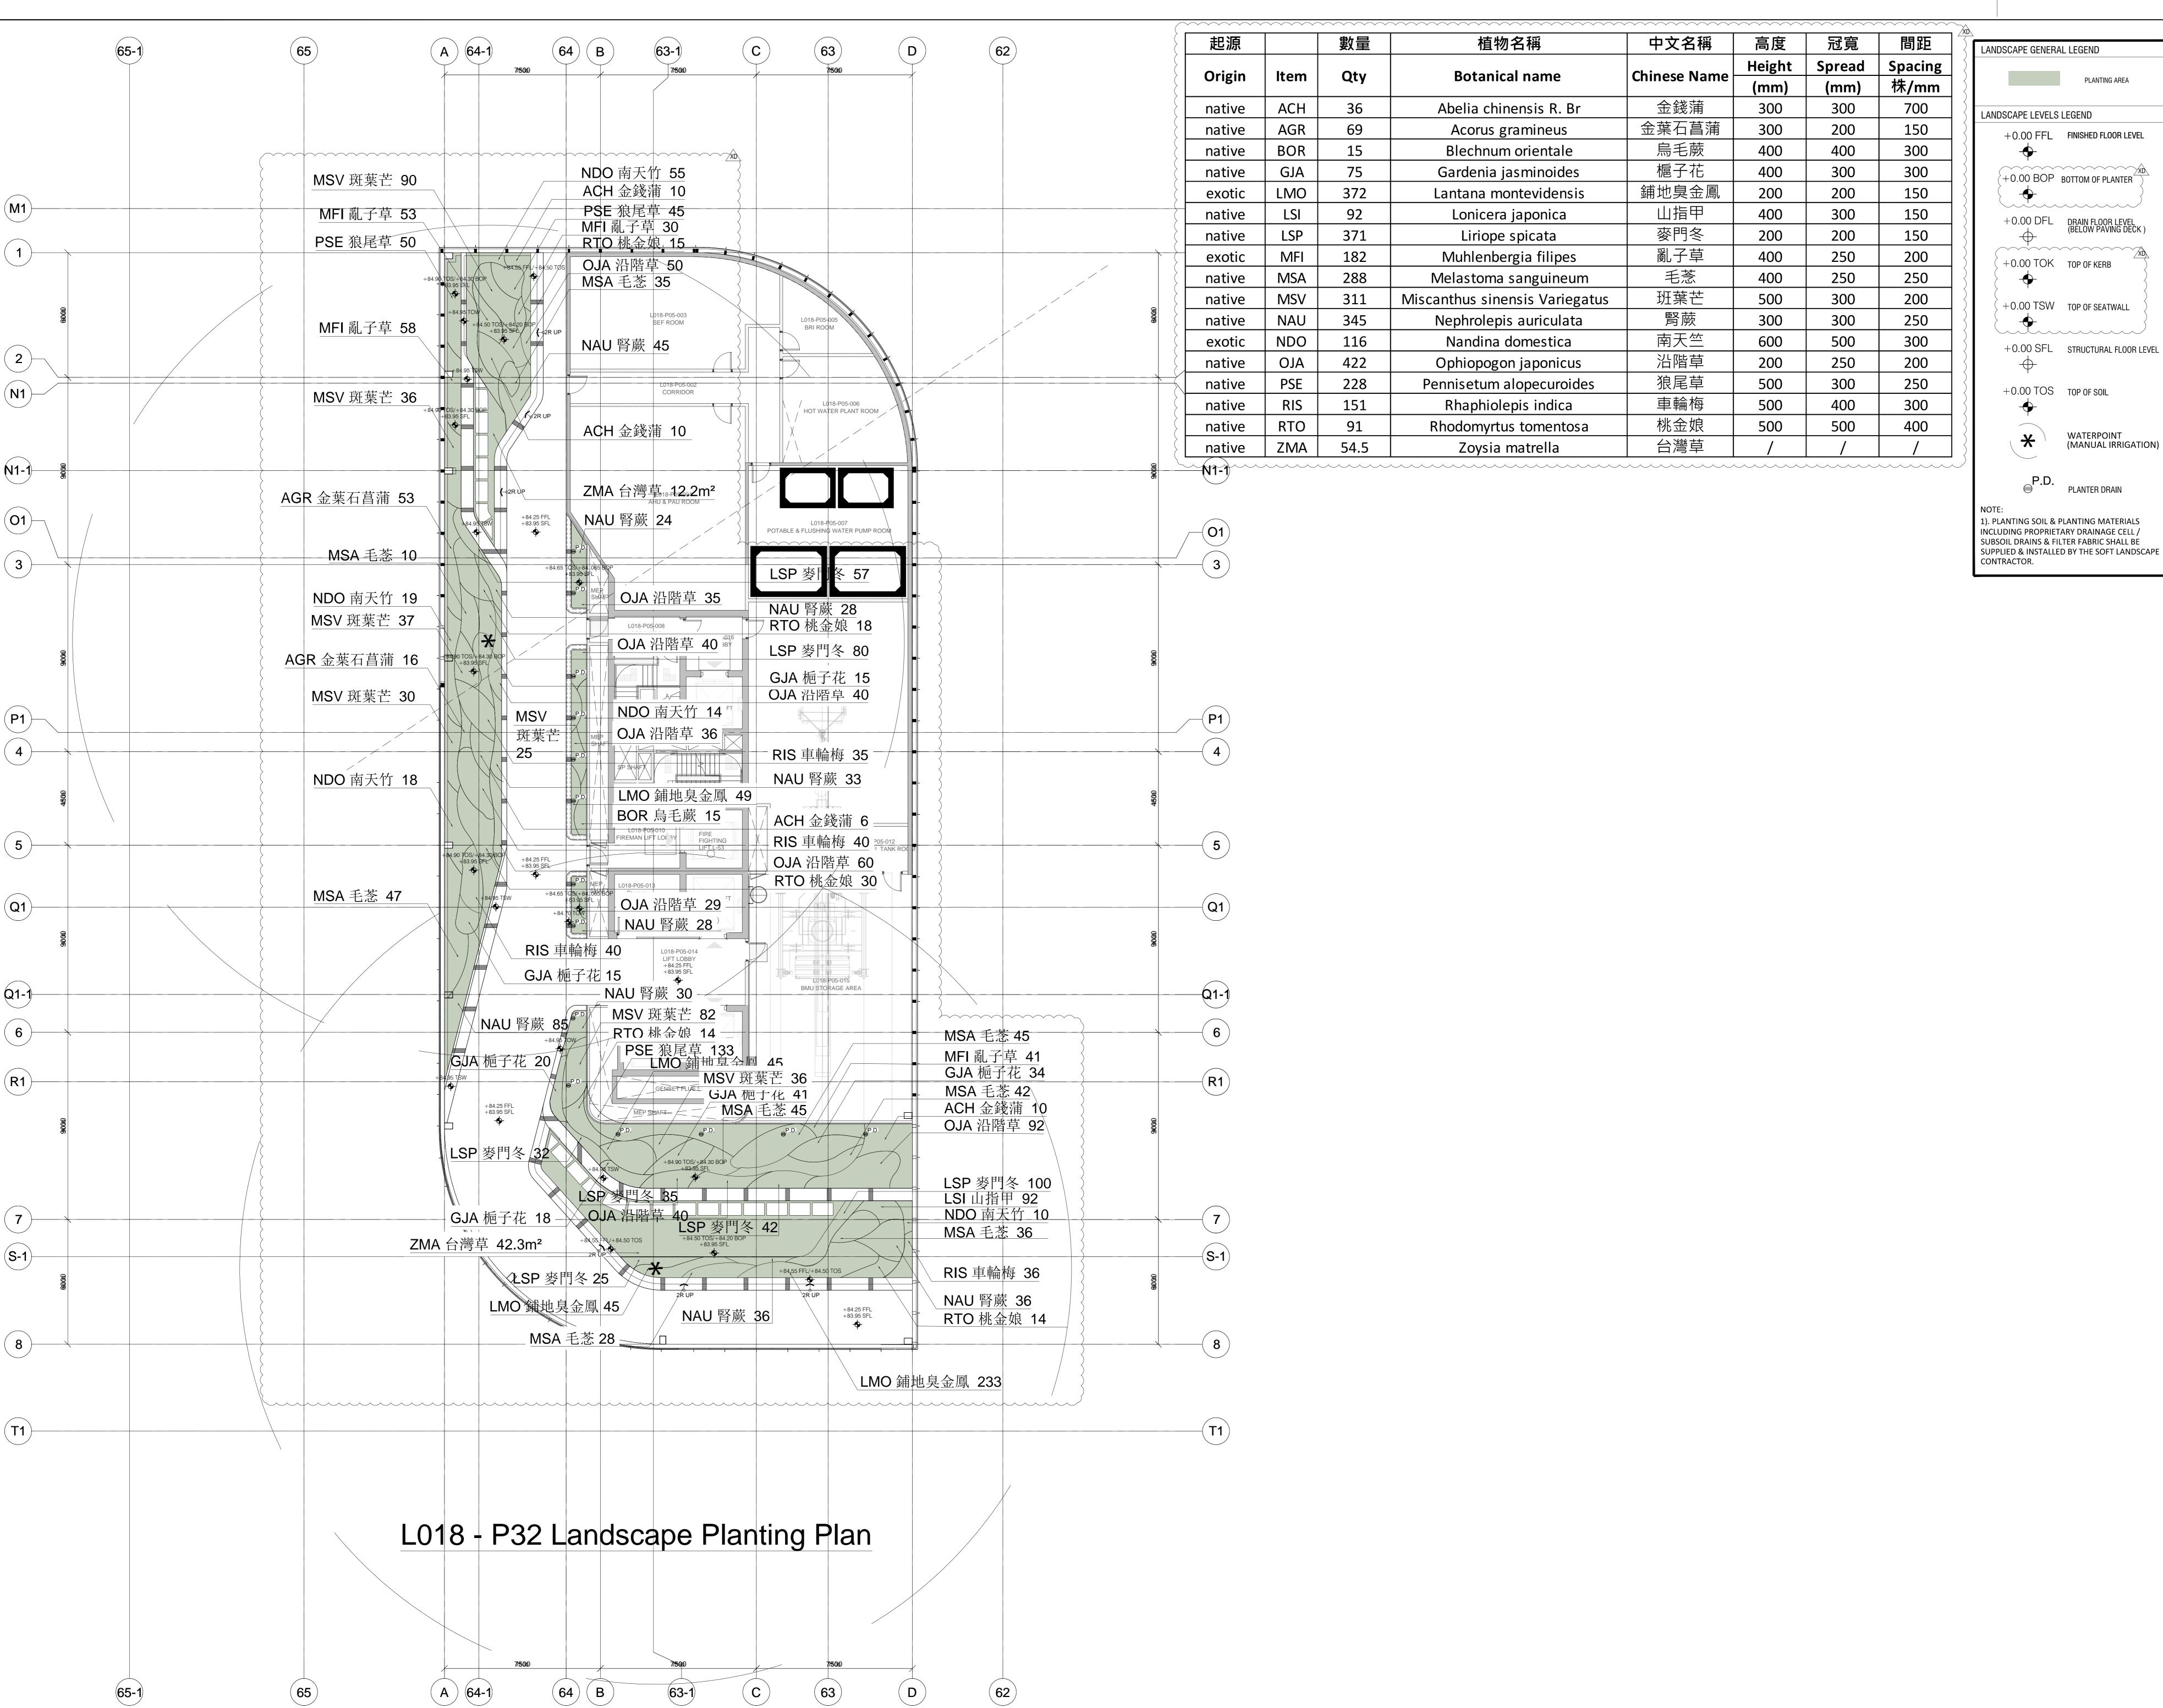
Plan L004 - P32 Landscape Planting Plan


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P32 - ARTIST HOSTEL / RESIDENCE

Plan L018 - P32 Landscape Planting Plan


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起源		數量	植物名稱	中文名稱	高度	冠寬	間距	備註
Origin	Item	Qty	Botanical name	Chinese Name	Height	Spread	Spacing	Remarks
	SICBO		<b>.</b>		(mm)	(mm)	株/mm	
SHKUB	J J J J J J J J J J J J J J J J J J J	OUNDCOVER		1 1		1	T	T
Native	AGR	788	Acorus gramineus	金葉石菖蒲	300	200	150	Dense consistent foliage, no branching and soil can be seen. 濃密葉片能覆蓋所有枝條及泥土.
Native	API	587	Arachis pintoi	多年生花生	200	200	150	Dense consistent foliage, no branching and soil can be seen. 濃密葉片能覆蓋所有枝條及泥土.
Native	ACH	88	Abelia chinensis R. Br	糯米條	300	300	700	Dense consistent foliage, no branching and soil can be seen. 濃密葉片能覆蓋所有枝條及泥土.
Native	ACU	435	Alocasia macrorrhizos G. Don	尖尾芋	300	300	250	Dense consistent foliage, no branching and soil can be seen. 濃密葉片能覆蓋所有枝條及泥土.
Native	AMA	411	Alocasia macrorrhizos	海芋	150	150	150	Dense consistent foliage, no branching and soil can be seen. 濃密葉片能覆蓋所有枝條及泥土.
Native	BOR	274	Blechnum orientale	烏毛蕨	400	400	300	Dense consistent foliage, no branching and soil can be seen. 濃密葉片能覆蓋所有枝條及泥土.
Exotic	СНҮ	280	Cuphea hyssopifolia	台灣雪茄花	150	150	150	Dense consistent foliage, no branching and soil can be seen. 濃密葉片能覆蓋所有枝條及泥土.
Exotic	DCA	261	Dieffenbachia camille	白玉黛粉葉	400	400	350	Dense consistent foliage, no branching and soil can be seen. 濃密葉片能覆蓋所有枝條及泥土.
Native	GJA	608	Gardenia jasminoides	槴子花	400	300	300	Dense consistent foliage, no branching and soil can be seen. 濃密葉片能覆蓋所有枝條及泥土.
Exotic	LMO	831	Lantana montevidensis	鋪地臭金鳳	200	200	150	Dense consistent foliage, no branching and soil can be seen. 濃密葉片能覆蓋所有枝條及泥土.
Native	LSP	627	Liriope spicata	麥門冬	200	200	150	Dense consistent foliage, no branching and soil can be seen. 濃密葉片能覆蓋所有枝條及泥土.
Native	LSI	480	Lonicera japonica	山指甲	400	300	150	Dense consistent foliage, no branching and soil can be seen. 濃密葉片能覆蓋所有枝條及泥土.
Exotic	LCH	211	Loropetalum chinense	紅繼木	200	200	200	Dense consistent foliage, no branching and soil can be seen. 濃密葉片能覆蓋所有枝條及泥土.
Native	MSV	709	Miscanthus sinensis Variegatus	班葉芒	500	300	200	Dense consistent foliage, no branching and soil can be seen. 濃密葉片能覆蓋所有枝條及泥土.
Exotic	MFI	1452	Muhlenbergia filipes	亂子草	400	250	200	Dense consistent foliage, no branching and soil can be seen. 濃密葉片能覆蓋所有枝條及泥土.
Native	MSA	315	Melastoma sanguineum	毛菍	400	250	250	Dense consistent foliage, no branching and soil can be seen. 濃密葉片能覆蓋所有枝條及泥土.
Exotic	NDO	352	Nandina domestica	南天竺	600	500	300	Dense consistent foliage, no branching and soil can be seen. 濃密葉片能覆蓋所有枝條及泥土.
Native	NAU	969	Nephrolepis auriculata	腎蕨	300	300	250	Dense consistent foliage, no branching and soil can be seen. 濃密葉片能覆蓋所有枝條及泥土.
Native	OJA	2083	Ophiopogon japonicus	沿階草	200	250	200	Dense consistent foliage, no branching and soil can be seen. 濃密葉片能覆蓋所有枝條及泥土.
Native	PSE	760	Pennisetum alopecuroides	狼尾草	500	300	250	Dense consistent foliage, no branching and soil can be seen. 濃密葉片能覆蓋所有枝條及泥土.
Exotic	PPI	250	Philodendron bipinnatifidum	羽葉蔓綠絨	300	300	250	Dense consistent foliage, no branching and soil can be seen. 濃密葉片能覆蓋所有枝條及泥土.
Native	RIS	231	Rhaphiolepis indica	車輪梅	500	400	300	Dense consistent foliage, no branching and soil can be seen. 濃密葉片能覆蓋所有枝條及泥土.
Native	RTO	137	Rhodomyrtus tomentosa	桃金娘	500	500	400	Dense consistent foliage, no branching and soil can be seen. 濃密葉片能覆蓋所有枝條及泥土.
TURF (	LAWN)							
Native	ZMA	104.28 sqm	Zoysia matrella	台灣草	/	/	/	In sq.m; every unit should be 300 x 300 x 40(H); soil thickness should be 30mm; submit sample and certificate for approval is a must;
								以平方米為計價單位;草皮每塊以300x300x40(高)爲標準 ;草塊土層以30mm厚為標準;
CLIMBI				<u>+</u> +++	,			T
Native	FPU	134	Ficus pumila	薜荔	/	200	200	

起源		數量	植物名稱	中文名稱	高度	冠寬	胸徑	備註
Origin	Item	Qty	Botanical name	Chinese Name	Height	Spread	DBH	Remarks
Origin	Item	Qty	Botailicai Hailie	Cilliese Name	(mm)	(mm)	mm	
TREE								
Native	LF	4	Liquidambar formosana	楓香	3500	2500	150	
Exotic	TD	1	Taxodium distichum	落羽松	5000	2500	100	
Exotic	TM	1	Terminalia mantaly	細葉欖仁	6000	3000	110	
Exotic	TMT	2	Terminalia mantaly cv. 'Tricolour'	錦葉欖仁	5000	3000	100	

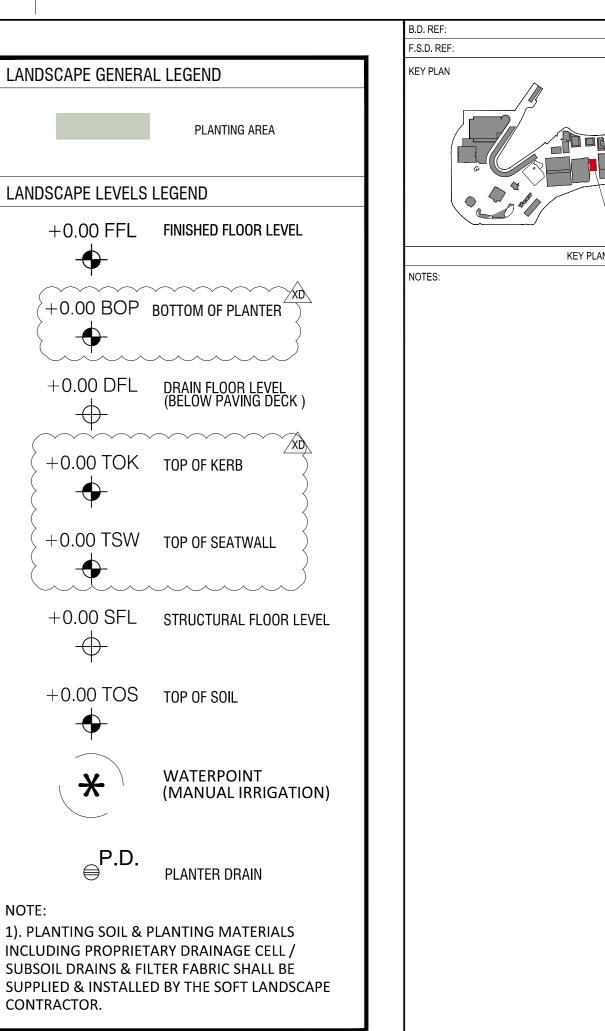

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P32 - ARTIST HOSTEL / RESIDENCE

DRAWING TITLE
PLANTING SCHEDULE
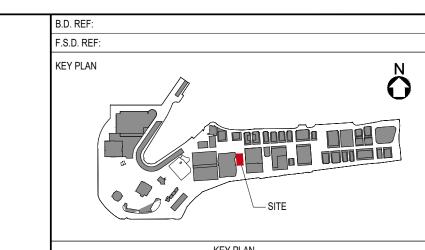
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 NL
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 MS/EP
 DATE
 24.07.20

 AUTHOR
 LN

DISCIPLINE

LANDSCAPE

PHASE

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**Appendix F – Post Planting Care Plan** 



# Post Planting Care Plan LYRIC THEATRE

Establishment work operation schedule (12 month establishment period for all planting is required to be carried out by the contractor prior to hand over the soft landscape works to the Authority and /maintenance agency to undertake the long term maintenance requirement.)

Operation	Description	Frequency	Notes
a. Replacement planting	Replacement of dead or dying plants	As directed by the Landscape Architect	Immediately following weeding operations. Preferably during planting season i.e. Mar-Sep.
b. Watering	Watering of planted areas as required	Daily operation except where rainfall > 20mm/day. Early morning and/or late afternoon	Duration of the irrigation system watering time to be reviewed periodically and any necessary adjustment made
c. Weeding	Removal of all non-specified plants for all planting areas	12 times per year – once every three weeks in growing season, once five weeks at other times	The three weeks weeding cycle – adjusted to five weeks in the winter season (continuous cycle of weeding)
d. Noxious and invasive weeds	Remove species of noxious and invasive weeds, e.g. <i>Mikania micrantha</i> and <i>Leucaena leucocephala</i> , immediately when discovered	Daily check as part of other inspections – immediately treatment as necessary	Observe the guidelines and practice notes promulgated by AFCD on treatment of noxious weeds
e. Post-planting fertilizer	Application of fertilizer to all planting areas	Two applications with 100 to 300 days in first Spring / Autumn after completion of planting / grass laying	Application of fertilizer twice during the first year
f. Soil aeration	Forking over to a depth of 100mm for grass / shrubs & groundcover plants	First Spring / Autumn following completion of planting	Operation conducted concurrently with fertilizer application
g. Mulching	Topping up of mulch to specified depth	Top up twice during the establishment period. Timing dependent on completion of planting – first immediately after aeration + second immediately before end of Establishment Period	Observe GLTMS guidelines on keeping mulch away from trunk flare
h. Firming up	Firming of trees and shrubs to ensure plants are set upright and properly established in the ground	As directed by the Landscape Architect – immediately after strong winds / typhoons and as necessary	Review on a monthly basis, adjustments made as necessary
i. Staking and tying	Adjustment of stakes and tying materials for trees and palms to ensure that they are secure, but allow room for plant growth	Review on a monthly basis, adjustments made as necessary	-
j. Pruning of trees / palms	Pruning of trees and palms to remove dead or damaged branches / fronds and to promote better canopy / crown shape.  (Formative pruning should be undertaken during	According to species, as determined by the Landscape Architect.	Observe relevant guidelines and Proper Planting Practices promulgated by GLTMS of DEVB
	plant preparation and immediately prior to planting)		
k. Pruning of shrubs and groundcovers	Pruning of shrubs and groundcovers to encourage bushy growth, tidy up appearance, topiary as intended, and remove dead / diseased branches	Review on a monthly basis. Prune according to species and agreed design intent, as directed by the Landscape Architect	Pruning as necessary to maintain the agreed design height for shrubs (action trigger height down to pruned height for each species / location)
m. Top dressing for grass areas	Top dress grass areas as required to smooth out minor depressions	Twice – timing to be agreed	-
n. Plant division	Remove selected plants to reduce overcrowding and replant elsewhere on site	As directed by the Landscape Architect, review on a monthly basis. (Preferably during planting season i.e. Mar-Sep)	-
o. Plant thinning	Remove selected plants to reduce overcrowding and dispose off-site	As directed by the Landscape Architect. Review on a monthly basis	-
p. Infestation by rodents etc.	Check all planting areas for signs of infestation by rodents etc. as part of the regular monthly inspection of the establishment works. Treatment	Daily check as part of other inspections – immediately treatment as necessary	



	by pest control measures.		
q. Pest, disease, fungal growth and parasitic plants	Check all plants for signs of pest, disease, fungal growth and parasitic plants as part of the regular monthly inspection of the establishment works. Treat pest, disease and fungal growth by applying suitable chemical or pruning as appropriate. Treat parasitic plants by physical removal.	Daily check as part of other inspections – immediately treatment as necessary	-
r. Protective fencing	Check and repair protective fencing	As required	-
s. Typhoon damage	Reinstatement of all displaced trees and shrubs, treatment or replacement of damaged plants	As required	-
t. Clearance of unwanted vegetation	Carry out as part of site clearance and weeding. Remove all unwanted vegetation including undersized wild growth undesirable to be kept at the location.	As directed by the Landscape Architect	-
u. Litter collection	Collection of litter and debris from site	Daily operation across site	-
v. Erosion control	Application of erosion control measures as required preventing / controlling soil erosions. Repair of eroded areas.	As required	
w. Removal of stakes & protective fencing	Removal of stakes, guys, ties and protective fencing at the end of the Establishment Period	Once	Part of the Final Inspection
x. Mowing	Regular mowing with a sharp mower blade at the proper height will help keep grass growing vigorously and maintain adequate density.	Take place weekly at first three months. Biweekly from the fourth month	
y. Fertilizing	Feeding the lawn will increase vigour and help prevent weeds and moss from establishing. Apply fertilisers when the soil is moist, or when rain is expected.	Twice per year	
z. Over-seeding	Overseeding newer turfgrass varieties into an older lawn can help it better withstand insects, disease, drought, shady conditions and heavy traffic. The investment in overseeding pays off by reducing the amount of fertilizer, water and pesticides required. Most importantly, a renovated lawn stays greener and looks thicker and healthier.		
aa. Top dressing	Topdressing is a sand or prepared soil mix applied to the surface of the lawn. The term topdressing also is used for the process of applying the material.	One time per year	
ab. Dethatching	Dethatching is the process of eliminating the layer of thatch that accumulates in a yard over time. Thatch is dead grass, roots, and debris that builds up between the soil and the blades of grass over time.	As required	



Soft Landscape Maintenance Schedule (long term maintenance requirement following 12 month establishment period)

#### Soft Landscape Maintenance Schedule

Operation	Frequency	Jan	Feb	Mar	Apr	May	Jun	Jul	Aug	Sep	Oct	Nov	Dec
Replacement Planting	Mar-Sept (as required)			*	*	*	*	*	*	*			
Watering	daily	*	*	*	*	*	*	*	*	*	*	*	*
Weeding	monthly	*	*	*	*	*	*	*	*	*	*	*	*
Removal of noxious and invasive weeds	daily	*	*	*	*	*	*	*	*	*	*	*	*
Apply post-planting fertilizer	Feb/Aug		*						*				
Soil aeration	Feb/Aug		*						*				
Top up mulching	2 times per year		*						*				
Firming up of tilted plants	(as required)	*	*	*	*	*	*	*	*	*	*	*	*
Adjust staking and tying of trees / palms	monthly	*	*	*	*	*	*	*	*	*	*	*	*
Pruning of trees / palms	(as required)	*	*	*	*	*	*	*	*	*	*	*	*
Pruning of shrubs and groundcovers	(as required)	*	*	*	*	*	*	*	*	*	*	*	*
Training and pruning of climbers, adjust climber ties and wires	(as required)	*	*	*	*	*	*	*	*	*	*	*	*
Top dressing for grass areas	2 times per year				*						*		
Plant division	Mar-Sept (as required)			*	*	*	*	*	*	*			
Plant thinning	(as required)	*	*	*	*	*	*	*	*	*	*	*	*
Control infestation by rodents etc.	(as required)	*	*	*	*	*	*	*	*	*	*	*	*
Control pest, disease, fungal growth and parasitic plants	(as required)	*	*	*	*	*	*	*	*	*	*	*	*
Check and repair protective fencing	(as required)	*	*	*	*	*	*	*	*	*	*	*	*
Repair typhoon damage	(as required)					*	*	*	*	*	*		
Clearance of unwanted vegetation	(as required)	*	*	*	*	*	*	*	*	*	*	*	*
Removing litter, stone and rubbish	(as required)	*	*	*	*	*	*	*	*	*	*	*	*
Erosion control	(as required)	*	*	*	*	*	*	*	*	*	*	*	*

Appendix G – Landscape, Architectural and Chromatic Treatment of the Hard Architectural and Engineering Structures and Facilities

# **Lyric Theatre & Artist Square**





Fig.1B

P32-artistHostel/ Residence

LTC - Lyric Theatre

Pocket park

Promenade

Figure 1

Fig.1C



# **Lyric Theatre & Artist Square**









Figure 2



UNS AD+RG The Lyric Theatre & P32- Artist Hostel / Residence Consultancy JV - Submission of Landscape Mitigation Plan

## **Artist Square - Landscape Design**

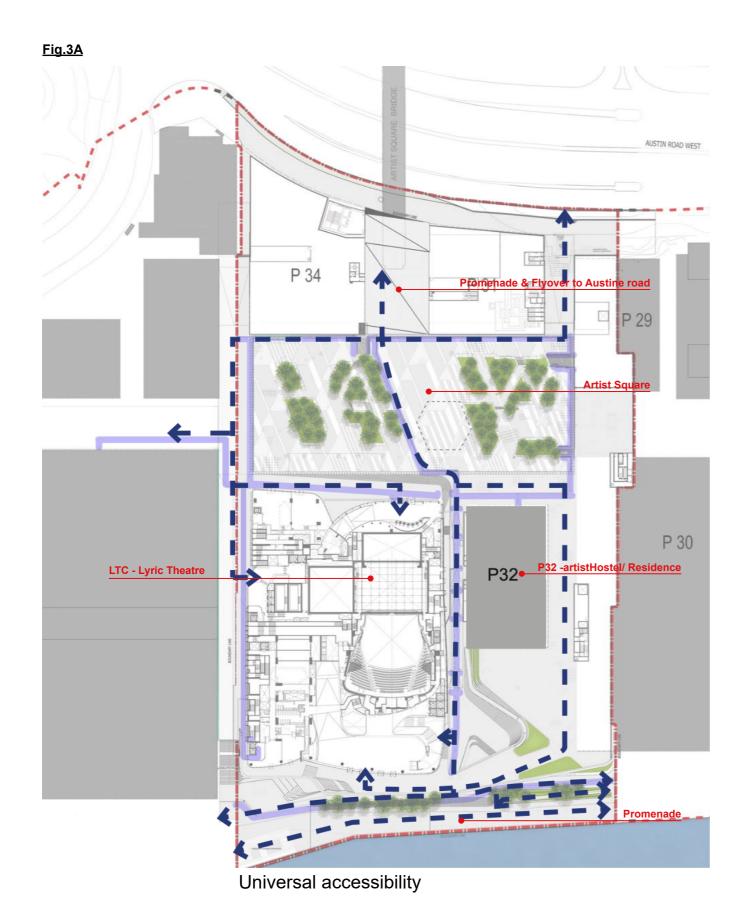


Fig.3B P 34 Artist Square P 30 LTC - Lyric Theati P32 Vehicular path


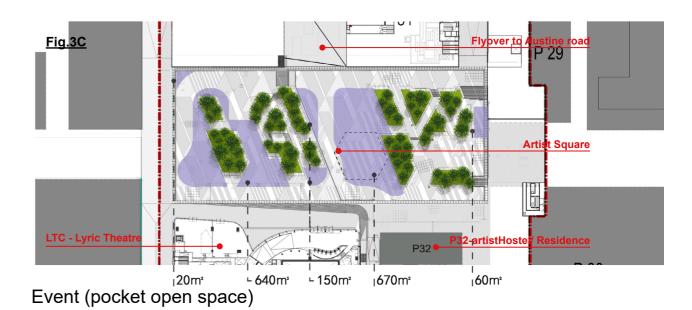


Figure 3

## **Artist Square, Pocket Park & Promenade**



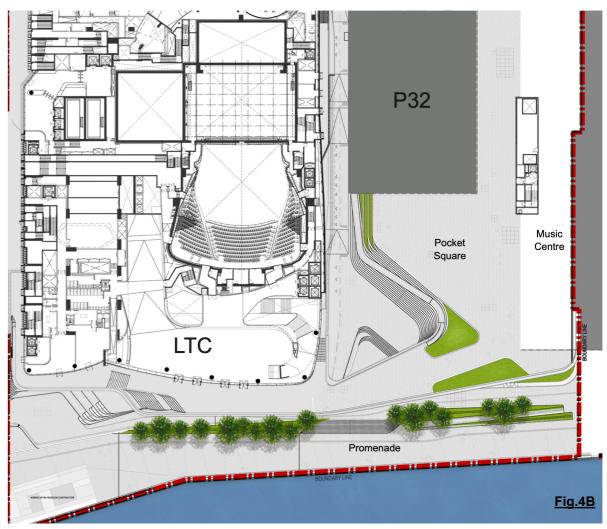

Pocket Park and Promenade





Artist Square

Figure 4





## Lyric Theatre - Planting Area & Green Roof in Various Level

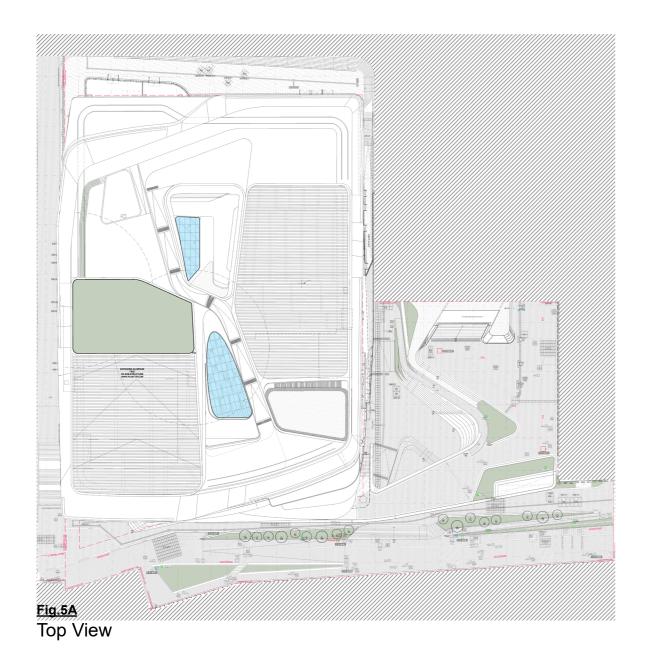

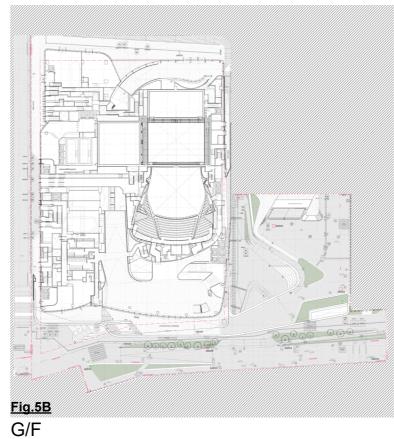



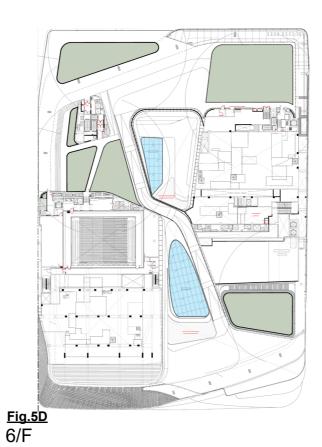

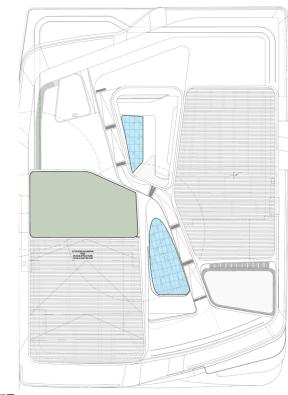



<u>Fig.5E</u> 7/F & Roof

Figure 5




## P32 - Artist Hostel/ Residence & Pocket Park Landscape Design

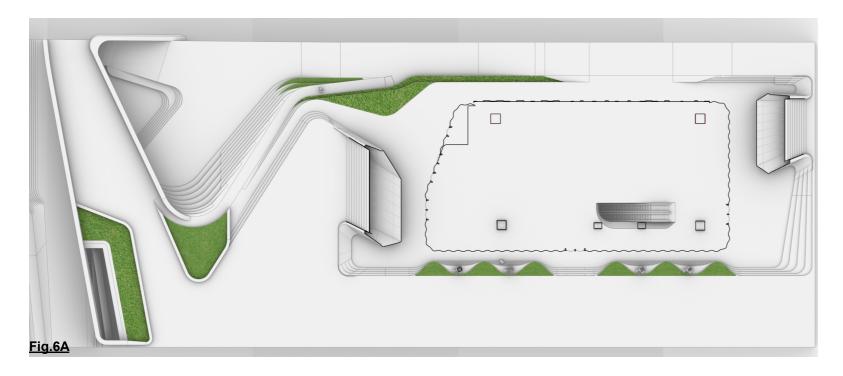


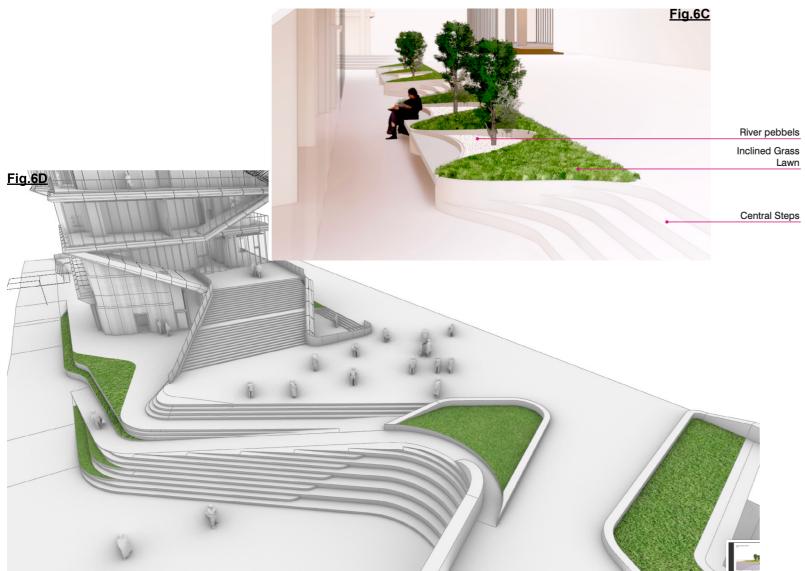





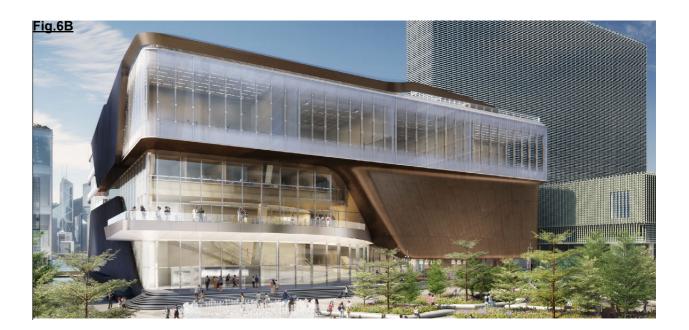

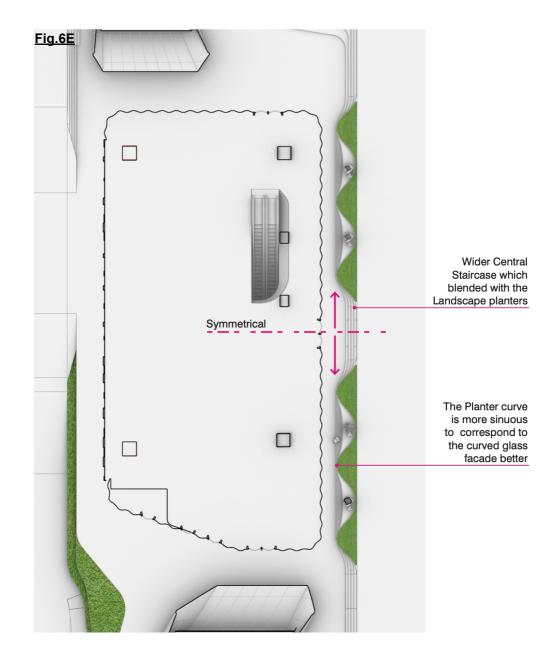

## **Tree & Shrub Planting**

Tree Planting



# **Tree & Shrub Planting**

# Shrubs/ Ground Cover Planting G/F



Arachis pintoi 多年生花生



Cuphea hyssopifolia 台灣雪茄花



Ixora chinensis 龍船花







Lantana montevidensis 鋪地臭金鳳



Muhlenbergia filipes 亂子草



Ophiopogon japonicus 沿階草





## **Tree & Shrub Planting**

# Green Roof/ Podium Planting









#### **Material & Furniture**





#### **Material Palette**

Natural granites and artificial granite tiles will be chosen for landscape, including paving tiles, planters finishes, and sitting benches, with earth tune colour palette to create a harmony environment merging with the soft landscape and surrounding natural environment.

- 1. Sustainability in materials and maintenance;
- 2. All materials will be high emissivity with low reflectivity rate
- 3. Slippery resistance with standard R11



